

SHOWN ON THE PLANS AND WHAT IS NOTED IN THE FIELD SHOULD BE

BROUGHT IMMEDIATELY TO THE ATTENTION OF THE ENGINEER.

Utilities Underground Location Center

REASONABLE TIME PRIOR TO THE START


OF CONSTRUCTION.


URISDICTION: MARYSVIL


11 - 15 - 2

BRODIE

THESE APPROVED CONSTRUCTION PLANS EXPIRE AFTER PERIOD OF 60 MONTHS FROM THE DATE SHOWN ABOVE OR UPON EXPIRATION OF PRELIMINARY PLAT OR SITE PLAN APPROVAL. PER MMC 15.09.080

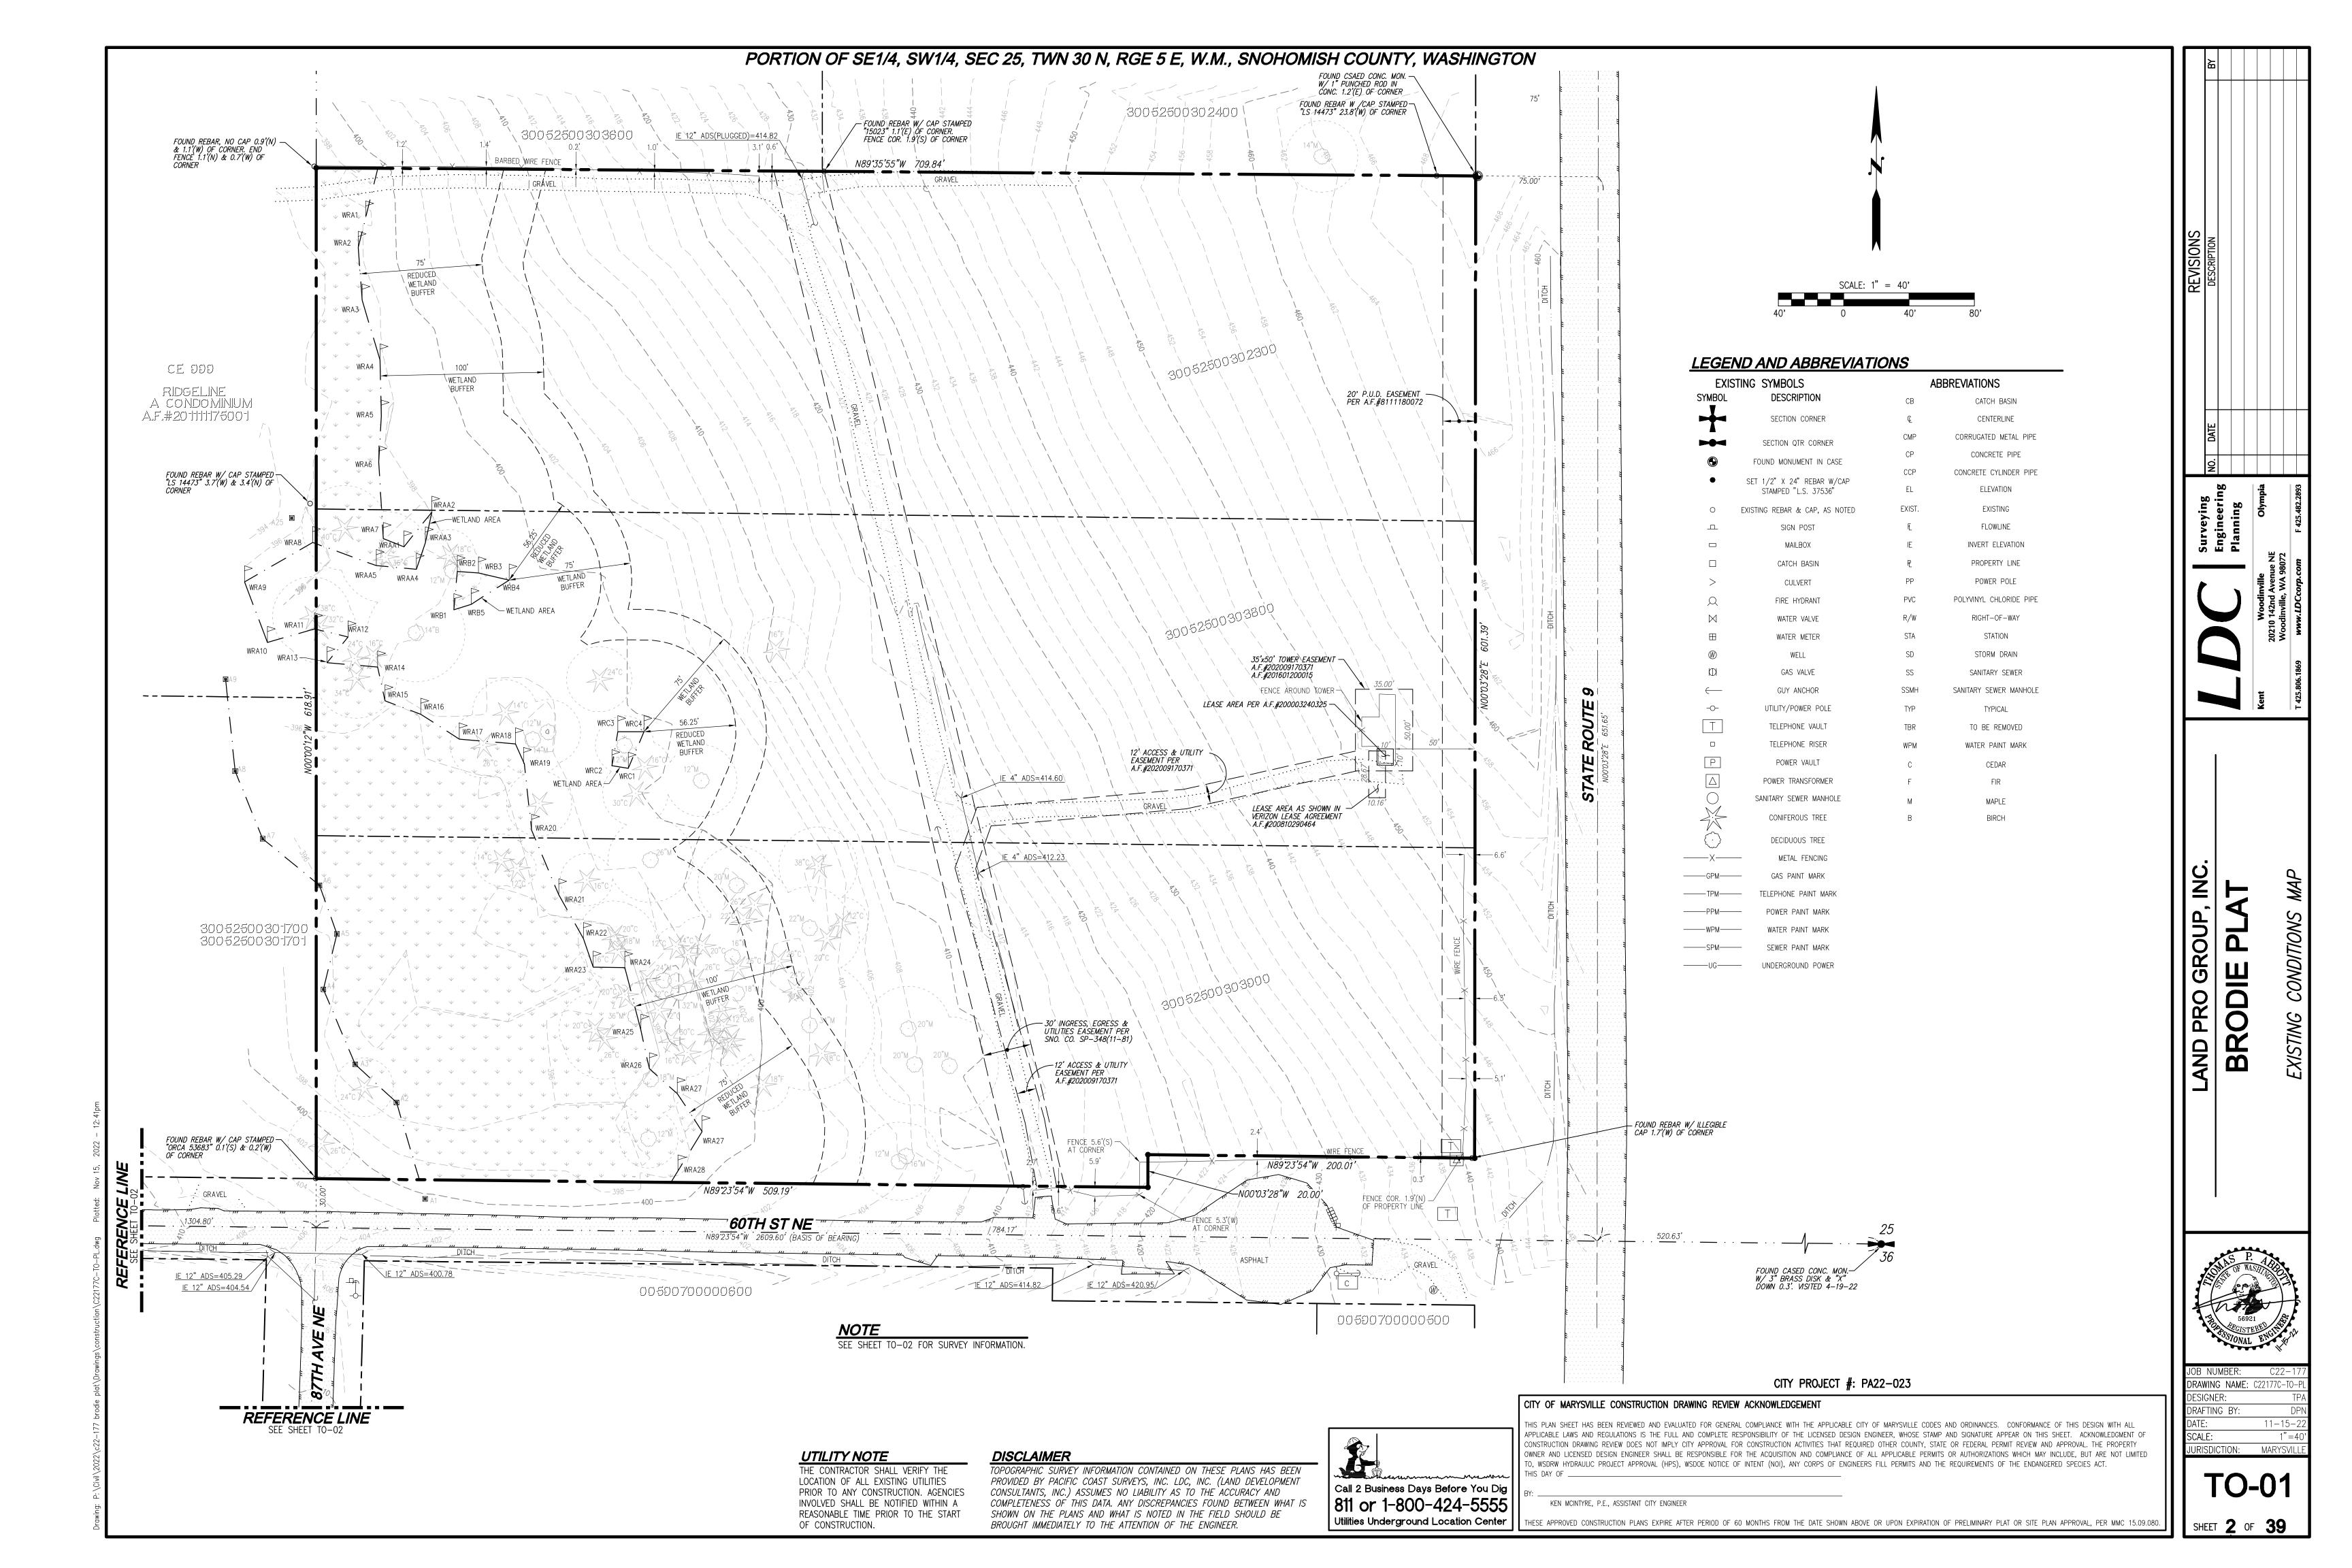

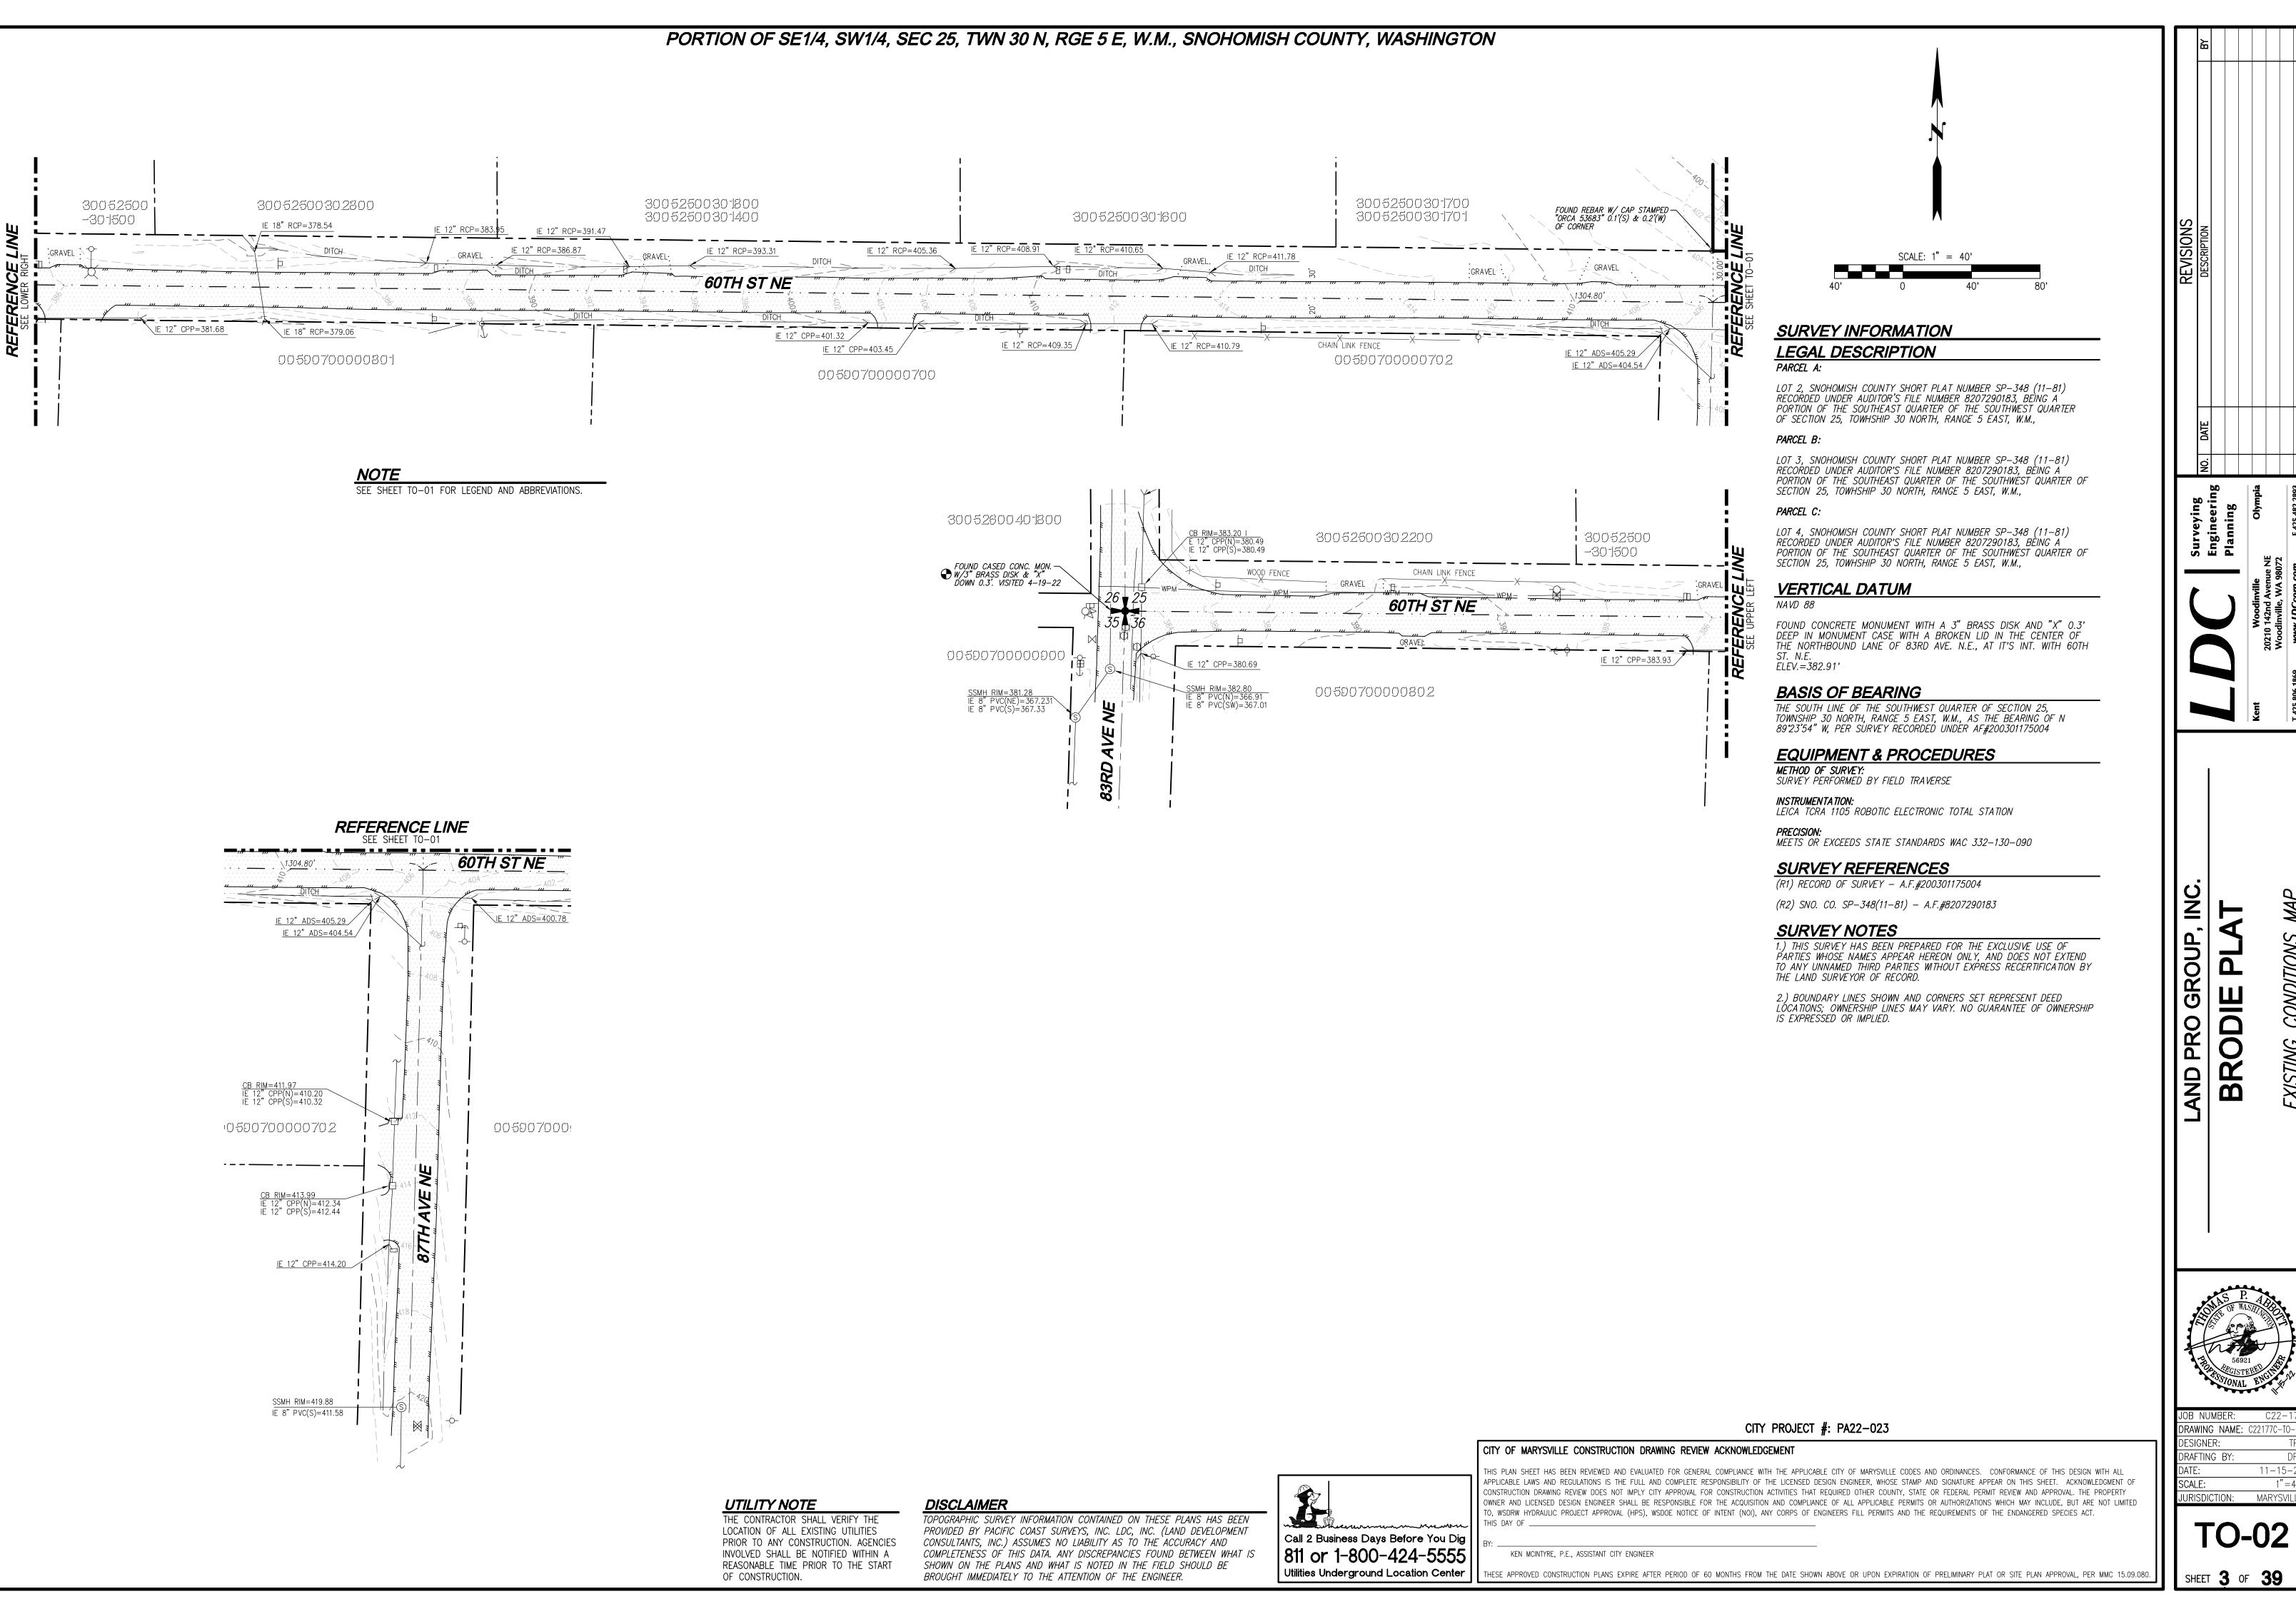

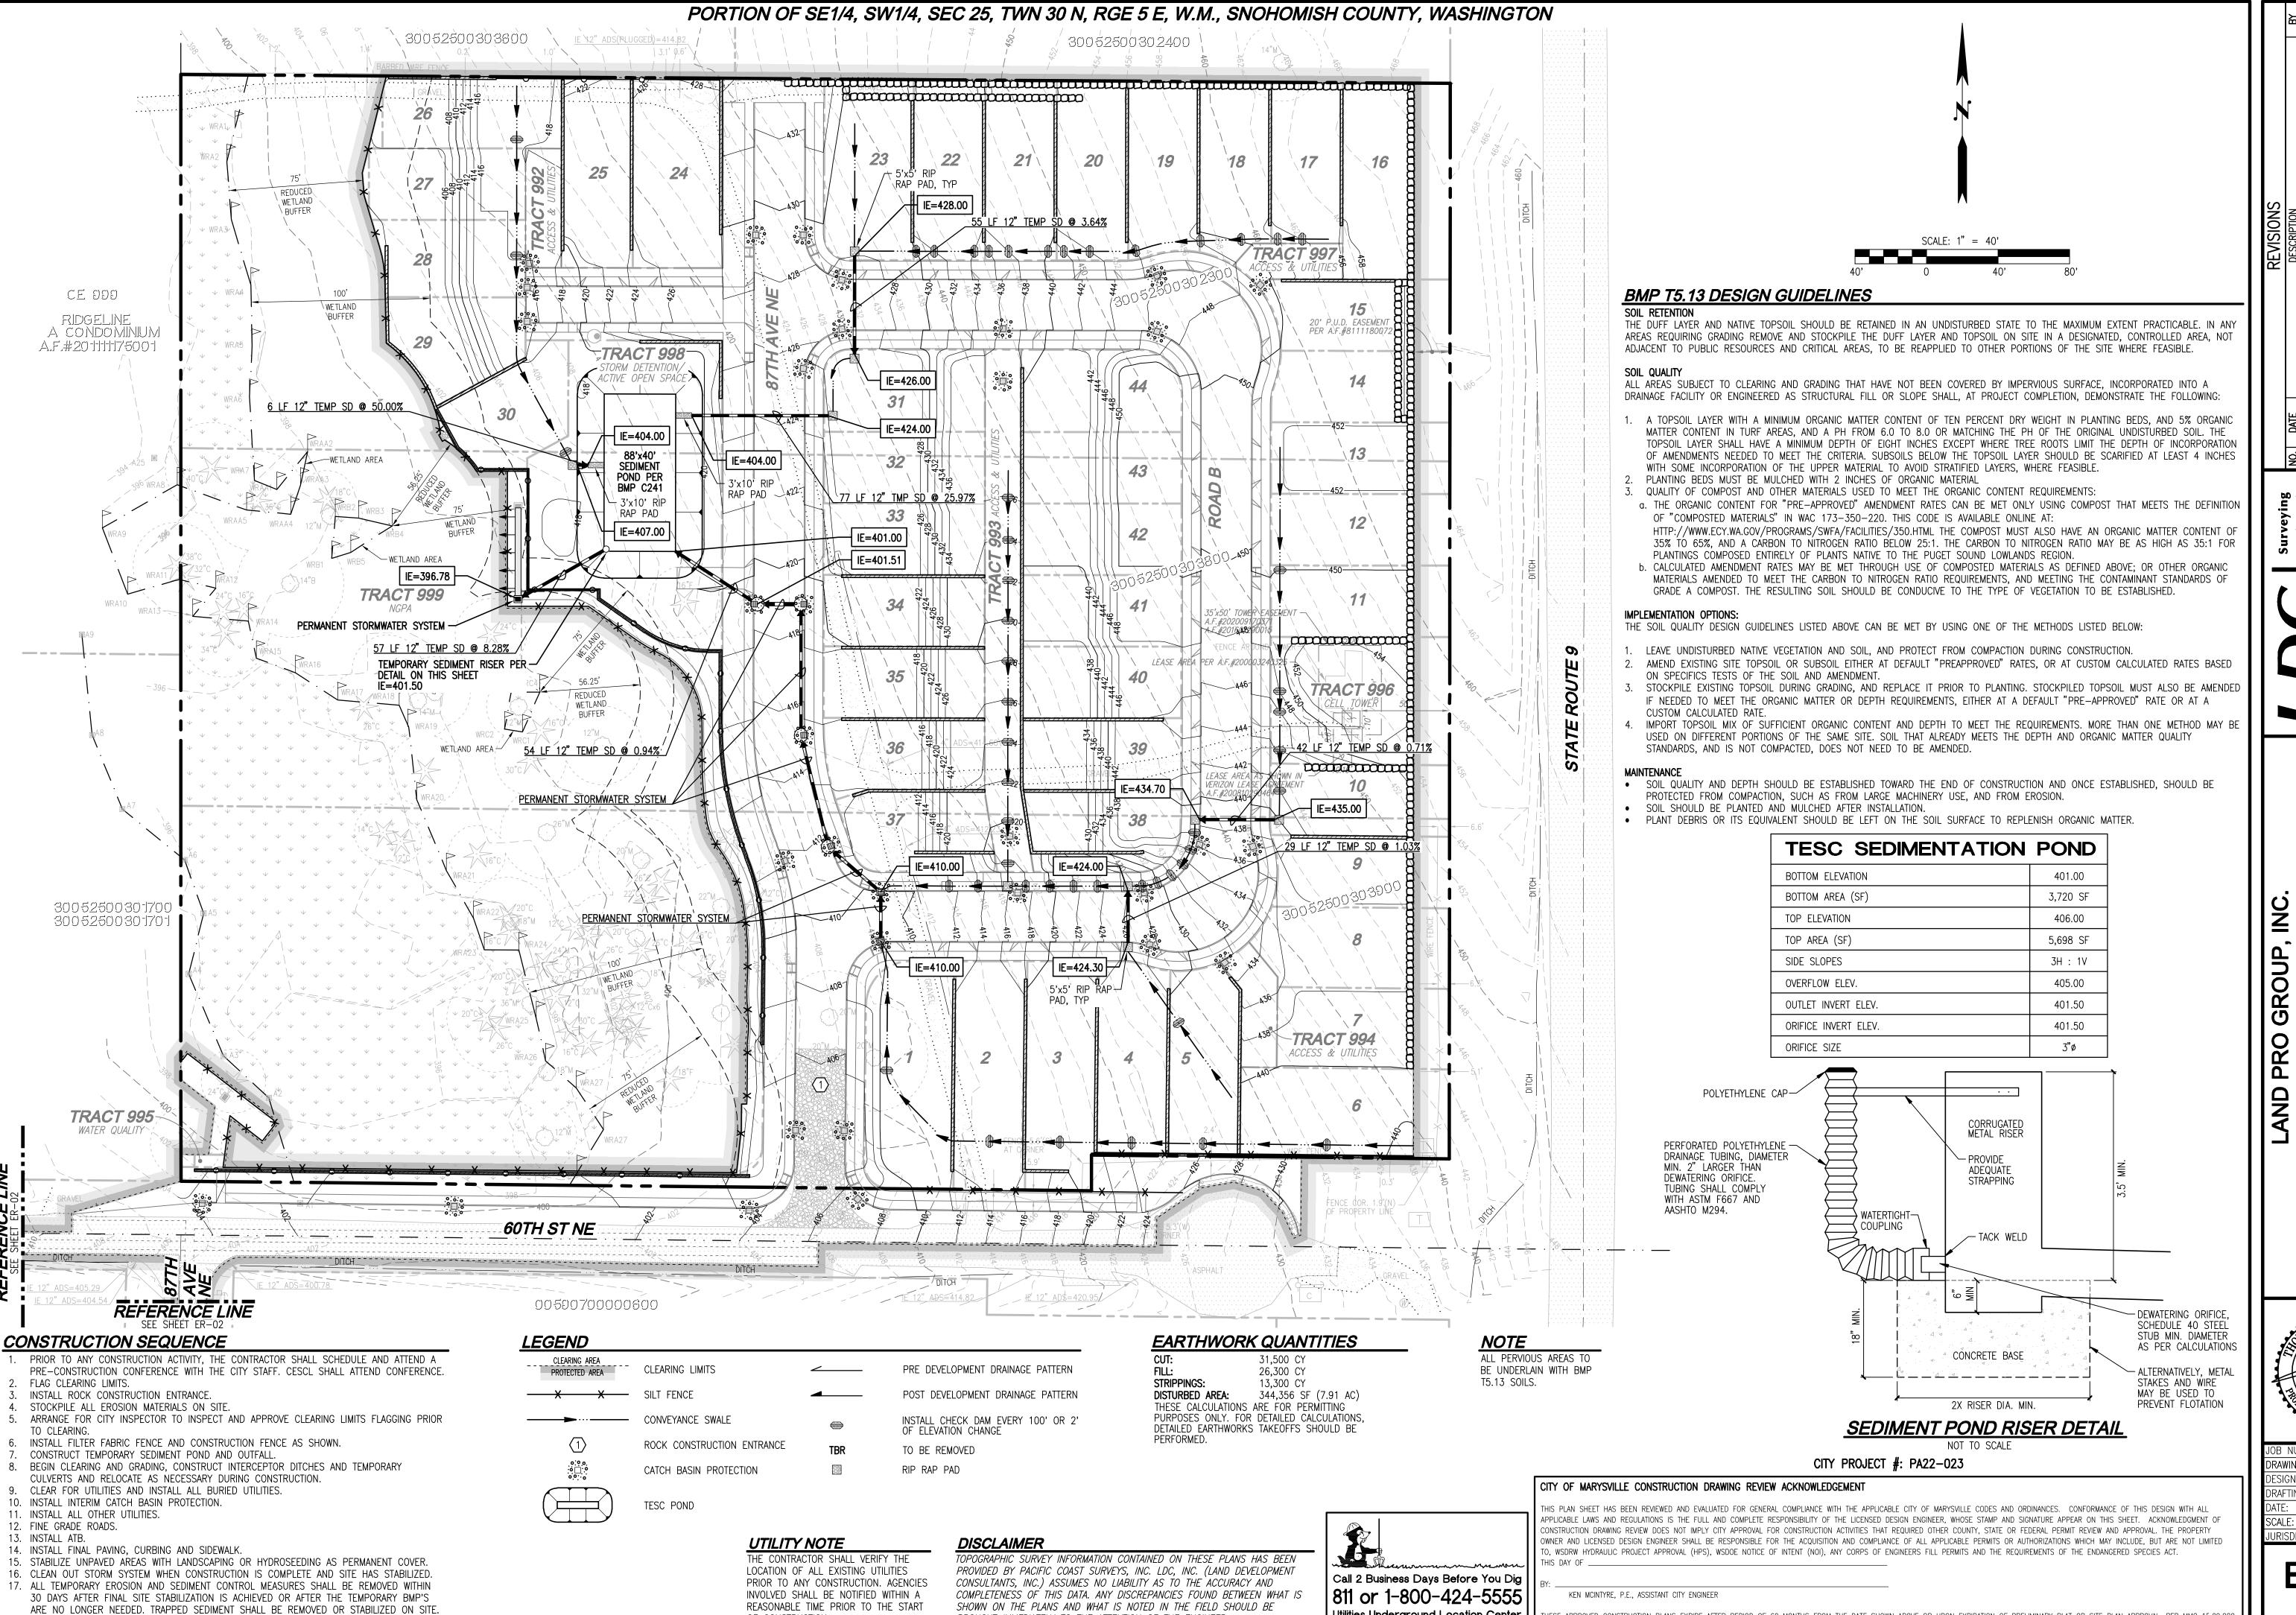

BROUGHT IMMEDIATELY TO THE ATTENTION OF THE ENGINEER.

OF CONSTRUCTION.

DISTURBED SOIL AREAS RESULTING FROM REMOVAL SHALL BE PERMANENTLY STABILIZED.


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JOB NUMBER:	C22-177
DRAWING NAME:	C22177C-ER-PL
DESIGNER:	TPA
DRAFTING BY:	DPN
DATE:	11-15-22
SCALE:	1"=40
JURISDICTION:	MARYSVILLE

ER-01

THESE APPROVED CONSTRUCTION PLANS EXPIRE AFTER PERIOD OF 60 MONTHS FROM THE DATE SHOWN ABOVE OR UPON EXPIRATION OF PRELIMINARY PLAT OR SITE PLAN APPROVAL, PER MMC 15.09.080.



TOPOGRAPHIC SURVEY INFORMATION CONTAINED ON THESE PLANS HAS BEEN

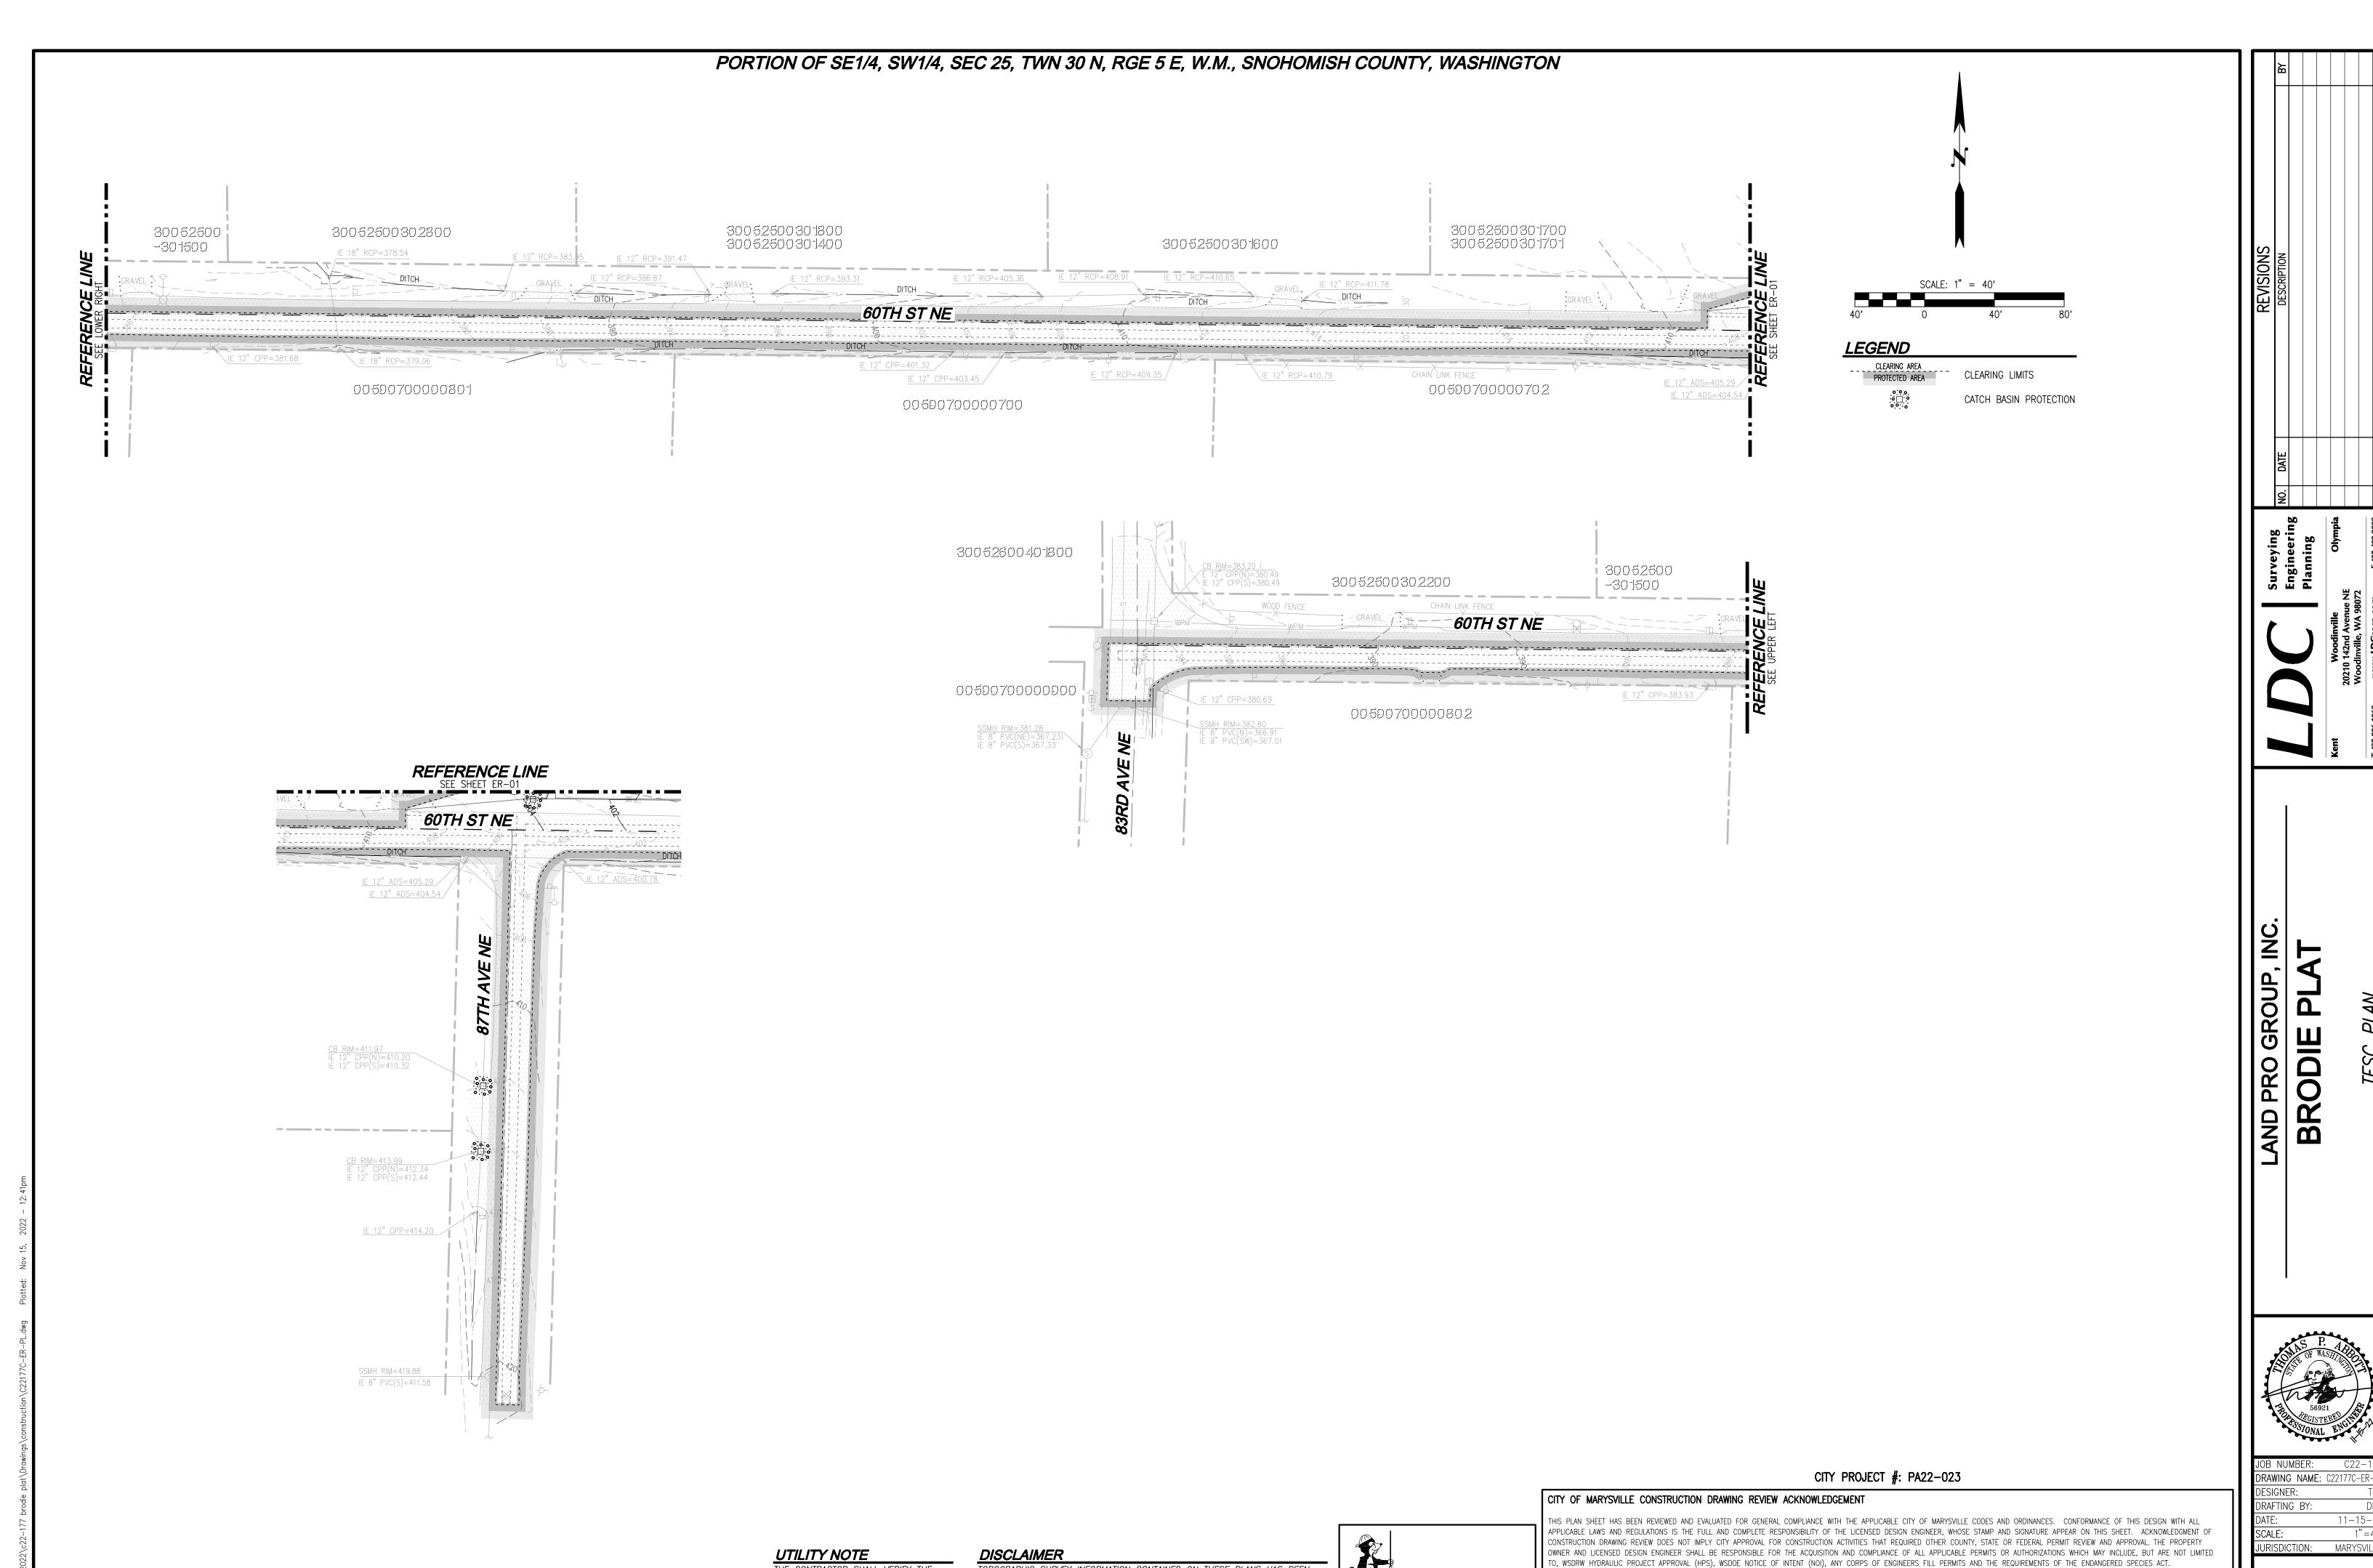PROVIDED BY PACIFIC COAST SURVEYS, INC. LDC, INC. (LAND DEVELOPMENT

COMPLETENESS OF THIS DATA. ANY DISCREPANCIES FOUND BETWEEN WHAT IS

CONSULTANTS, INC.) ASSUMES NO LIABILITY AS TO THE ACCURACY AND

SHOWN ON THE PLANS AND WHAT IS NOTED IN THE FIELD SHOULD BE

BROUGHT IMMEDIATELY TO THE ATTENTION OF THE ENGINEER.

Call 2 Business Days Before You Dig

811 or 1-800-424-5555

Utilities Underground Location Center

KEN MCINTYRE, P.E., ASSISTANT CITY ENGINEER

THESE APPROVED CONSTRUCTION PLANS EXPIRE AFTER PERIOD OF 60 MONTHS FROM THE DATE SHOWN ABOVE OR UPON EXPIRATION OF PRELIMINARY PLAT OR SITE PLAN APPROVAL, PER MMC 15.09.080.

THE CONTRACTOR SHALL VERIFY THE

PRIOR TO ANY CONSTRUCTION. AGENCIES

INVOLVED SHALL BE NOTIFIED WITHIN A

REASONABLE TIME PRIOR TO THE START

OF CONSTRUCTION.

LOCATION OF ALL EXISTING UTILITIES

IURISDICTION: MARYSVILL **ER-02**

11-15-2

GENERAL NOTES

- ALL WORK IN CITY RIGHT-OF-WAY REQUIRES A PERMIT FROM THE CITY OF MARYSVILLE. PRIOR TO ANY WORK COMMENCING. THE GENERAL CONTRACTOR SHALL ARRANGE FOR A PRECONSTRUCTION MEETING AT THE DEVELOPMENT SERVICES CENTER TO BE ATTENDED BY ALL CONTRACTORS THAT WILL PERFORM WORK SHOWN ON THE APPROVED ENGINEERING PLANS. REPRESENTATIVES FROM ALL APPLICABLE UTILITY COMPANIES, THE PROJECT OWNER AND APPROPRIATE CITY STAFF. CONTACT DEVELOPMENT SERVICES AT (360-363-8100) TO SCHEDULE THE MEETING. THE CONTRACTOR IS RESPONSIBLE TO HAVE THEIR OWN SET OF APPROVED PLANS AT THE MEETING.
- AFTER COMPLETION OF ALL ITEMS SHOWN ON THESE PLANS AND BEFORE ACCEPTANCE OF THE PROJECT THE CONTRACTOR SHALL OBTAIN A "PUNCH LIST" PREPARED BY THE CITY'S INSPECTOR DETAILING REMAINING ITEMS OF WORK TO BE COMPLETED. ALL ITEMS OF WORK SHOWN ON THESE PLANS SHALL BE COMPLETED TO THE SATISFACTION OF THE CITY PRIOR TO ACCEPTANCE OF THE WATER, SANITARY SEWER AND STORM SYSTEMS
- ALL MATERIALS AND WORKMANSHIP SHALL CONFORM TO THE STANDARD SPECIFICATIONS FOR ROAD, BRIDGE, AND MUNICIPAL CONSTRUCTION (HEREINAFTER REFERRED TO AS THE "STANDARD SPECIFICATIONS"). WASHINGTON STATE DEPARTMENT OF TRANSPORTATION AND AMERICAN PUBLIC WORKS ASSOCIATION, WASHINGTON STATE CHAPTER, LATEST EDITION, UNLESS SUPERSEDED OR AMENDED BY THE CITY OF MARYSVILLE CITY ENGINEERING DESIGN AND
- DEVELOPMENT STANDARDS (HEREINAFTER REFERRED TO AS THE "CITY STANDARDS") 4. ALL WORK WITHIN THE DEVELOPMENT AND CITY RIGHT-OF-WAY SHALL BE SUBJECT TO THE INSPECTION OF THE CITY ENGINEER OR DESIGNATED REPRESENTATIVE.
- PRIOR TO ANY SITE CONSTRUCTION INCLUDING CLEARING/LOGGING OR GRADING. THE SITE CLEARING LIMITS SHALL BE LOCATED AND FIELD IDENTIFIED BY THE PROJECT SURVEYOR (OR PROJECT ENGINEER) AS REQUIRED BY THESE PLANS. THE PROJECT SURVEYOR'S NAME AND PHONE NUMBER IS DARREN RIDDLE, (425) 512-7099.
- THE DEVELOPER, CONTRACTOR AND PROJECT ENGINEER IS RESPONSIBLE FOR WATER QUALITY AS DETERMINED BY THE MONITORING PROGRAM ESTABLISHED BY THE PROJECT ENGINEER. THE PROJECT ENGINEER'S NAME AND PHONE NUMBER IS TOM ABBOTT. (425) 806-1869. 7. THE CONTRACTOR SHALL BE RESPONSIBLE FOR OBTAINING ALL PERMITS FOR UTILITY, ROAD,
- AND RIGHT-OF-WAY CONSTRUCTION. THE CONTRACTOR FOR THIS PROJECT IS TBD. 8. THE CONSTRUCTION STORMWATER POLLUTION PREVENTION PLAN (SWPPP) BEST MANAGEMENT PRACTICES (BMP'S) SHALL BE CONSTRUCTED IN ACCORDANCE WITH THE APPROVED SWPPP PRIOR TO ANY GRADING OR EXTENSIVE LAND CLEARING. THESE FACILITIES MUST BE SATISFACTORILY MAINTAINED UNTIL CONSTRUCTION AND LANDSCAPING IS COMPLETED AND FINAL STABILIZATION HAS OCCURRED. SEDIMENT LADEN WATERS SHALL NOT ENTER THE CITY
- STORMWATER DRAINAGE SYSTEM OR A NATURAL DRAINAGE SYSTEM. 9. THE CONTRACTOR SHALL KEEP TWO SETS OF PLANS ON SITE AT ALL TIMES FOR RECORDING RECORD DRAWING INFORMATION: ONE SET SHALL BE SUBMITTED TO THE PROJECT ENGINEER. AND ONE SET SHALL BE SUBMITTED TO THE CITY ENGINEER AT COMPLETION OF CONSTRUCTION AND PRIOR TO FINAL ACCEPTANCE OF WORK.
- 10. PRIOR TO CONSTRUCTION THE OWNER AND/OR CONTRACTOR SHALL NOTIFY THE PROJECT ENGINEER AND THE CITY ENGINEER WHEN CONFLICTS EXIST BETWEEN THE PLANS AND FIELD CONDITIONS. CONFLICTS SHALL BE RESOLVED (INCLUDING PLAN AND PROFILE REVISIONS) AND RESUBMITTED FOR APPROVAL PRIOR TO PROCEEDING WITH CONSTRUCTION.
- 11. ANY REVISIONS MADE TO THESE PLANS, OR CHANGES TO THE DESIGN MUST BE REVIEWED AND APPROVED BY THE DEVELOPER'S ENGINEER AND THE CITY PRIOR TO ANY IMPLEMENTATION IN THE FIELD. THE CITY SHALL NOT BE RESPONSIBLE FOR ANY ERRORS AND/OR OMISSIONS ON THESE PLANS.
- 12. THE CONTRACTOR SHALL HAVE ALL UTILITIES VERIFIED ON THE GROUND PRIOR TO ANY CONSTRUCTION. CALL (811) AT LEAST TWO WORKING DAYS IN ADVANCE. PRIOR TO CONSTRUCTION THE OWNER AND/OR CONTRACTOR SHALL NOTIFY THE PROJECT ENGINEER AND THE CITY ENGINEER WHEN CONFLICTS EXIST BETWEEN THE PLANS AND FIELD CONDITIONS. CONFLICTS SHALL BE RESOLVED (INCLUDING PLAN AND PROFILE REVISIONS) AND RESUBMITTED FOR APPROVAL PRIOR TO PROCEEDING WITH CONSTRUCTION.
- 13. CITY OF MARYSVILLE HORIZONTAL DATUM SHALL BE NAD 83, AND THE VERTICAL DATUM SHALL BE NAVD 88. IN WASHINGTON STATE PLANE COORDINATES (FEET), WASHINGTON NORTH ZONE 4601. A LIST OF BENCHMARKS IS AVAILABLE THROUGH THE PUBLIC WORKS DEPARTMENT.
- 14. TEMPORARY STREET PATCHING SHALL BE ALLOWED FOR AS APPROVED BY THE CITY ENGINEER. TEMPORARY STREET PATCHING SHALL BE PROVIDED BY PLACEMENT AND COMPACTION OF ATB OR CLASS B ASPHALT CONCRETE. CONTRACTOR SHALL BE RESPONSIBLE FOR MAINTENANCE AS REQUIRED.
- 15. PROVIDE TRAFFIC CONTROL PLAN(S) IN ACCORDANCE WITH THE MANUAL ON UNIFORM TRAFFIC CONTROL DEVICES (MUTCD) AS REQUIRED.
- 16. IT SHALL BE THE RESPONSIBILITY OF THE CONTRACTOR TO HAVE A COPY OF THESE APPROVED PLANS ON CONSTRUCTION SITE AT ALL TIMES.
- 17. ANY STRUCTURE AND/OR OBSTRUCTION THAT REQUIRES REMOVAL OR RELOCATION RELATING
- TO THIS PROJECT SHALL BE DONE SO AT THE DEVELOPER'S EXPENSE. 18. LOCATIONS OF EXISTING UTILITIES ARE APPROXIMATE. IT SHALL BE THE CONTRACTOR'S RESPONSIBILITY TO DETERMINE THE TRUE ELEVATIONS AND LOCATIONS OF HIDDEN UTILITIES. ALL VISIBLE ITEMS SHALL BE THE ENGINEER'S RESPONSIBILITY. LOCATION OF UTILITIES SHOWN ON CONSTRUCTION PLANS ARE BASED ON BEST RECORDS AVAILABLE AND ARE SUBJECT TO
- VARIATION. FOR ASSISTANCE IN UTILITY LOCATION, CALL 1-800-424-5555. 19. THE CONTRACTOR SHALL INSTALL, REPLACE, OR RELOCATE ALL SIGNS, AS SHOWN ON THE PLANS OR AS AFFECTED BY CONSTRUCTION, PER CITY STANDARDS.
- 20. POWER, STREET LIGHT, CABLE, AND TELEPHONE LINES SHALL BE IN A TRENCH LOCATED WITHIN A 10-FOOT UTILITY EASEMENT ADJACENT TO PUBLIC RIGHT-OF-WAY. RIGHT-OF-WAY CROSSINGS SHALL HAVE A MINIMUM HORIZONTAL SEPARATION FROM OTHER UTILITIES (SEWER, WATER, AND STORM) OF 5 FEET.
- 21. ALL CONSTRUCTION SURVEYING FOR EXTENSIONS OF PUBLIC FACILITIES SHALL BE DONE UNDER THE DIRECTION OF A WASHINGTON STATE LICENSED LAND SURVEYOR OR A WASHINGTON STATE LICENSED PROFESSIONAL CIVIL ENGINEER.
- 22. DURING CONSTRUCTION, ALL PUBLIC STREETS ADJACENT TO THIS PROJECT SHALL BE KEPT CLEAN OF ALL MATERIAL DEPOSITS RESULTING FROM ON-SITE CONSTRUCTION, AND EXISTING STRUCTURES SHALL BE PROTECTED AS DIRECTED BY THE CITY.
- 23. CERTIFIED RECORD DRAWINGS ARE REQUIRED PRIOR TO PROJECT ACCEPTANCE. 24. A NPDES STORMWATER GENERAL PERMIT MAY BE REQUIRED BY THE DEPARTMENT OF ECOLOGY FOR THIS PROJECT. FOR INFORMATION VISIT THE DEPARTMENT OF ECOLOGY WEB SITE WWW.ECY.WA.GOV/PROGRAMS/WQ/STORMWATER/CONSTRUCTION/
- 25. ANY DISTURBANCE OR DAMAGE TO CRITICAL AREAS AND ASSOCIATED BUFFERS. OR SIGNIFICANT TREES DESIGNATED FOR PRESERVATION AND PROTECTION SHALL BE MITIGATED IN ACCORDANCE WITH A MITIGATION PLAN REVIEWED AND APPROVED BY THE CITY'S PLANNING DIVISION. PREPARATION AND IMPLEMENTATION OF THE MITIGATION PLAN SHALL BE AT THE DEVELOPER'S EXPENSE.
- 26. A GRADING PERMIT ISSUED PURSUANT TO THE CURRENT ADOPTED INTERNATIONAL BUILDING CODE, AND APPROVAL OF THE TEMPORARY EROSION AND SEDIMENTATION CONTROL PLAN SHALL BE OBTAINED FROM THE COMMUNITY DEVELOPMENT DEPARTMENT PRIOR TO ANY ON-SITE GRADING WORK NOT EXPRESSLY EXEMPT BY THE CURRENT ADOPTED INTERNATIONAL BUILDING CODE.
- 27. PRIOR TO COMMENCEMENT OF FRAMING, FINAL DRAINAGE INSPECTION AND APPROVAL OF THE ROOF LEADER AND POSITIVE FOOTING SYSTEMS SHALL BE COMPLETED BY THE BUILDING DEPARTMENT. CALL 360-363-8100 TO SCHEDULE THE INSPECTION.
- 28. ALL POWER LINES, TELEPHONE WIRES, TELEVISION CABLES, FIRE ALARM SYSTEMS AND OTHER COMMUNICATION WIRES, CABLES OR LINE SHALL BE PLACED UNDERGROUND EITHER BY DIRECT BURIAL OR BY MEANS OF CONDUIT OR DUCTS PROVIDING SERVICE TO EACH BUILDING.
- 29. TO PROVIDE THE BEST PROTECTION FOR SIGNIFICANT TREES DURING THE CONSTRUCTION STAGE. THERE SHALL BE INSTALLED A TEMPORARY, FIVE-FOOT HIGH, ORANGE CLEARING LIMITS CONSTRUCTION FENCE IN A LINE GENERALLY CORRESPONDING TO THE DRIP LINE OF ANY SIGNIFICANT TREE(S) TO BE RETAINED. NO CONSTRUCTION WILL BE PERMITTED WITHIN THE DRIPLINE OF TREES IDENTIFIED TO BE SAVED. ALL SUCH FENCING SHALL BE INSTALLED AND INSPECTED BY THE COMMUNITY DEVELOPMENT DEPARTMENT PRIOR TO COMMENCEMENT OF SITE
- 30. IF AT ANY TIME DURING CONSTRUCTION ARCHAEOLOGICAL RESOURCES ARE OBSERVED ON THE PROJECT SITE, WORK SHALL BE TEMPORARILY SUSPENDED AT THE LOCATION OF DISCOVERY AND A PROFESSIONAL ARCHAEOLOGIST SHOULD DOCUMENT AND ASSESS THE DISCOVERY. THE DEPARTMENT OF ARCHAEOLOGY AND HISTORIC PRESERVATION (DAHP) AND ALL CONCERNED TRIBES MUST BE CONTACTED FOR ANY ISSUES INVOLVING NATIVE AMERICAN SITES. IF PROJECT ACTIVITIES EXPOSE HUMAN REMAINS. EITHER IN THE FORM OF BURIALS OR ISOLATED BONES OR TEETH, OR OTHER MORTUARY ITEMS, WORK IN THAT AREA MUST BE STOPPED IMMEDIATELY. LOCAL LAW ENFORCEMENT, DAHP, AND AFFECTED TRIBES MUST BE IMMEDIATELY CONTACTED. NO ADDITIONAL EXCAVATION MAY BE UNDERTAKEN UNTIL A PROCESS HAS BEEN AGREED UPON BY THESE PARTIES, AND NO EXPOSED HUMAN REMAINS MAY BE LEFT UNATTENDED.

GENERAL NOTES

- ALL LIMITS OF CLEARING AND AREAS OF VEGETATION PRESERVATION AS PRESCRIBED ON THE PLANS SHALL BE CLEARLY FLAGGED IN THE FIELD AND OBSERVED DURING
- 2. ALL REQUIRED SEDIMENTATION AND EROSION CONTROL FACILITIES MUST BE CONSTRUCTED AND IN OPERATION PRIOR TO ANY LAND CLEARING AND/OR OTHER CONSTRUCTION TO ENSURE THAT SEDIMENT LADEN WATER DOES NOT ENTER THE NATURAL DRAINAGE SYSTEM. THE CONTRACTOR SHALL SCHEDULE AN INSPECTION OF THE EROSION CONTROL FACILITIES PRIOR TO ANY LAND CLEARING AND/OR OTHER CONSTRUCTION. ALL EROSION AND SEDIMENT FACILITIES SHALL BE MAINTAINED IN A SATISFACTORY CONDITION AS DETERMINED BY THE CITY, UNTIL SUCH TIME THAT CLEARING AND/OR CONSTRUCTION IS COMPLETED AND FINAL STABILIZATION HAS OCCURRED. THE IMPLEMENTATION, MAINTENANCE, REPLACEMENT, AND ADDITIONS TO THE EROSION AND SEDIMENTATION CONTROL SYSTEMS SHALL BE THE RESPONSIBILITY OF THE PERMITTEE.
- 3. THE EROSION AND SEDIMENTATION CONTROL SYSTEM FACILITIES DEPICTED ON THESE PLANS ARE INTENDED TO BE MINIMUM REQUIREMENTS TO MEET ANTICIPATED SITE CONDITIONS. AS CONSTRUCTION PROGRESSES AND UNEXPECTED OR SEASONAL CONDITIONS DICTATE, FACILITIES WILL BE NECESSARY TO ENSURE COMPLETE SILTATION CONTROL ON THE SITE. DURING THE COURSE OF CONSTRUCTION, IT SHALL BE THE OBLIGATION AND RESPONSIBILITY OF THE PERMITTEE TO ADDRESS ANY NEW CONDITIONS THAT MAY BE CREATED BY HIS ACTIVITIES AND TO PROVIDE ADDITIONAL FACILITIES, OVER AND ABOVE THE MINIMUM REQUIREMENTS, AS MAY BE NEEDED TO PROTECT ADJACENT PROPERTIES, SENSITIVE AREAS, NATURAL WATER COURSES, AND/OR STORM DRAINAGE SYSTEMS.
- 4. APPROVAL OF THESE PLANS IS FOR GRADING, TEMPORARY DRAINAGE, EROSION AND SEDIMENTATION CONTROL ONLY. IT DOES NOT CONSTITUTE AN APPROVAL OF PERMANENT STORM DRAINAGE DESIGN, SIZE OR LOCATION OF PIPES, RESTRICTORS CHANNELS. OR RETENTION FACILITIES.
- 5. ANY DISTURBED AREA WHICH HAS BEEN STRIPPED OF VEGETATION AND WHERE NO FURTHER WORK IS ANTICIPATED FOR THE TIME PERIOD SET FORTH BY THE SWPPP MUST BE IMMEDIATELY STABILIZED WITH MULCHING, GRASS PLANTING, OR OTHER APPROVED EROSION CONTROL TREATMENT APPLICABLE TO THE TIME OF YEAR IN QUESTION. DURING THE DRY SEASON (MAY 1 - SEPTEMBER 30) SOILS MAY BE EXPOSED AND UNWORKED FOR 7 DAYS. DURING THE WET SEASON (OCTOBER 1 APRIL 30) SOILS MAY BE EXPOSED AND UNWORKED FOR 2 DAYS. GRASS SEEDING ALONE WILL BE ACCEPTABLE ONLY DURING THE DRY SEASON. SEEDING MAY PROCEED OUTSIDE THE SPECIFIED TIME PERIOD WHENEVER IT IS IN THE INTEREST OF THE PERMITTEE BUT MUST BE AUGMENTED WITH MULCHING, NETTING, OR OTHER TREATMENT APPROVED BY THE CITY.
- 6. IN CASE EROSION OR SEDIMENTATION OCCURS TO ADJACENT PROPERTIES, ALL CONSTRUCTION WORK WITHIN THE DEVELOPMENT THAT WILL FURTHER AGGRAVATE THE SITUATION MUST CEASE, AND THE OWNER/CONTRACTOR WILL IMMEDIATELY COMMENCE RESTORATION METHODS. RESTORATION ACTIVITY WILL CONTINUE UNTIL SUCH TIME AS THE AFFECTED PROPERTY OWNER IS SATISFIED.
- 7. STOCKPILES ARE TO BE LOCATED IN SAFE AREAS AND ADEQUATELY PROTECTED BY TEMPORARY SEEDING AND MULCHING. HYDROSEEDING IS PREFERRED. NO TEMPORARY OR PERMANENT STOCKPILING OF MATERIALS OR EQUIPMENT SHALL OCCUR WITHIN CRITICAL AREAS OR ASSOCIATED BUFFERS, OR THE CRITICAL ROOT ZONE FOR VEGETATION PROPOSED FOR RETENTION.
- 8. NON COMPLIANCE WITH THE REQUIREMENTS FOR EROSION CONTROLS, WATER QUALITY, AND CLEARING LIMITS MAY RESULT IN REVOCATION OF PROJECT PERMIT, PLAN
- APPROVAL, AND BOND FORECLOSURES. 9. ALL EARTH WORK SHALL BE PERFORMED IN ACCORDANCE WITH CITY STANDARDS. PRECONSTRUCTION SOILS INVESTIGATION MAY BE REQUIRED TO EVALUATE SOILS
- 10. IF CUT AND FILL SLOPES EXCEED A MAXIMUM OF TWO FEET HORIZONTAL TO ONE FOOT VERTICAL, A ROCK OR CONCRETE RETAINING WALL MAY BE REQUIRED. ALL ROCK RETAINING WALLS GREATER THAN FOUR (4) FEET IN HEIGHT ARE TO BE DESIGNED AND CERTIFIED BY A PROFESSIONAL ENGINEER EXPERIENCED IN SOIL
- 11. THE SURFACE OF ALL SLOPES SHALL BE COMPACTED. THIS MAY BE ACCOMPLISHED BY OVER-BUILDING THE SLOPES, THEN CUTTING BACK TO FINAL GRADES: OR BY COMPACTING EACH LIFT AS THE SLOPE IS BEING CONSTRUCTED. ALL SLOPES SHALL BE COMPACTED BY THE END OF EACH WORKING DAY.
- 12. UPON COMPLETION OF WORK, FINAL REPORTS MUST BE SUBMITTED TO THE CITY IN CONFORMANCE WITH THE CURRENT CITY ADOPTED INTERNATIONAL BUILDING CODE.
- 13. A VACUUM SWEEPER IS TO BE ONSITE DURING TIMES OF IMPORTING OR EXPORTING

CONSTRUCTION ENTRANCE NOTES

- THE TEMPORARY CONSTRUCTION ENTRANCE SHOULD BE CLEARED OF ALL VEGETATION, ROOTS, AND OTHER OBJECTIONABLE MATERIAL. ANY DRAINAGE FACILITIES REQUIRED BECAUSE OF WASHING SHOULD BE CONSTRUCTED ACCORDING TO SPECIFICATIONS IN THE PLAN. IF WASH RACKS ARE USED, THEY SHOULD BE INSTALLED ACCORDING TO MANUFACTURES SPECIFICATIONS. 5-46.
- 2. GRAVEL SHALL BE CRUSHED BALLAST ROCK, 8"TO 12"IN DEPTH AND INSTALLED TO THE SPECIFIED DIMENSIONS AT THE ENTRANCE.
- 3. THE GRAVEL BALLAST ROCK SHALL BE 4"TO 8"IN DIAMETER AND PLACED ACROSS THE FULL WIDTH OF THE VEHICULAR INGRESS AND EGRESS AREA. THE LENGTH OF ENTRANCE SHALL BE A MINIMUM OF 100 FEET OR AS SPECIFIED BY THE CITY CONSTRUCTION INSPECTOR OR DESIGNEE.
- 4. IF CONDITIONS ON THE SITE ARE SUCH THAT MOST OF THE MUD IS NOT REMOVED FROM VEHICLE TIRES BY CONTACT WITH THE GRAVEL, THEN THE TIRES MUST BE WASHED BEFORE VEHICLES ENTER ONTO A PUBLIC ROAD. WASH WATER MUST BE CARRIED AWAY FROM ENTRANCE TO A SETTLING AREA TO REMOVE SEDIMENT. A WASH RACK MAY ALSO BE USED TO MAKE WASHING MORE CONVENIENT AND EFFECTIVE.
- 5. THE ENTRANCE SHALL BE MAINTAINED IN A CONDITION WHICH WILL PREVENT TRACKING OR FLOW OF MUD ONTO PUBLIC RIGHTS-OF-WAY. THIS MAY REQUIRE PERIODIC TOP DRESSING WITH 2" STONE, AS CONDITIONS DEMAND, AND REPAIR AND/OR CLEAN OUT ANY STRUCTURES USED TO TRAP SEDIMENT. ALL MATERIALS SPILLED, DROPPED, WASHED OR TRACKED FROM VEHICLES ONTO ROADWAY OR INTO STORM DRAINS MUST BE REMOVED IMMEDIATELY.

HYDROSEEDING GENERAL NOTES

MANAGEMENT MANUAL FOR WESTERN WASHINGTON.

- CONSTRUCTION ACCEPTANCE WILL BE SUBJECT TO A WELL ESTABLISHED GROUND COVER THAT FULFILLS THE REQUIREMENTS OF THE APPROVED CONSTRUCTION PLANS AND CITY OF MARYSVILLE STANDARDS.
- 2. ALL DISTURBED AREAS SUCH AS RETENTION FACILITIES, ROADWAY BACKSLOPES, ETC., SHALL BE SEEDED WITH A PERENNIAL GROUND COVER GRASS TO MINIMIZE EROSION. GRASS SEEDING WILL BE DONE USING AN APPROVED HYDROSEEDER OR AS OTHERWISE APPROVED BY THE CITY OF MARYSVILLE. 3. PREPARATION OF SURFACE: ALL AREAS TO BE SEEDED SHALL BE CULTIVATED TO THE
- SATISFACTION OF THE CITY INSPECTOR. THIS MAY BE ACCOMPLISHED BY DISKING, RAKING, HARROWING, OR OTHER ACCEPTABLE MEANS. 4. IMMEDIATELY FOLLOWING FINISH GRADING PERMANENT VEGETATION SHALL BE APPLIED CONSISTENT WITH THE DESIGN AND MAINTENANCE STANDARDS FOR TEMPORARY AND PERMANENT SEEDING IN THE CITY ADOPTED DEPARTMENT OF ECOLOGY STORMWATER
- 5. ALL HYDROSEEDING FIRMS SHALL HAVE A PRINTOUT OF THE APPLICATION RATE FOR EACH JOB READILY AVAILABLE FOR INSPECTION BY THE CONSTRUCTION INSPECTION DIVISION OF COMMUNITY DEVELOPMENT.
- 6. THE CITY OF MARYSVILLE CONSTRUCTION INSPECTION DIVISION OF COMMUNITY DEVELOPMENT SHALL BE NOTIFIED OF POTENTIAL HYDROSEEDING PRIOR TO THE COMMENCEMENT OF SAME TO ENSURE COMPLIANCE OF THESE SPECIFICATIONS.

THE CESCL IS RESPONSIBLE FOR:

- A. INSPECTING THE CONSTRUCTION SITE TO ENSURE THAT ALL CONSTRUCTION SWPPP MEASURES ARE FUNCTIONING AS INTENDED. B. ALLOCATING RESOURCES TO REPAIR ALL EROSION CONTROL STRUCTURES THAT ARE IN NEED OF MAINTENANCE C. MONITORING WATER QUALITY FOR ANY STORM DRAINAGE THAT LEAVES THE SITE.
- D. STOPPING AND/OR REDIRECTING CONSTRUCTION ACTIVITIES DEEMED NECESSARY TO PROTECT THE ENVIRONMENT

SHOULD BMP PERFORMANCE GOALS NOT BE ACHIEVED, THE ONLY CONSTRUCTION ACTIVITIES THAT SHALL BE ALLOWED ARE THE REPAIR OF EXISTING EROSION CONTROL STRUCTURES, INSTALLATION OF ADDITIONAL BMP'S TO MINIMIZE THE TRANSPORT OF SEDIMENT OFFSITE, OR THOSE ACTIVITIES THAT DO NOT DISTURB EXPOSED EARTH AND DO NOT HAVE THE POTENTIAL TO GENERATE ADDITIONAL SEDIMENT.

THE THIRTEEN ELEMENTS OF A CONSTRUCTION SWPPP:

- THE BMPS REFERENCED BELOW ARE PER THE 2012 STORMWATER MANAGEMENT MANUAL FOR WESTERN WASHINGTON.
- MARK CLEARING LIMITS: THE CLEARING LIMITS ARE INDICATED ON THE PLAN SHEET. CLEARING AND GRADING WILL BE LIMITED TO ONLY AREAS THAT NEED TO BE DISTURBED FOR GRADING, AND PLACING OR STOCK PILING FILL AND TO PRESERVE AS MUCH NATURAL VEGETATION AND THE DUFF LAYER AS POSSIBLE. FIELD MARKING THE CLEARING LIMITS SHALL BE COMPLETED PRIOR TO ANY CLEARING OR DISTURBING THE SITE.
 - HIGH VISIBILITY PLASTIC OR METAL FENCE SILT FENCE
- 2. ESTABLISH CONSTRUCTION ACCESS: ACCESS TO THE CONSTRUCTION SITE SHALL BE LIMITED TO THE ROCK CONSTRUCTION ENTRANCES. C105 STABILIZED CONSTRUCTION ENTRANCE
- 3. CONTROL FLOW RATES: SILT FENCING WILL BE USED TO CONTROL CONSTRUCTION STORMWATER RUNOFF.
- C233 SILT FENCE 4. INSTALL SEDIMENT CONTROLS: SEDIMENT CONTROL WILL BE PROVIDED THROUGH SILT FENCING.
- C233
- STABILIZE SOILS: TEMPORARY AND PERMANENT SOIL STABILIZATION WILL BE PROVIDED. TEMPORARY STABILIZATION WILL BE PROVIDED TO EXPOSED WORKED EARTH. FROM OCTOBER 1 UNTIL APRIL 30, NO EXPOSED SOIL MAY REMAIN EXPOSED AND UNWORKED FOR MORE THAN TWO DAYS; FROM MAY 1 UNTIL SEPTEMBER 30, NO EXPOSED SOIL MAY REMAIN EXPOSED AND UNWORKED FOR MORE THAN SEVEN DAYS.
 - C120 TEMPORARY AND PERMANENT SEEDING
 - MULCHING PLASTIC COVERING
- 6. PROTECT SLOPES: SLOPES SHALL BE PROTECTED FROM EROSION THROUGH COVER AND SOIL STABILIZATION.
- C120 TEMPORARY AND PERMANENT SEEDING
- C121 MULCHING C123 PLASTIC COVERING
- 7. PROTECT DRAIN INLETS: INLETS ARE TO RECEIVE INLET PROTECTION
- STORM DRAIN INLET PROTECTION

CONCRETE HANDLING

- 8. STABILIZE CHANNELS AND OUTLETS: THERE IS NO NEED FOR CHANNELS OR CHECK DAMS DUE TO BOTH THE INFILTRATED SOILS ONSITE AND THE LACK OF GRADE ACROSS THE SITE.
- 9. CONTROL POLLUTANTS: POLLUTANTS SHALL BE CONTROLLED PER POLLUTANT CONTROL NOTES. SEE THIS SHEET FOR NOTES.
- 10. CONTROL DE-WATERING: DISPOSAL OPTIONS FOR DE-WATERING WATER ARE AS SPECIFIED IN THE DE-WATERING CONTROL NOTES. SEE THIS SHEET FOR NOTES. IN ADDITION, THE FOLLOWING BMP TO BE USED FOR SEDIMENT TRAPPING AND TURBIDITY REDUCTION INCLUDE:
- 11. MAINTAIN BMPS: MAINTENANCE OF THE BMPS IS SPECIFIED IN THE CONSTRUCTION SEQUENCE AND GRADING AND EROSION CONTROL NOTES, SEE SHEET ER-01 AND THIS SHEET.
- 12. PROJECT MANAGEMENT: THE GRADING AND EROSION CONTROL NOTES SPECIFY SEASONAL WORK LIMITATIONS. BMPS SHALL BE MAINTAINED PER ELEMENT #11.
- 13. NO LID BMPS ARE PROPOSED WITH THE CURRENT PLAN DESIGN.

POLLUTANT CONTROL NOTES

- 1. ALL POLLUTANTS, INCLUDING WASTE MATERIALS AND DEMOLITION DEBRIS, THAT OCCUR ON-SITE SHALL BE HANDLED AND DISPOSED OF IN A MANNER THAT DOES NOT CAUSE CONTAMINATION OF STORMWATER. WOODY DEBRIS MAY BE CHOPPED AND SPREAD ON SITE.
- COVER, CONTAINMENT AND PROTECTION FROM VANDALISM SHALL BE PROVIDED FOR ALL CHEMICALS, LIQUID PRODUCTS, PETROLEUM PRODUCTS, AND NON-INERT WASTES PRESENT ON THE SITE (SEE CHAPTER 173-304 WAC FOR THE DEFINITION OF INERT WASTE).
- ON-SITE FUELING TANKS SHALL INCLUDE SECONDARY CONTAINMENT.
- ALL MAINTENANCE OF HEAVY EQUIPMENT AND VEHICLES SHALL BE DONE OFFSITE. 4. ACTIVITIES WHICH MAY RESULT IN DISCHARGE OR SPILLAGE OF POLLUTANTS TO THE GROUND OR INTO STORMWATER RUNOFF MUST BE CONDUCTED USING SPILL PREVENTION MEASURES, SUCH AS DRIP PANS. CONTAMINATED SURFACES SHALL BE CLEANED IMMEDIATELY FOLLOWING ANY DISCHARGE OR SPILL INCIDENT. EMERGENCY REPAIRS MAY BE PERFORMED ON-SITE USING TEMPORARY PLASTIC PLACED
- BENEATH AND, IF RAINING, OVER THE VEHICLE 5. WHEEL WASH OR TIRE BATH WASTEWATER SHALL BE DISCHARGED TO A SEPARATE ON-SITE TREATMENT SYSTEM OR TO THE SANITARY
- 6. APPLICATION OF AGRICULTURAL CHEMICALS, INCLUDING FERTILIZERS AND PESTICIDES, SHALL BE CONDUCTED IN A MANNER AND AT APPLICATION RATES THAT WILL NOT RESULT IN LOSS OF CHEMICAL TO STORMWATER RUNOFF. MANUFACTURERS' RECOMMENDATIONS FOR
- APPLICATION RATES AND PROCEDURES SHALL BE FOLLOWED BMPS SHALL BE USED TO PREVENT OR TREAT CONTAMINATION OF STORMWATER RUNOFF BY PH MODIFYING SOURCES. THESE SOURCES INCLUDE, BUT ARE NOT LIMITED TO, BULK CEMENT, CEMENT KILN DUST, FLY ASH, NEW CONCRETE WASHING AND CURING WATERS, WASTE STREAMS GENERATED FROM CONCRETE GRINDING AND SAWING, EXPOSED AGGREGATE PROCESSES, AND CONCRETE PUMPING AND MIXER WASHOUT WATERS. STORMWATER DISCHARGES SHALL NOT CAUSE OR CONTRIBUTE TO A VIOLATION OF THE WATER QUALITY STANDARD FOR PH IN THE RECEIVING WATER.

- DE-WATERING CONTROL NOTES ALL TURBID DE-WATERING WATER SHALL BE DISPOSED OF USING ONE OF THE FOLLOWING OPTIONS:
- INFILTRATION.
- TRANSPORT OFFSITE IN A VEHICLE, SUCH AS A VACUUM FLUSH TRUCK, FOR LEGAL DISPOSAL IN A MANNER THAT DOES NOT POLLUTE STATE

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Utilities Underground Location Center

- ECOLOGY-APPROVED ON-SITE CHEMICAL TREATMENT OR OTHER SUITABLE TREATMENT TECHNOLOGIES,
- SANITARY SEWER DISCHARGE WITH LOCAL SEWER DISTRICT APPROVAL, IF THERE IS NO OTHER OPTION, USE OF A SEDIMENTATION BAG WITH OUTFALL TO A DITCH OR SWALE FOR SMALL VOLUMES OF LOCALIZED DE-WATERING, OR
- FOUNDATION, VAULT, AND TRENCH DE-WATERING WATER, WHICH HAVE SIMILAR CHARACTERISTICS TO STORMWATER RUNOFF AT THE SITE, SHALL BE DISPERSED TO NATIVE VEGETATION AND/ OR DISCHARGED TO A SEDIMENTATION FACILITY.


MAINTENANCE OF SILTATION BARRIERS NOTE

1. SILTATION BARRIERS SHALL BE INSPECTED IMMEDIATELY AFTER EACH RAINFALL AND AT LEAST DAILY DURING PROLONGED RAINFALL. CLOSE ATTENTION SHALL BE PAID TO THE REPAIR OF DAMAGED BALES, END RUNS AND UNDERCUTTING BENEATH BALES. NECESSARY REPAIRS TO BARRIERS OR REPLACEMENT OF BALES SHALL BE ACCOMPLISHED PROMPTLY. SEDIMENT DEPOSITS SHOULD BE REMOVED AFTER EACH RAINFALL. SEDIMENT DEPOSITS MUST BE REMOVED WHEN SEDIMENT LEVEL REACHES APPROXIMATELY ONE—HALF THE SILTATION BARRIER HEIGHT. ANY SEDIMENT DEPOSITS REMAINING IN PLACE AFTER THE STRAW BALE BARRIER IS NO LONGER REQUIRED SHALL BE DRESSED TO CONFORM TO THE EXISTING GRADE, PREPARED AND SEEDED.

EROSION. SEDIMENTATION AND **WATER QUALITY SITE INSPECTIONS:**

PRIOR TO ANY SITE DEVELOPMENT WORK TAKING PLACE, A PRE-CONSTRUCTION MEETING WITH THE CONTRACTOR, OWNER, CESCL, AND CITY INSPECTOR SHALL BE HELD.

THE DEPARTMENT OF ECOLOGY REQUIRES THAT CONSTRUCTION PROJECTS ONE ACRE OR LARGER RETAIN A CESCL TO ENSURE THAT THE PROJECT IS IN COMPLIANCE WITH THE CURRENT EROSION, SEDIMENTATION AND WATER QUALITY STANDARDS. THE OWNER WILL DESIGNATE A CESCL FOR THIS PROJECT. THE 24 HOUR CONTACT PERSON IS TO BE DETERMINED.

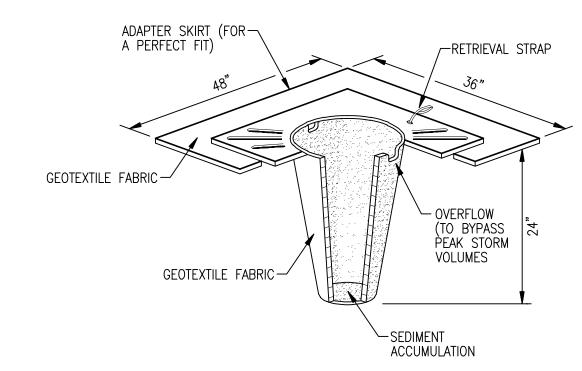

STORM DRAIN INLET PROTECTION

CITY PROJECT #: PA22-023

CITY OF MARYSVILLE CONSTRUCTION DRAWING REVIEW ACKNOWLEDGEMENT

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KEN MCINTYRE, P.E., ASSISTANT CITY ENGINEER

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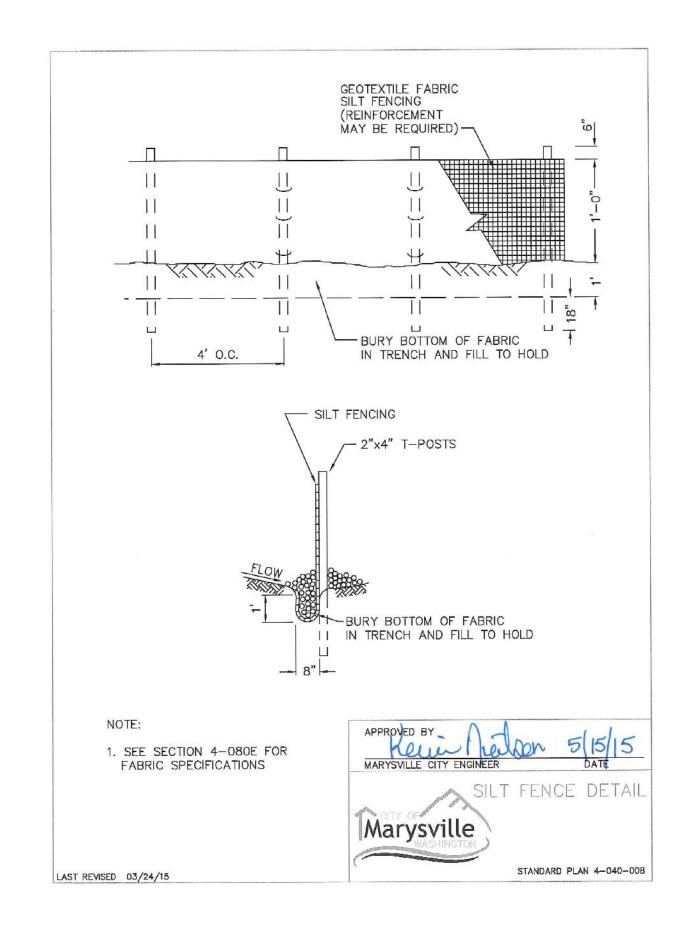
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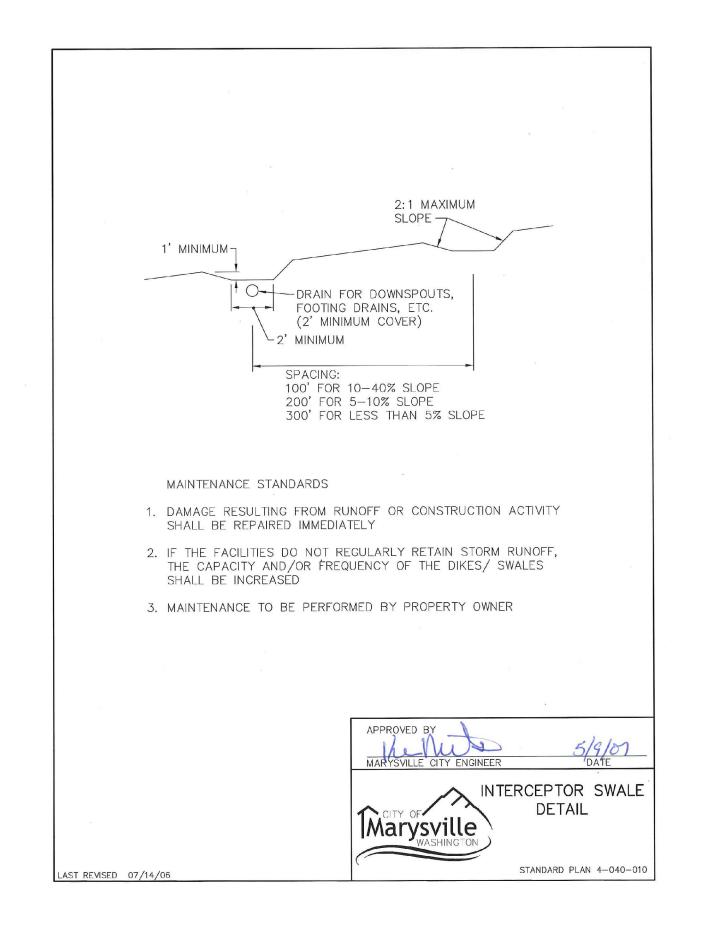
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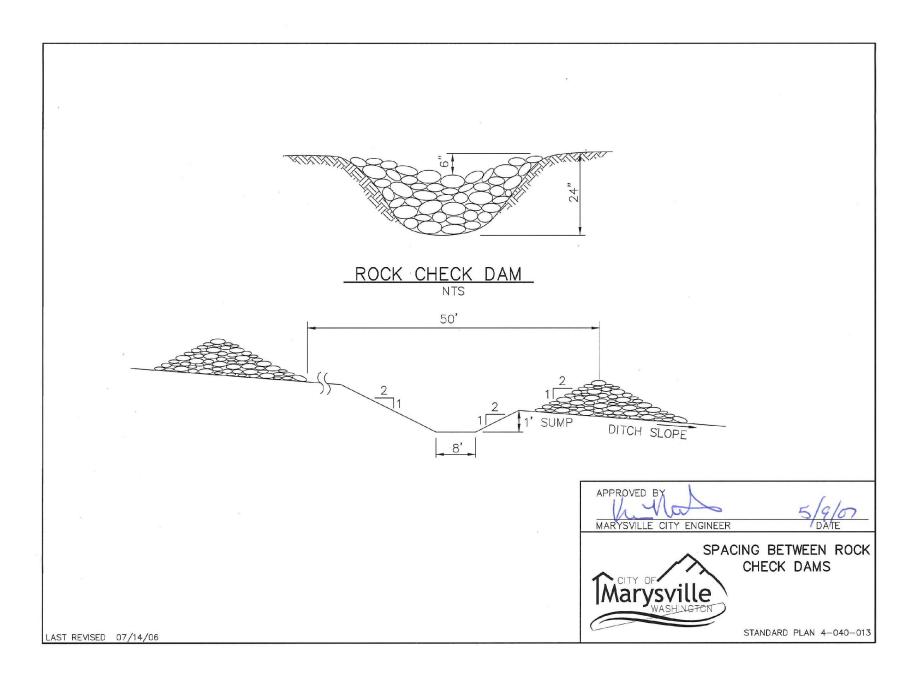
JOB NUMBER: DRAWING NAME: C22177C-ER DESIGNER: DRAFTING BY: 11 - 15 - 2AS NOT JRISDICTION: MARYSVI


UTILITY NOTE

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Utilities Underground Location Center

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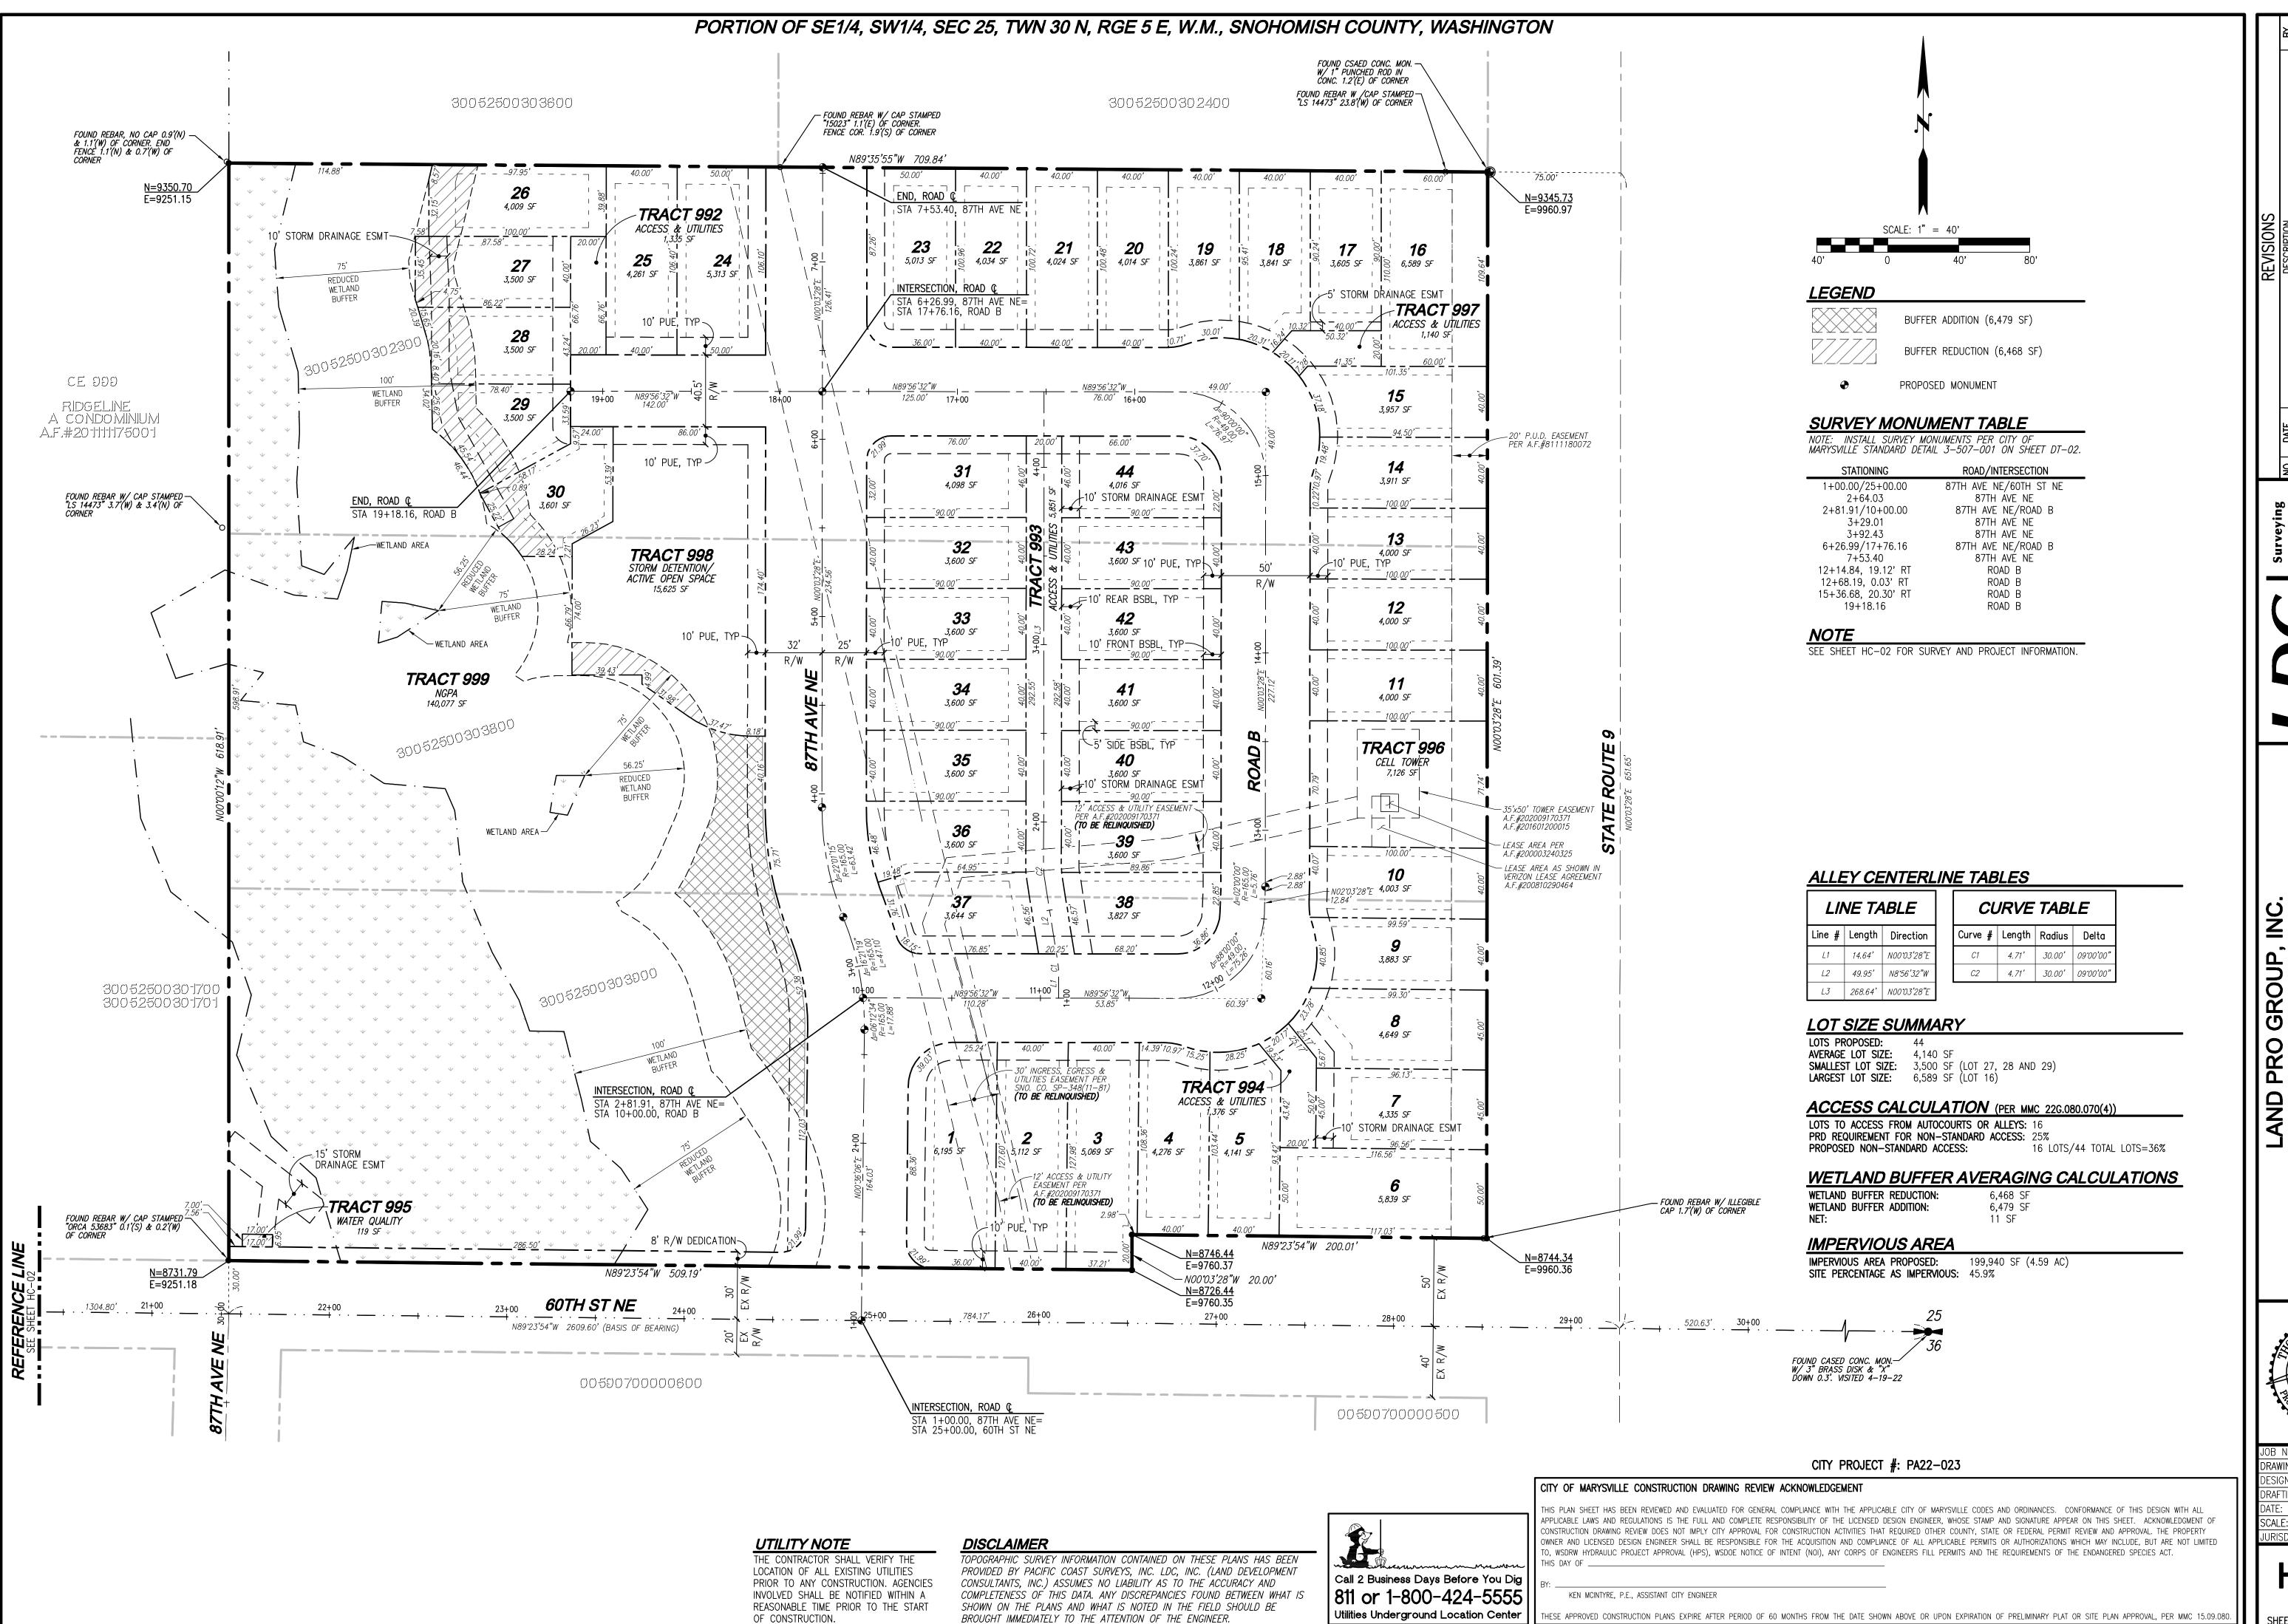
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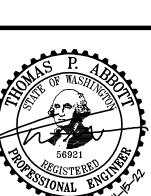
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FILL PERMITS AND THE REQUIREMENTS OF THE ENDANGERED SPECIES ACT.	ER	-04
OTHER COUNTY, STATE OR FEDERAL PERMIT REVIEW AND APPROVAL. THE PROPERTY L APPLICABLE PERMITS OR AUTHORIZATIONS WHICH MAY INCLUDE, BUT ARE NOT LIMITED	JURISDICTION:	MARYSVILLE
SINEER, WHOSE STAMP AND SIGNATURE APPEAR ON THIS SHEET. ACKNOWLEDGMENT OF	SCALE:	AS NOTED
OF MARYSVILLE CODES AND ORDINANCES. CONFORMANCE OF THIS DESIGN WITH ALL	DATE:	11-15-22
	DRAFTING BY:	DPN
	DESIGNER:	TPA




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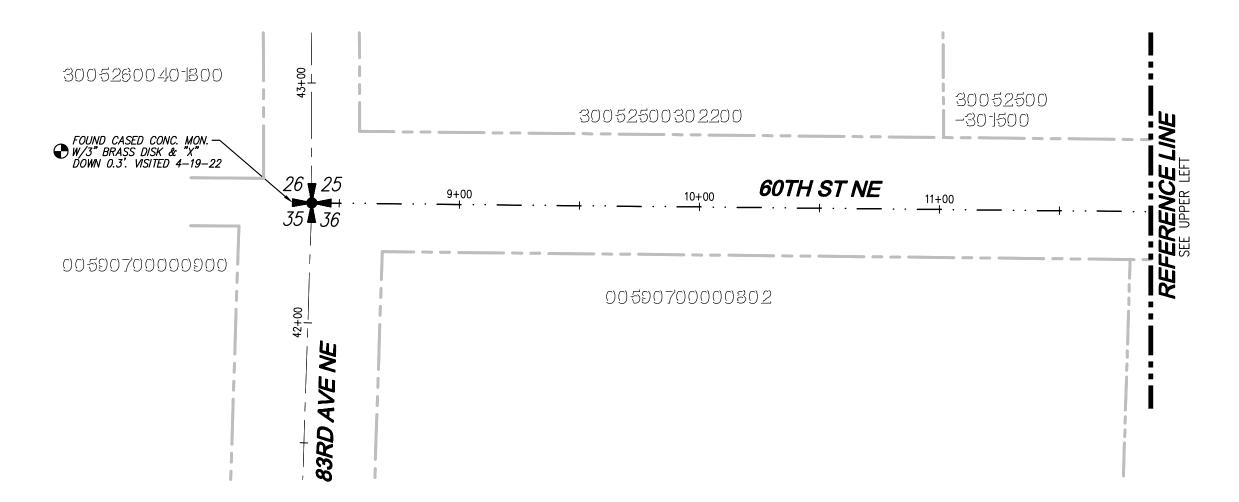
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JOB NUMBER:	C22-17
DRAWING NAME:	C22177C-HC-F
DESIGNER:	TF
DRAFTING BY:	DP
DATE:	11-15-2
SCALE:	1"=4

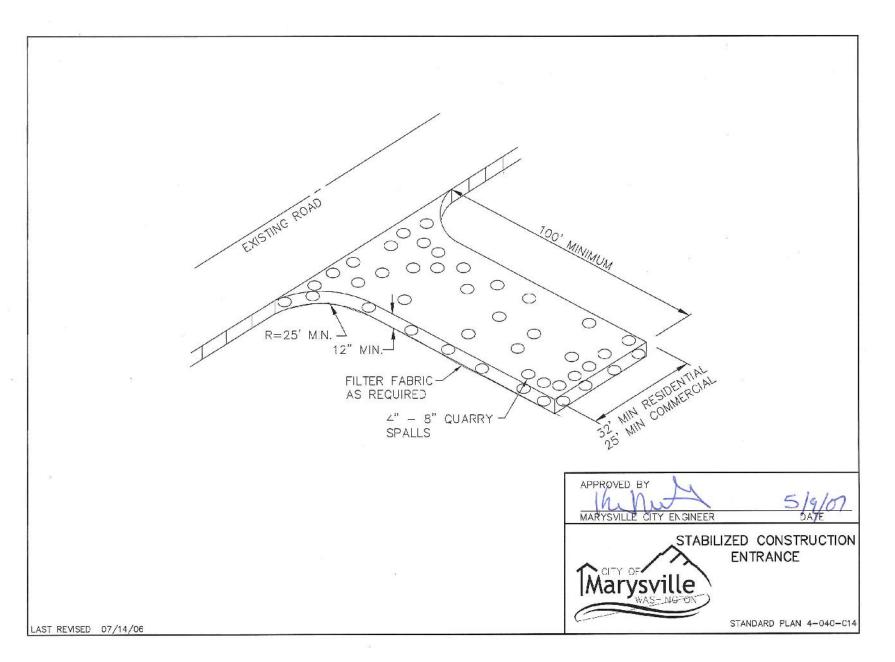JRISDICTION: MARYSVIL





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DISCLAIMER

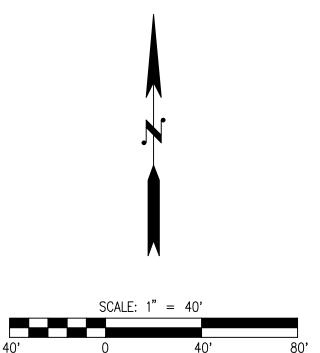TOPOGRAPHIC SURVEY INFORMATION CONTAINED ON THESE PLANS HAS BEEN

PROVIDED BY PACIFIC COAST SURVEYS, INC. LDC, INC. (LAND DEVELOPMENT

COMPLETENESS OF THIS DATA. ANY DISCREPANCIES FOUND BETWEEN WHAT IS

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SHOWN ON THE PLANS AND WHAT IS NOTED IN THE FIELD SHOULD BE

BROUGHT IMMEDIATELY TO THE ATTENTION OF THE ENGINEER.

SURVEY INFORMATION

LEGAL DESCRIPTION

PARCEL A:

LOT 2. SNOHOMISH COUNTY SHORT PLAT NUMBER SP-348 (11-81) RECORDED UNDER AUDITOR'S FILE NUMBER 8207290183, BEING A PORTION OF THE SOUTHEAST QUARTER OF THE SOUTHWEST QUARTER OF SECTION 25, TOWHSHIP 30 NORTH, RANGE 5 EAST, W.M.,

PARCEL B:

LOT 3, SNOHOMISH COUNTY SHORT PLAT NUMBER SP-348 (11-81) RECORDED UNDER AUDITOR'S FILE NUMBER 8207290183, BÈING A PORTION OF THE SOUTHEAST QUARTER OF THE SOUTHWEST QUARTER OF SECTION 25, TOWHSHIP 30 NORTH, RANGE 5 EAST, W.M.,

PARCEL C:

NAVD 88

LOT 4, SNOHOMISH COUNTY SHORT PLAT NUMBER SP-348 (11-81) RECORDED UNDER AUDITOR'S FILE NUMBER 8207290183, BÈING A PORTION OF THE SOUTHEAST QUARTER OF THE SOUTHWEST QUARTER OF SECTION 25, TOWHSHIP 30 NORTH, RANGE 5 EAST, W.M.,

VERTICAL DATUM

FOUND CONCRETE MONUMENT WITH A 3" BRASS DISK AND "X" 0.3' DEEP IN MONUMENT CASE WITH A BROKEN LID IN THE CENTER OF THE NORTHBOUND LANE OF 83RD AVE. N.E., AT IT'S INT. WITH 60TH ST. N.E. ELEV.=382.91'

BASIS OF BEARING

THE SOUTH LINE OF THE SOUTHWEST QUARTER OF SECTION 25, TOWNSHIP 30 NORTH, RANGE 5 EAST, W.M., AS THE BEARING OF N 89°23'54" W, PER SÚRVEY RECORDED UNDÉR AF#200301175004

EQUIPMENT & PROCEDURES

METHOD OF SURVEY: SURVEY PERFORMED BY FIELD TRAVERSE

LEICA TCRA 1105 ROBOTIC ELECTRONIC TOTAL STATION

MEETS OR EXCEEDS STATE STANDARDS WAC 332-130-090

SURVEY REFERENCES (R1) RECORD OF SURVEY — A.F.#200301175004

(R2) SNO. CO. SP-348(11-81) - A.F.#8207290183

SURVEY NOTES

1.) THIS SURVEY HAS BEEN PREPARED FOR THE EXCLUSIVE USE OF PARTIES WHOSE NAMES APPEAR HEREON ONLY, AND DOES NOT EXTEND TO ANY UNNAMED THIRD PARTIES WITHOUT EXPRESS RECERTIFICATION BY THE LAND SURVEYOR OF RECORD.

2.) BOUNDARY LINES SHOWN AND CORNERS SET REPRESENT DEED LÓCATIONS; OWNERSHIP LINES MAY VARY. NO GUARANTEE OF OWNERSHIP IS EXPRESSED OR IMPLIED.

PROJECT INFORMATION

TAX PARCELS:

SITE ADDRESS: SITE AREA:

00590700000301

8703 60TH ST NE EVERETT, WA 98205 435,992 SF 10.01 AC

PROPOSED ZONING: PROPOSED LAND USE: PROPOSED LOTS: WATER:

CITY OF MARYSVILLE SEWER: POWER: SNOHOMISH COUNTY PUD PUGET SOUND ENERGY TELEPHONE: FRONTIER

CABLE: SCHOOL DISTRICT:

COMCAST FIRE DISTRICT:

30052500302300, 30052500303800

30052500303900

CURRENT ZONING: NB (NEIGHBORHOOD BUSINESS) SINGLE FAMILY DETACHED CITY OF MARYSVILLE

LAKE STEVENS SCHOOL DISTRICT 4 MARYSVILLE FIRE DISTRICT

UTILITY NOTE

OF CONSTRUCTION.

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LOCATION OF ALL EXISTING UTILITIES

CITY PROJECT #: PA22-023

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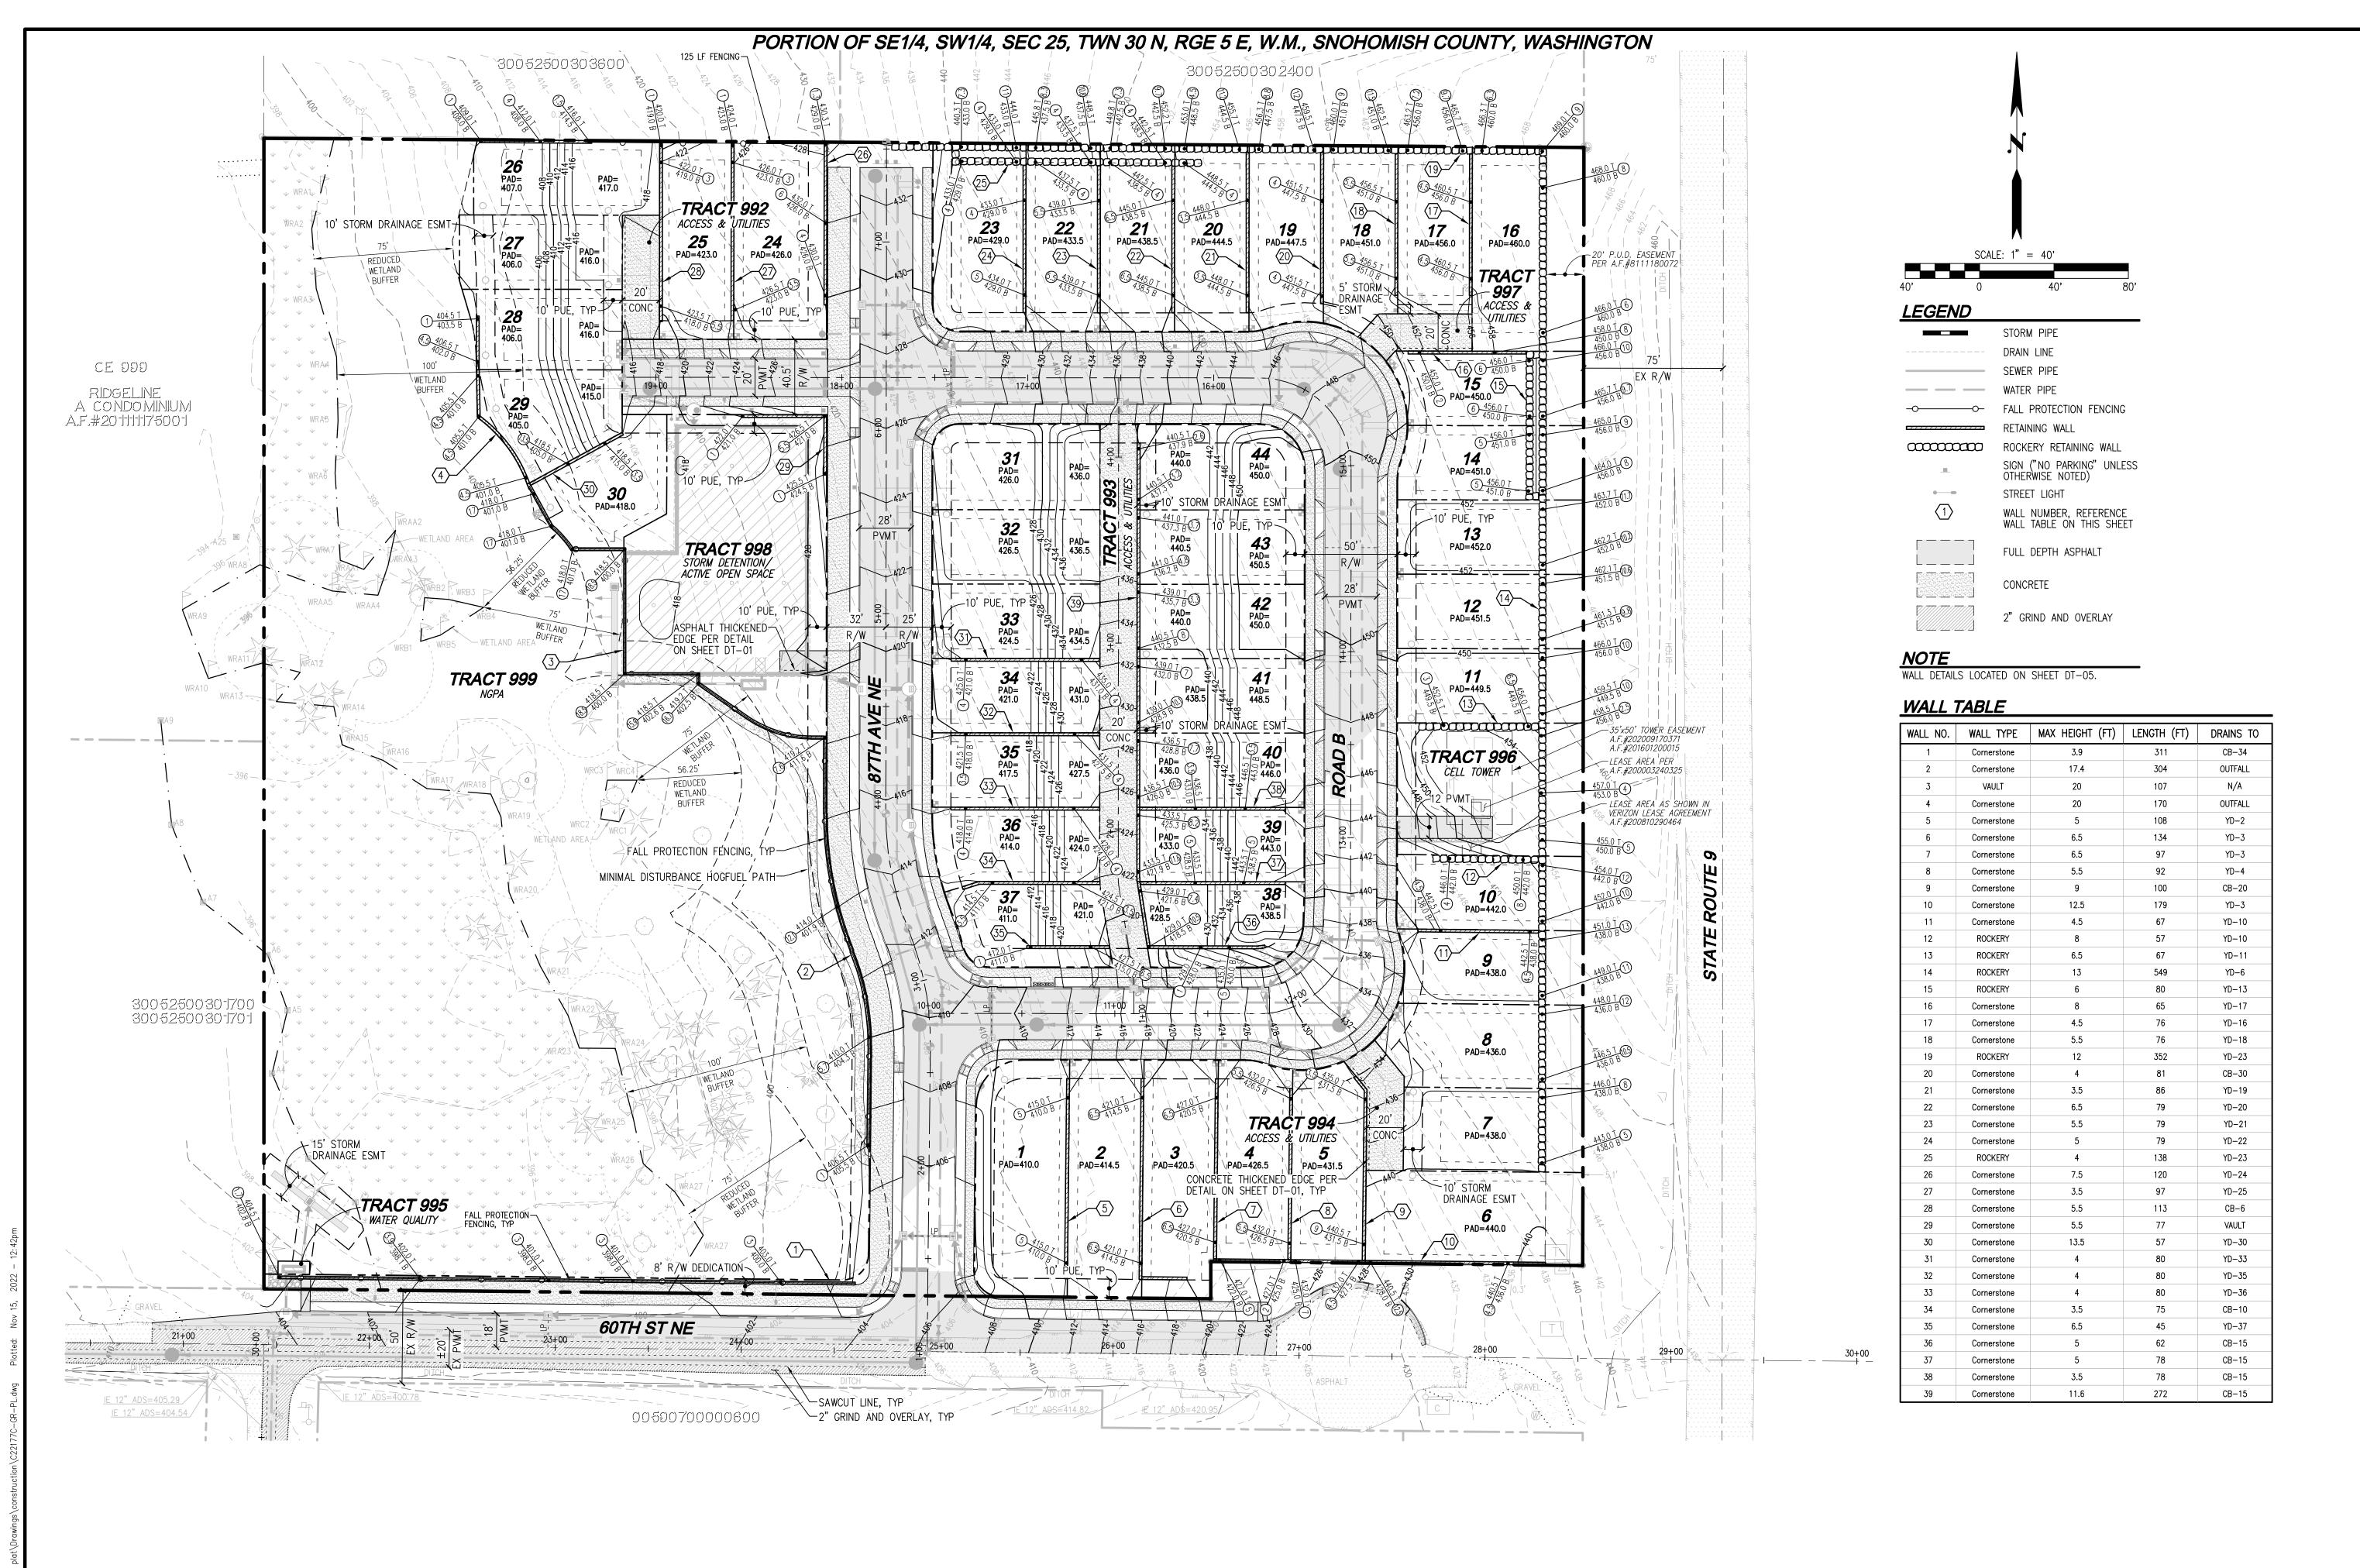
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JOB NUMBER: DRAWING NAME: C22177C-HC-DESIGNER: DRAFTING BY: 11-15-2 URISDICTION: MARYSVILL



UTILITY NOTE

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GR-01 SHEET 10 OF 39

JRISDICTION:

JOB NUMBER:

DESIGNER: DRAFTING BY:

DRAWING NAME: C22177C-GR-

11-04-2


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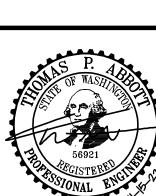
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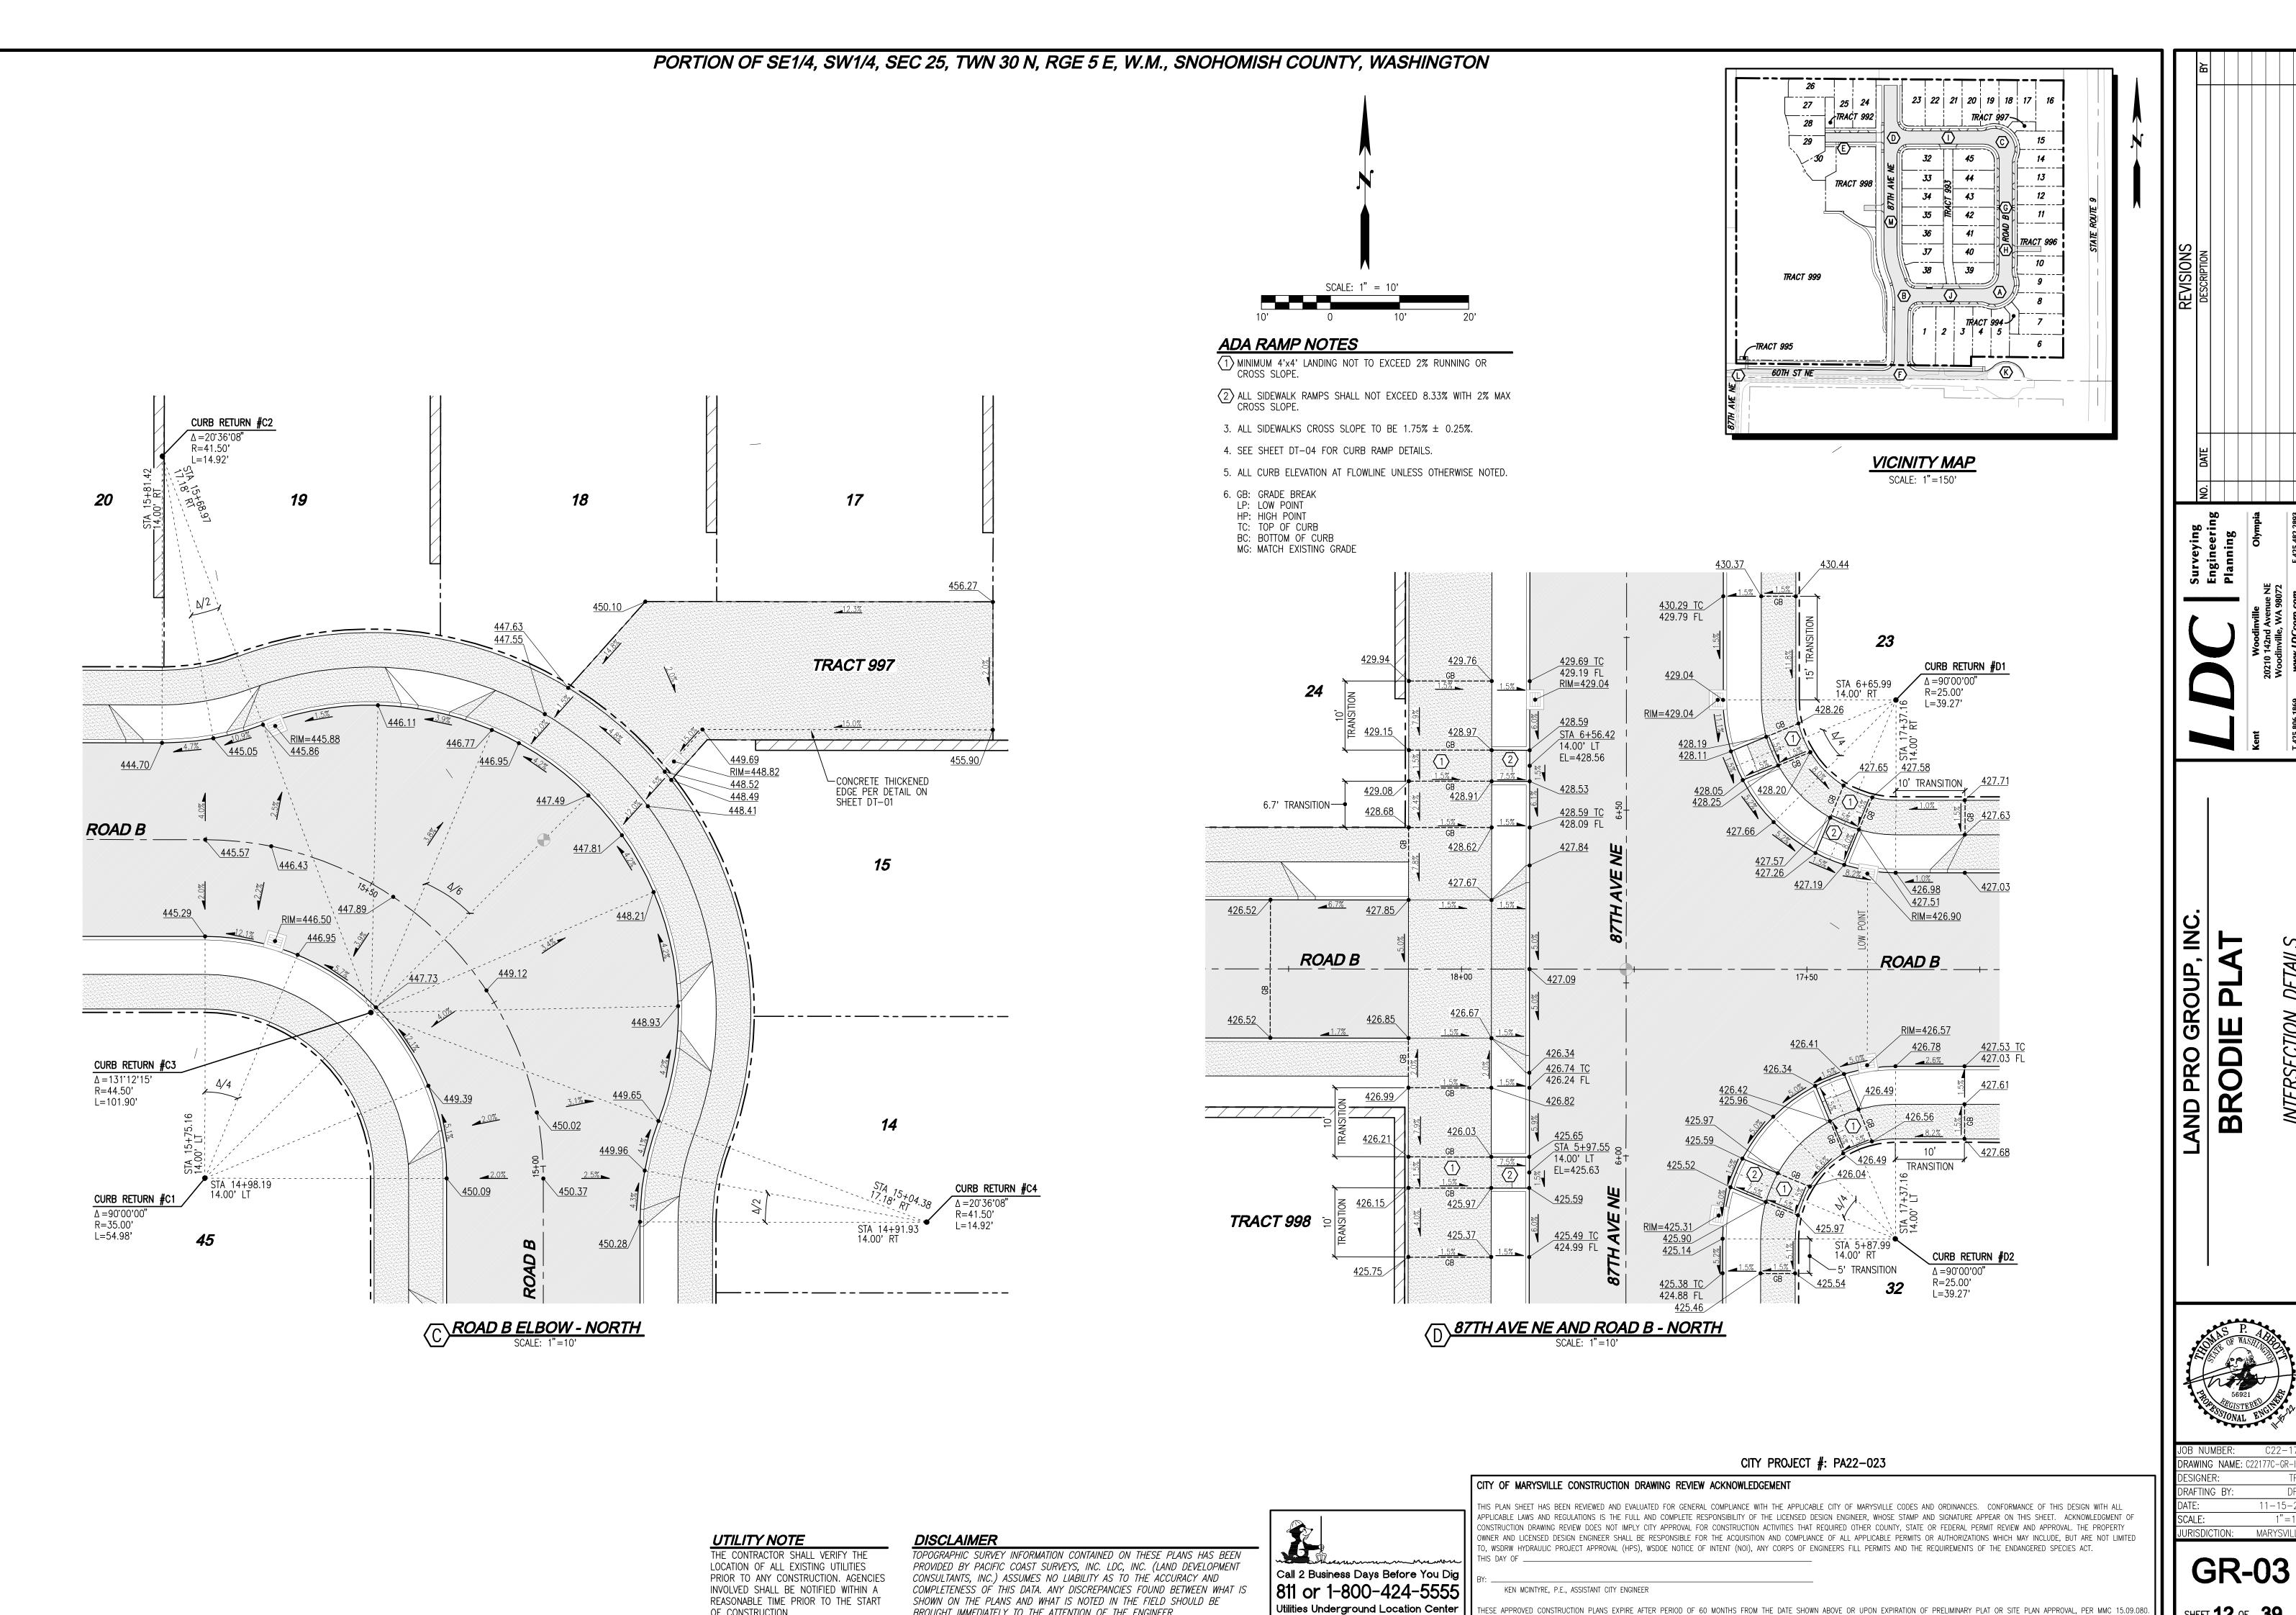


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URISDICTION: MARYSVIL




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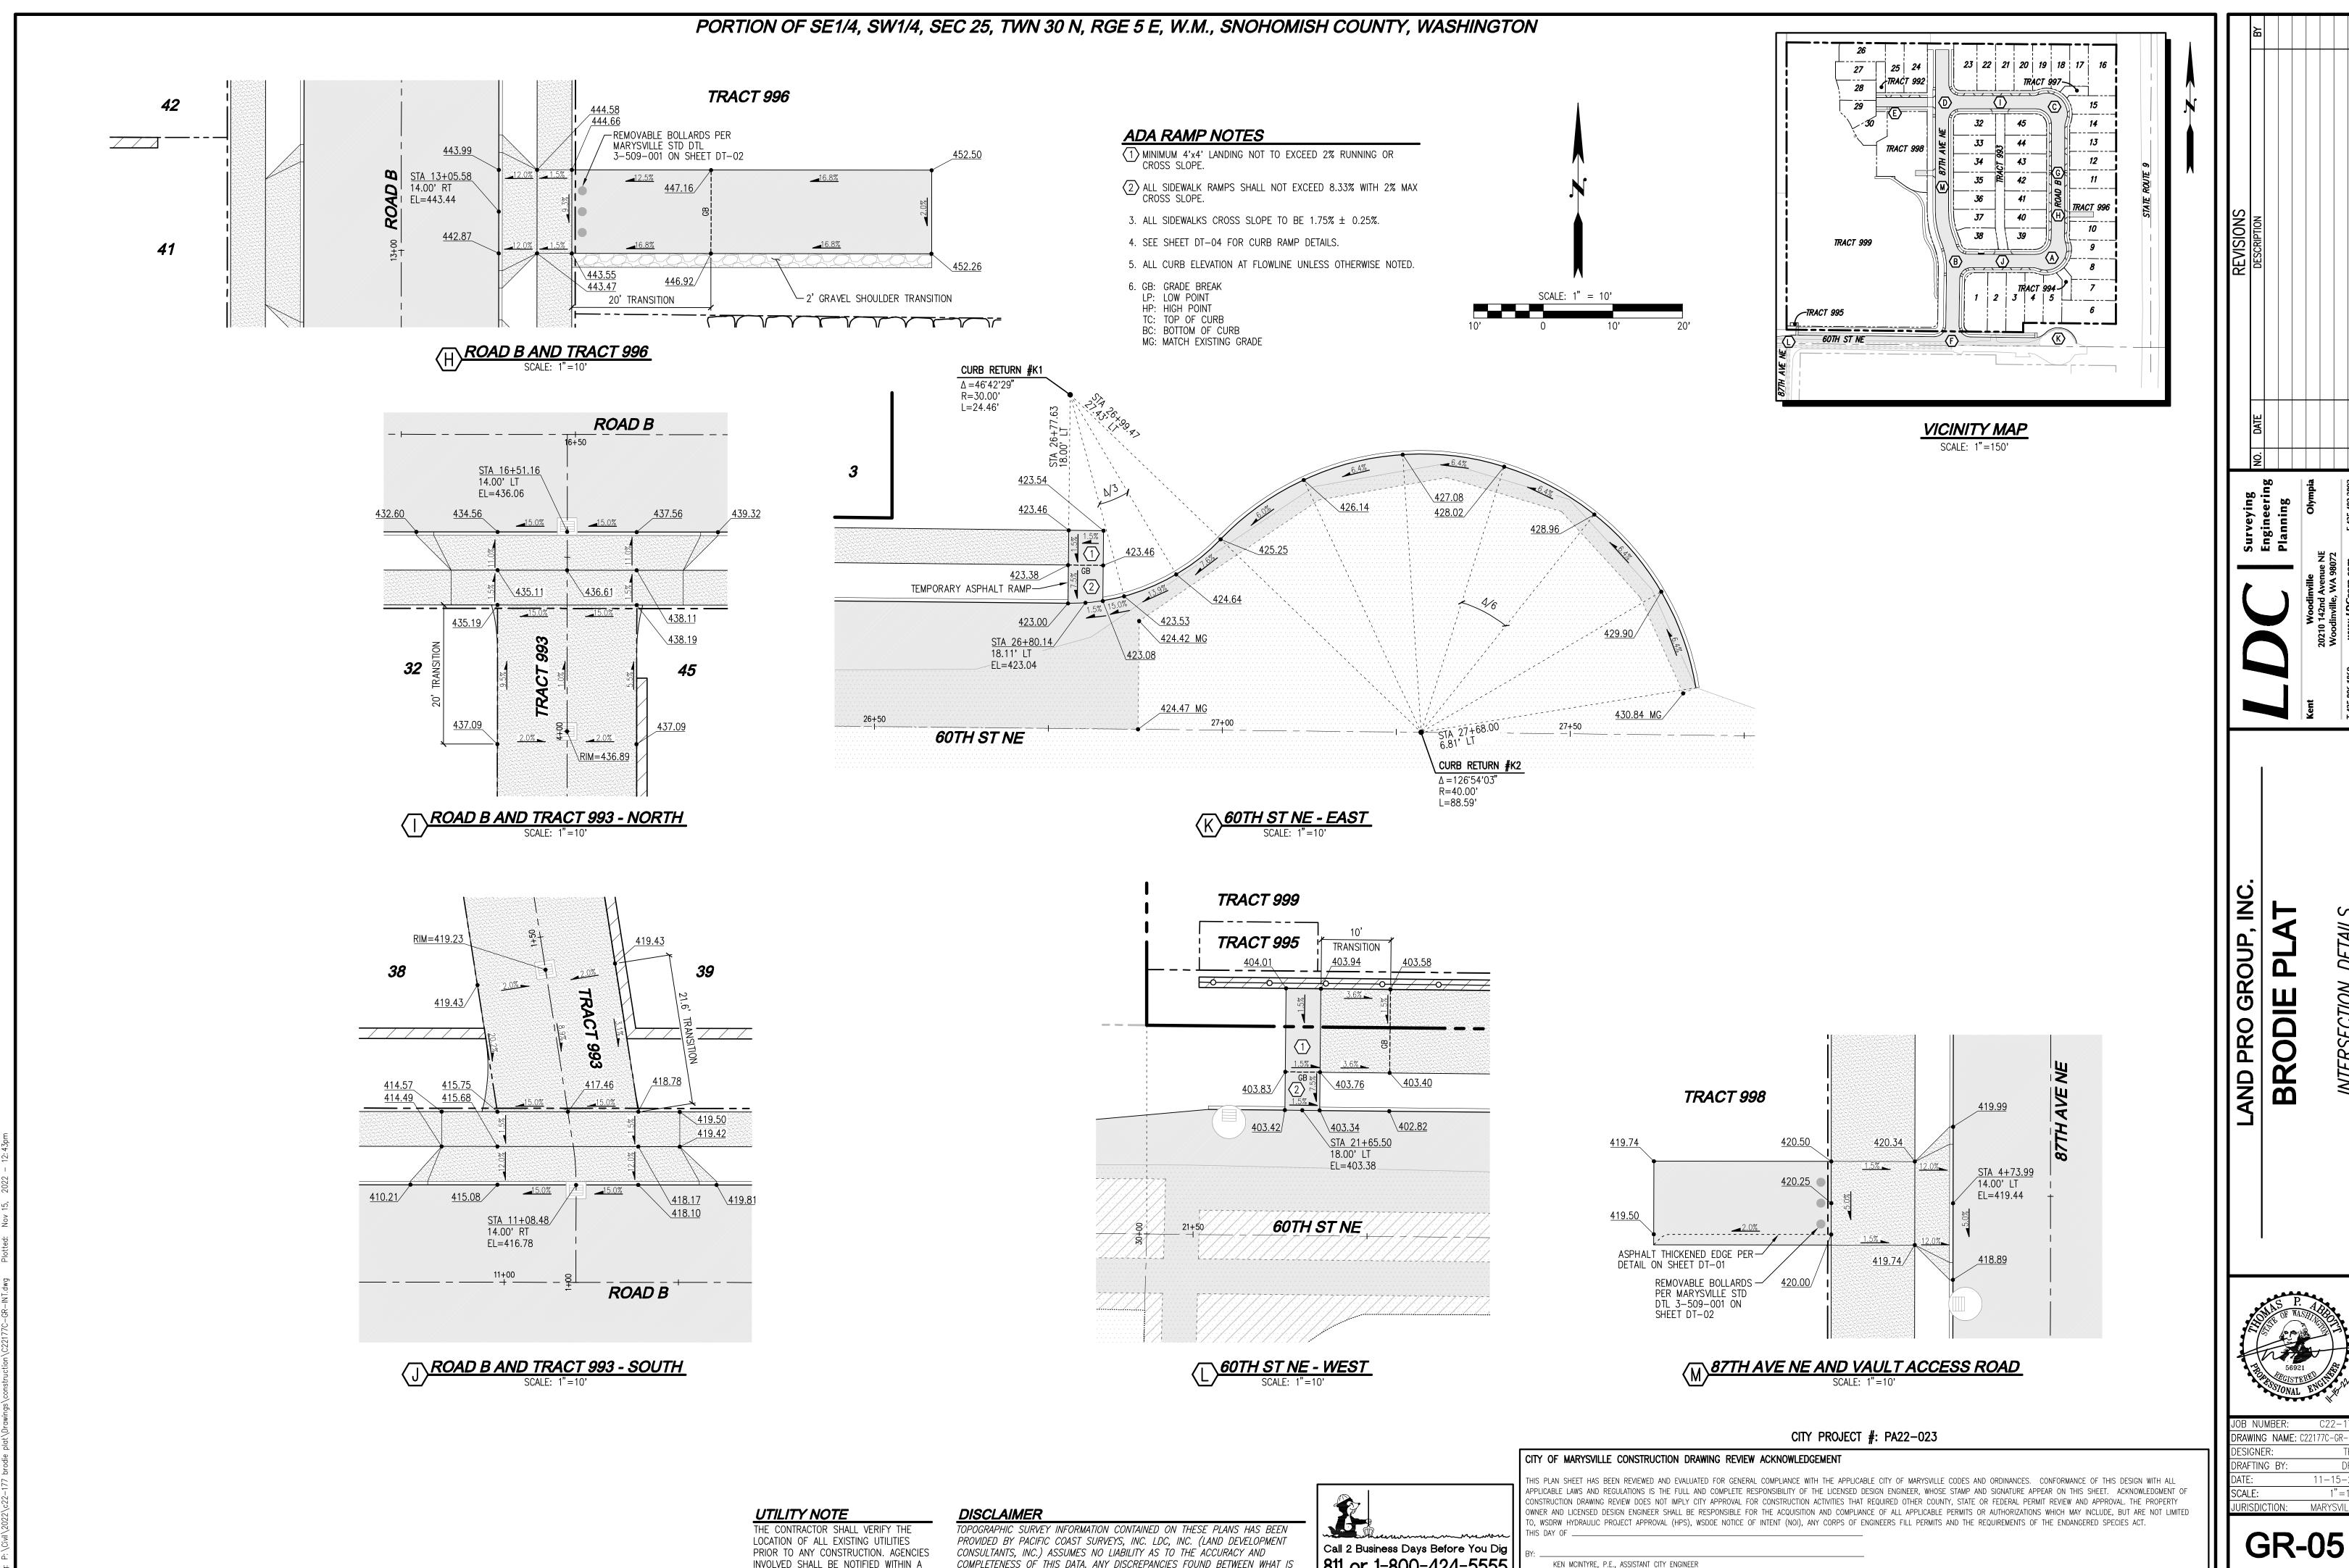
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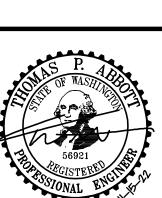


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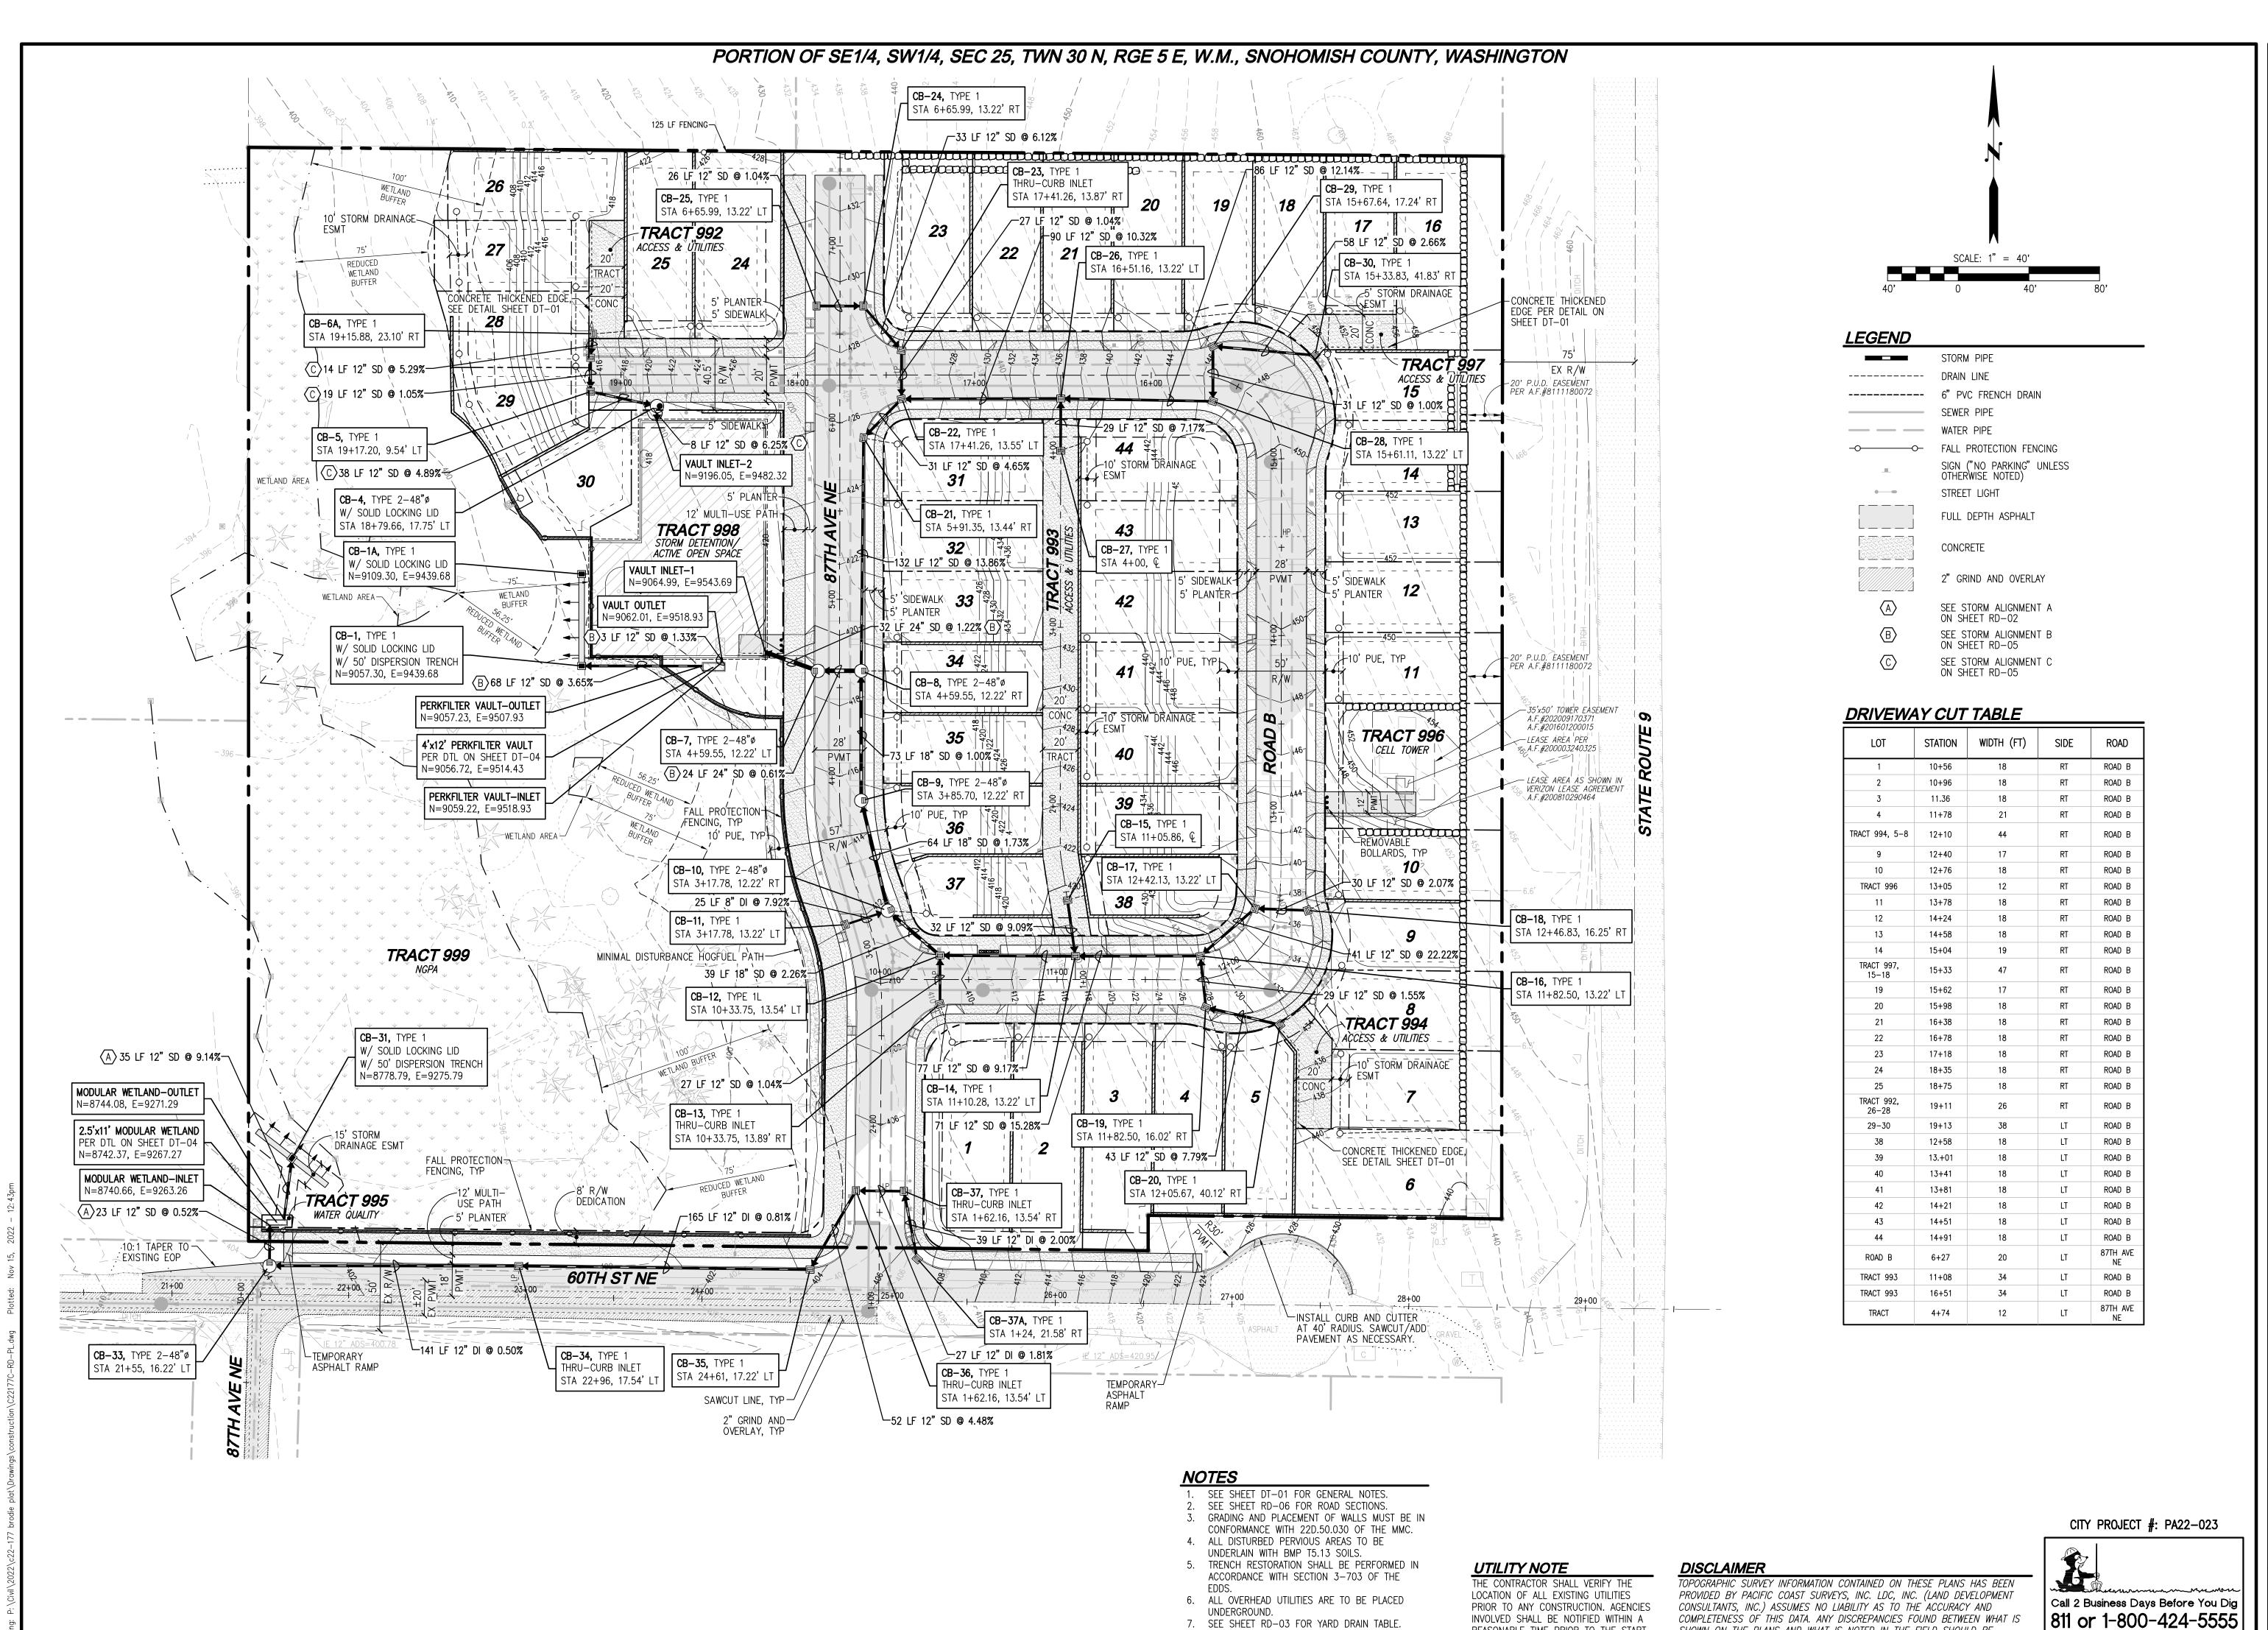
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REASONABLE TIME PRIOR TO THE START

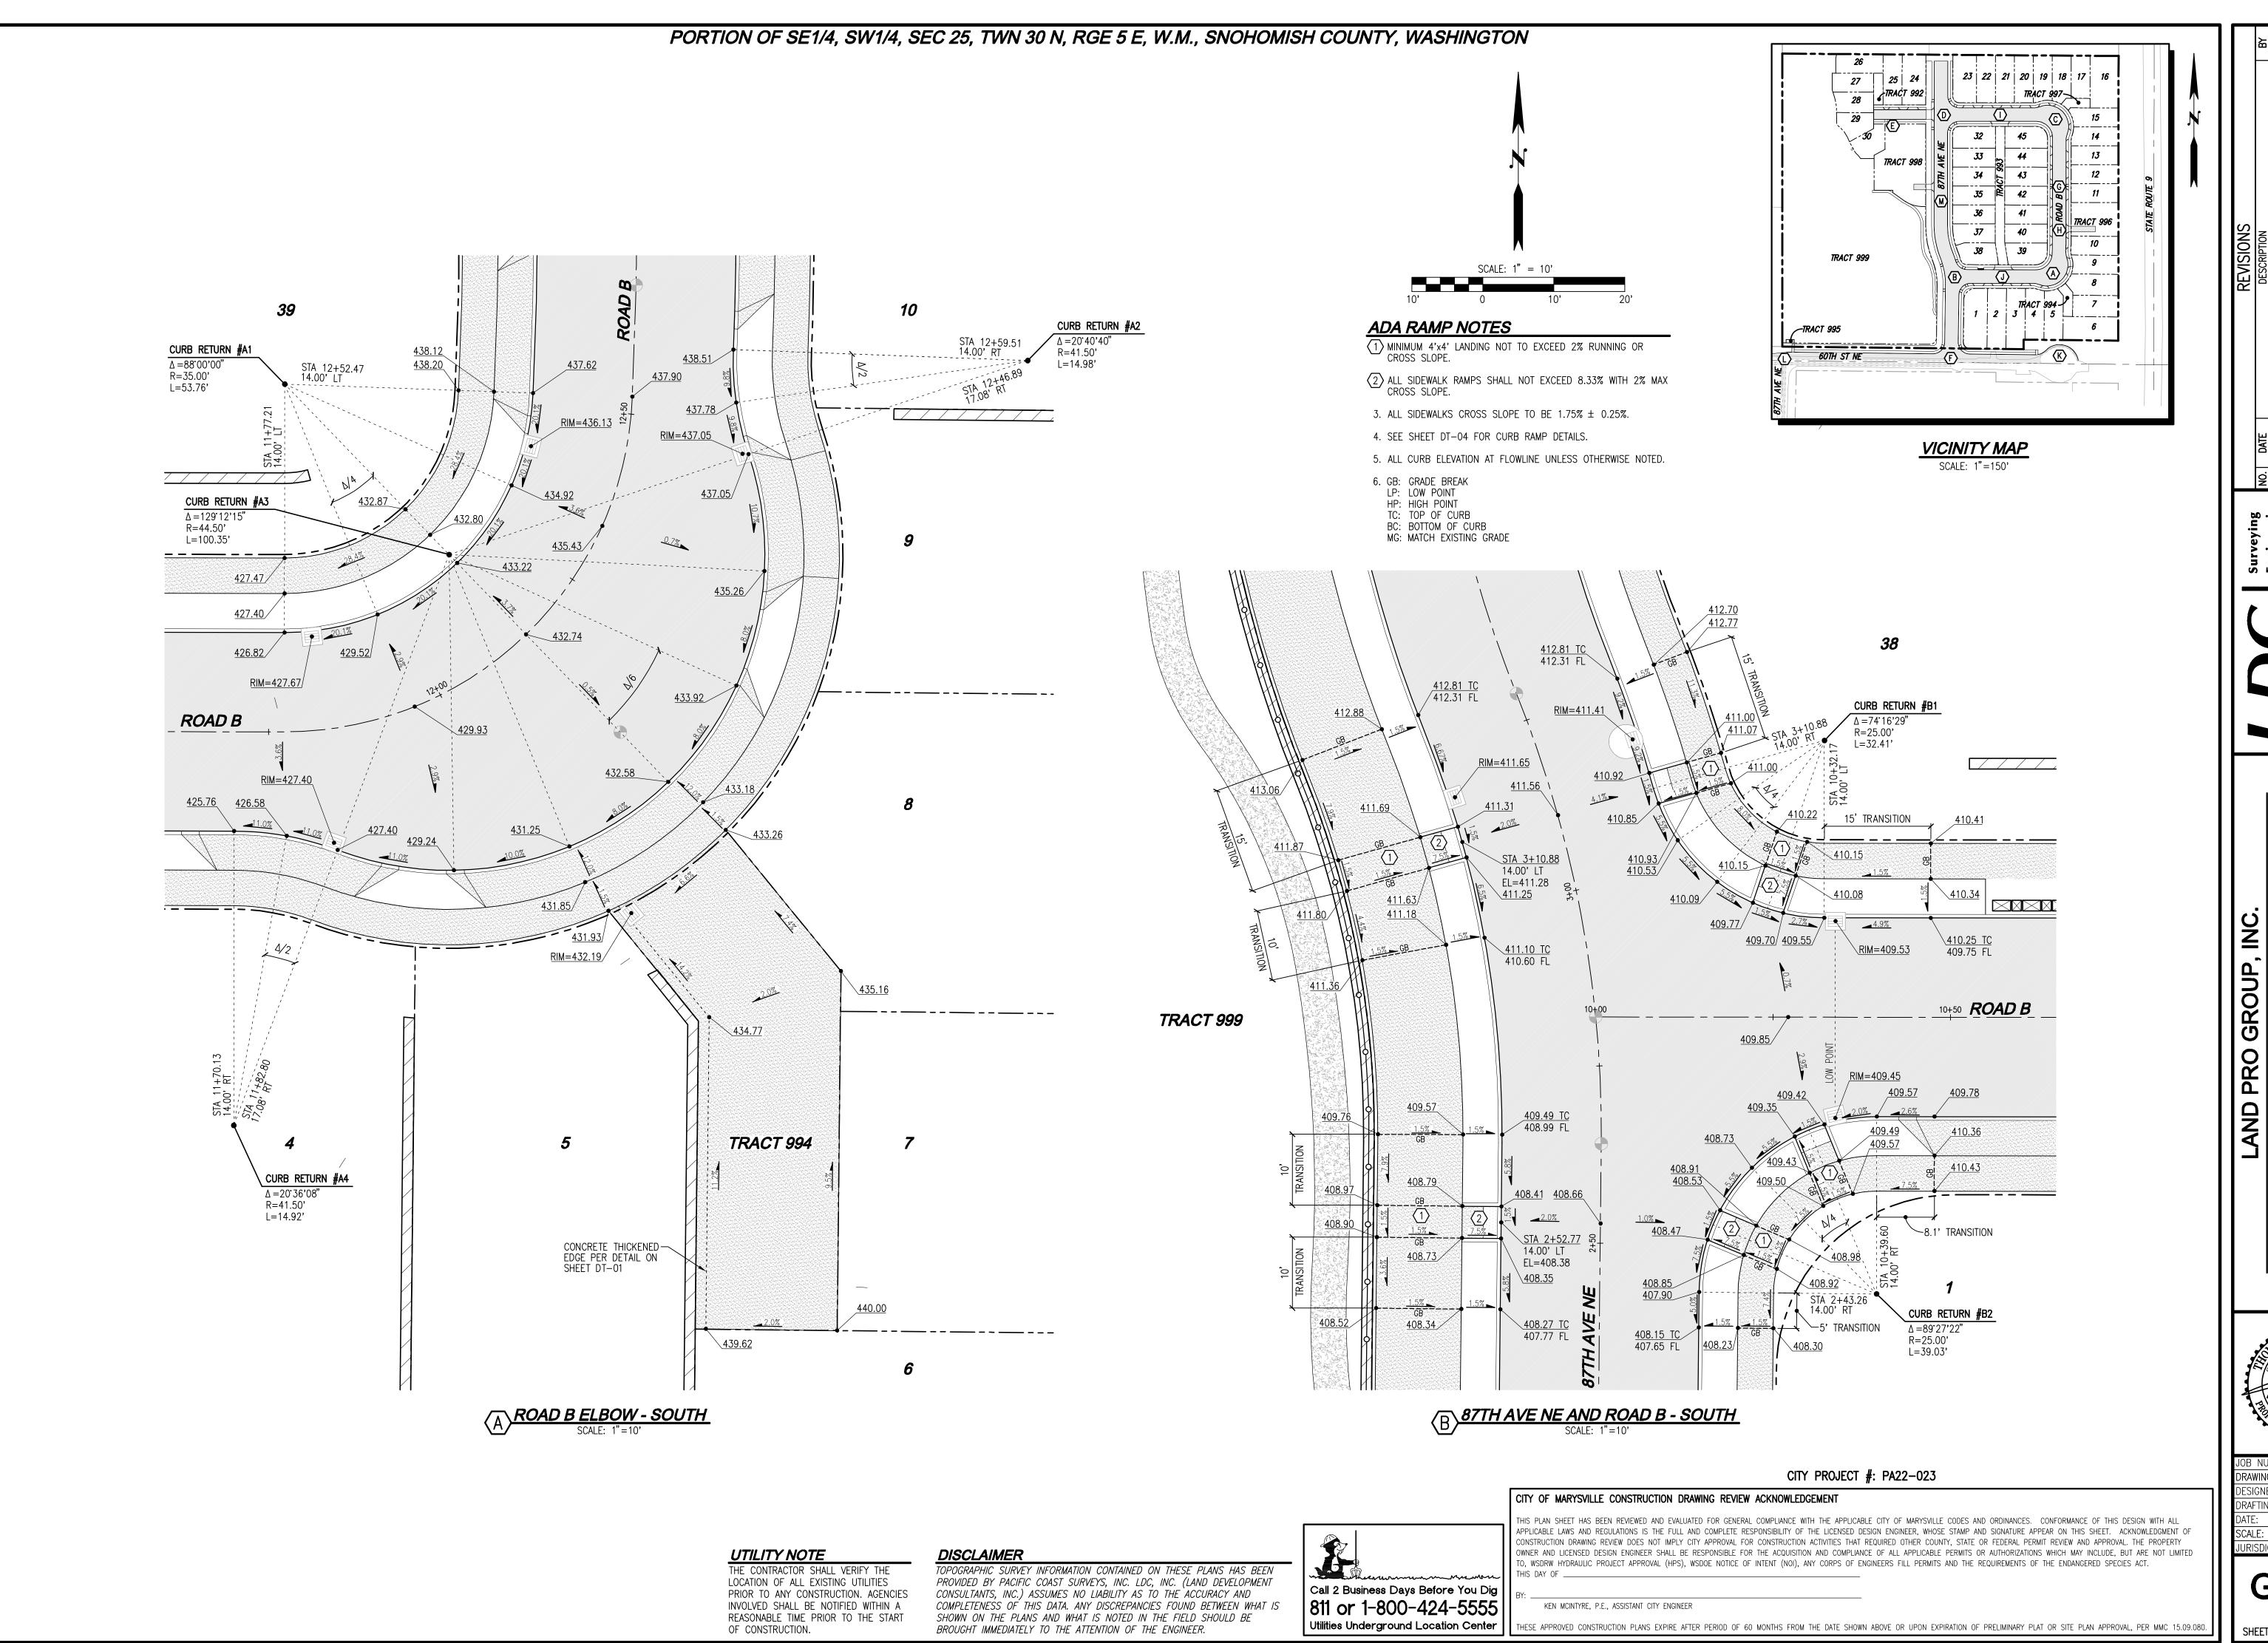
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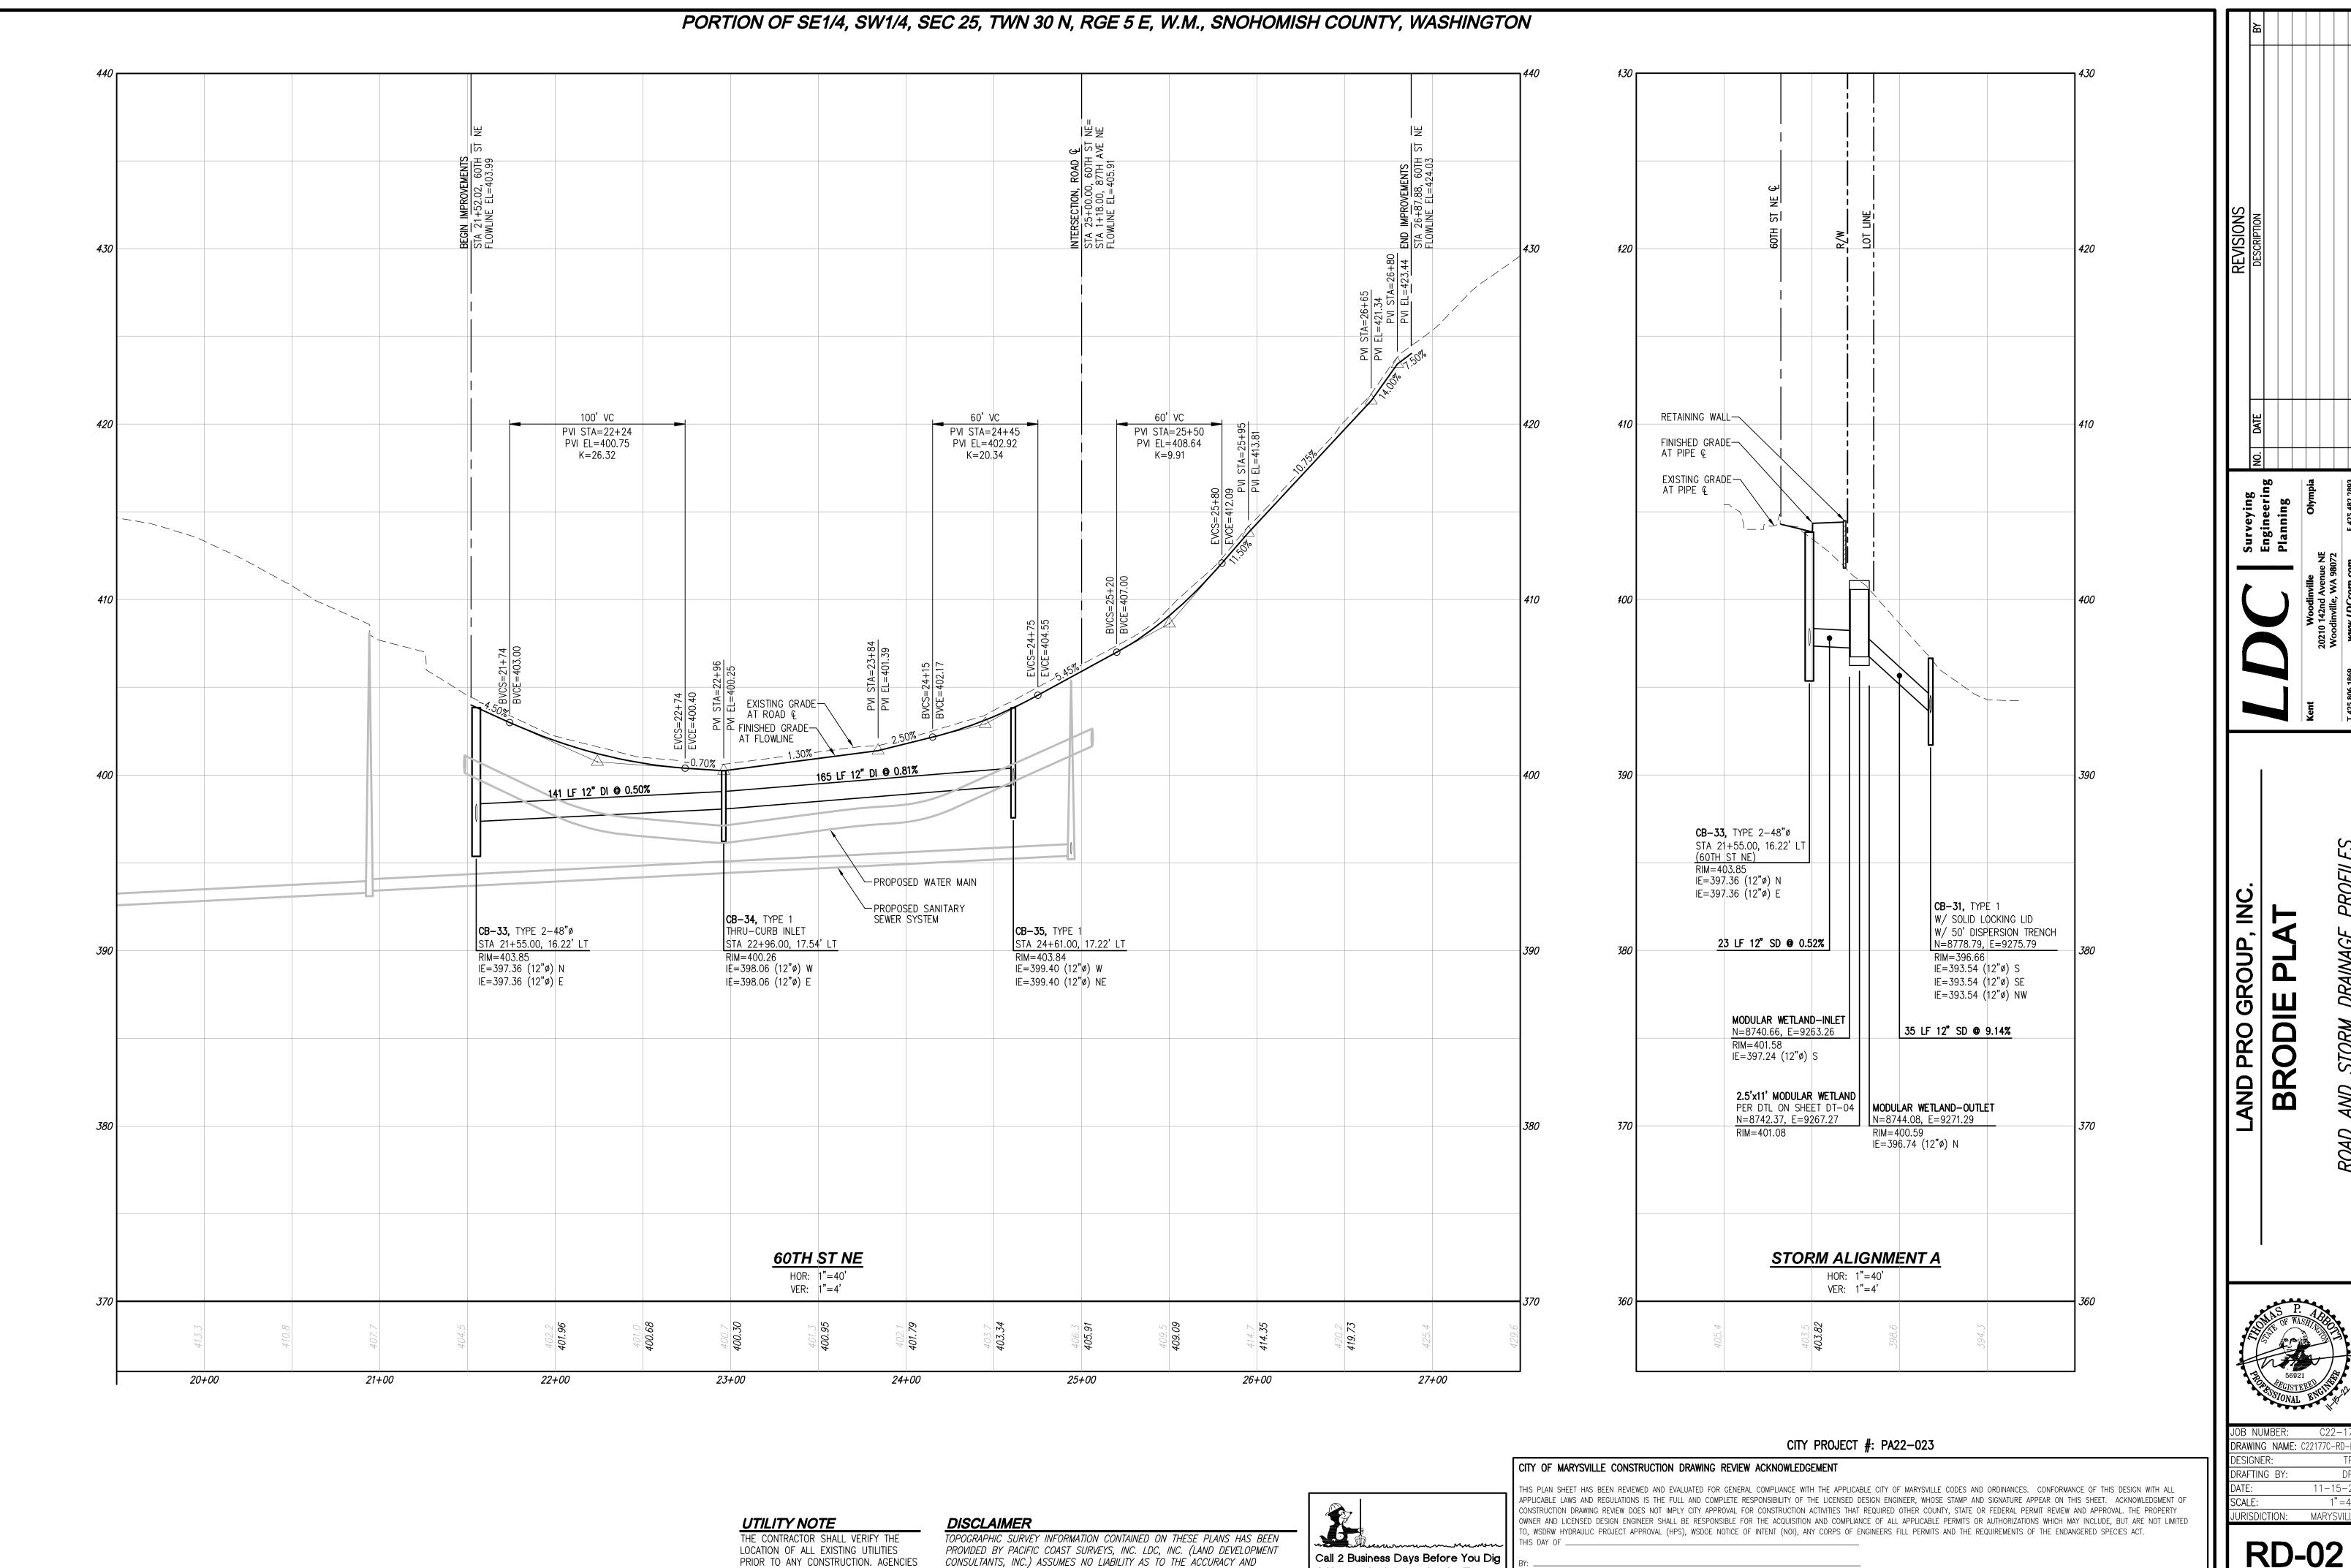


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DESIGNER:	TF
DRAFTING BY:	DF
DATE:	11-04-2
SCALE:	1"=4
JURISDICTION:	MARYSVILL

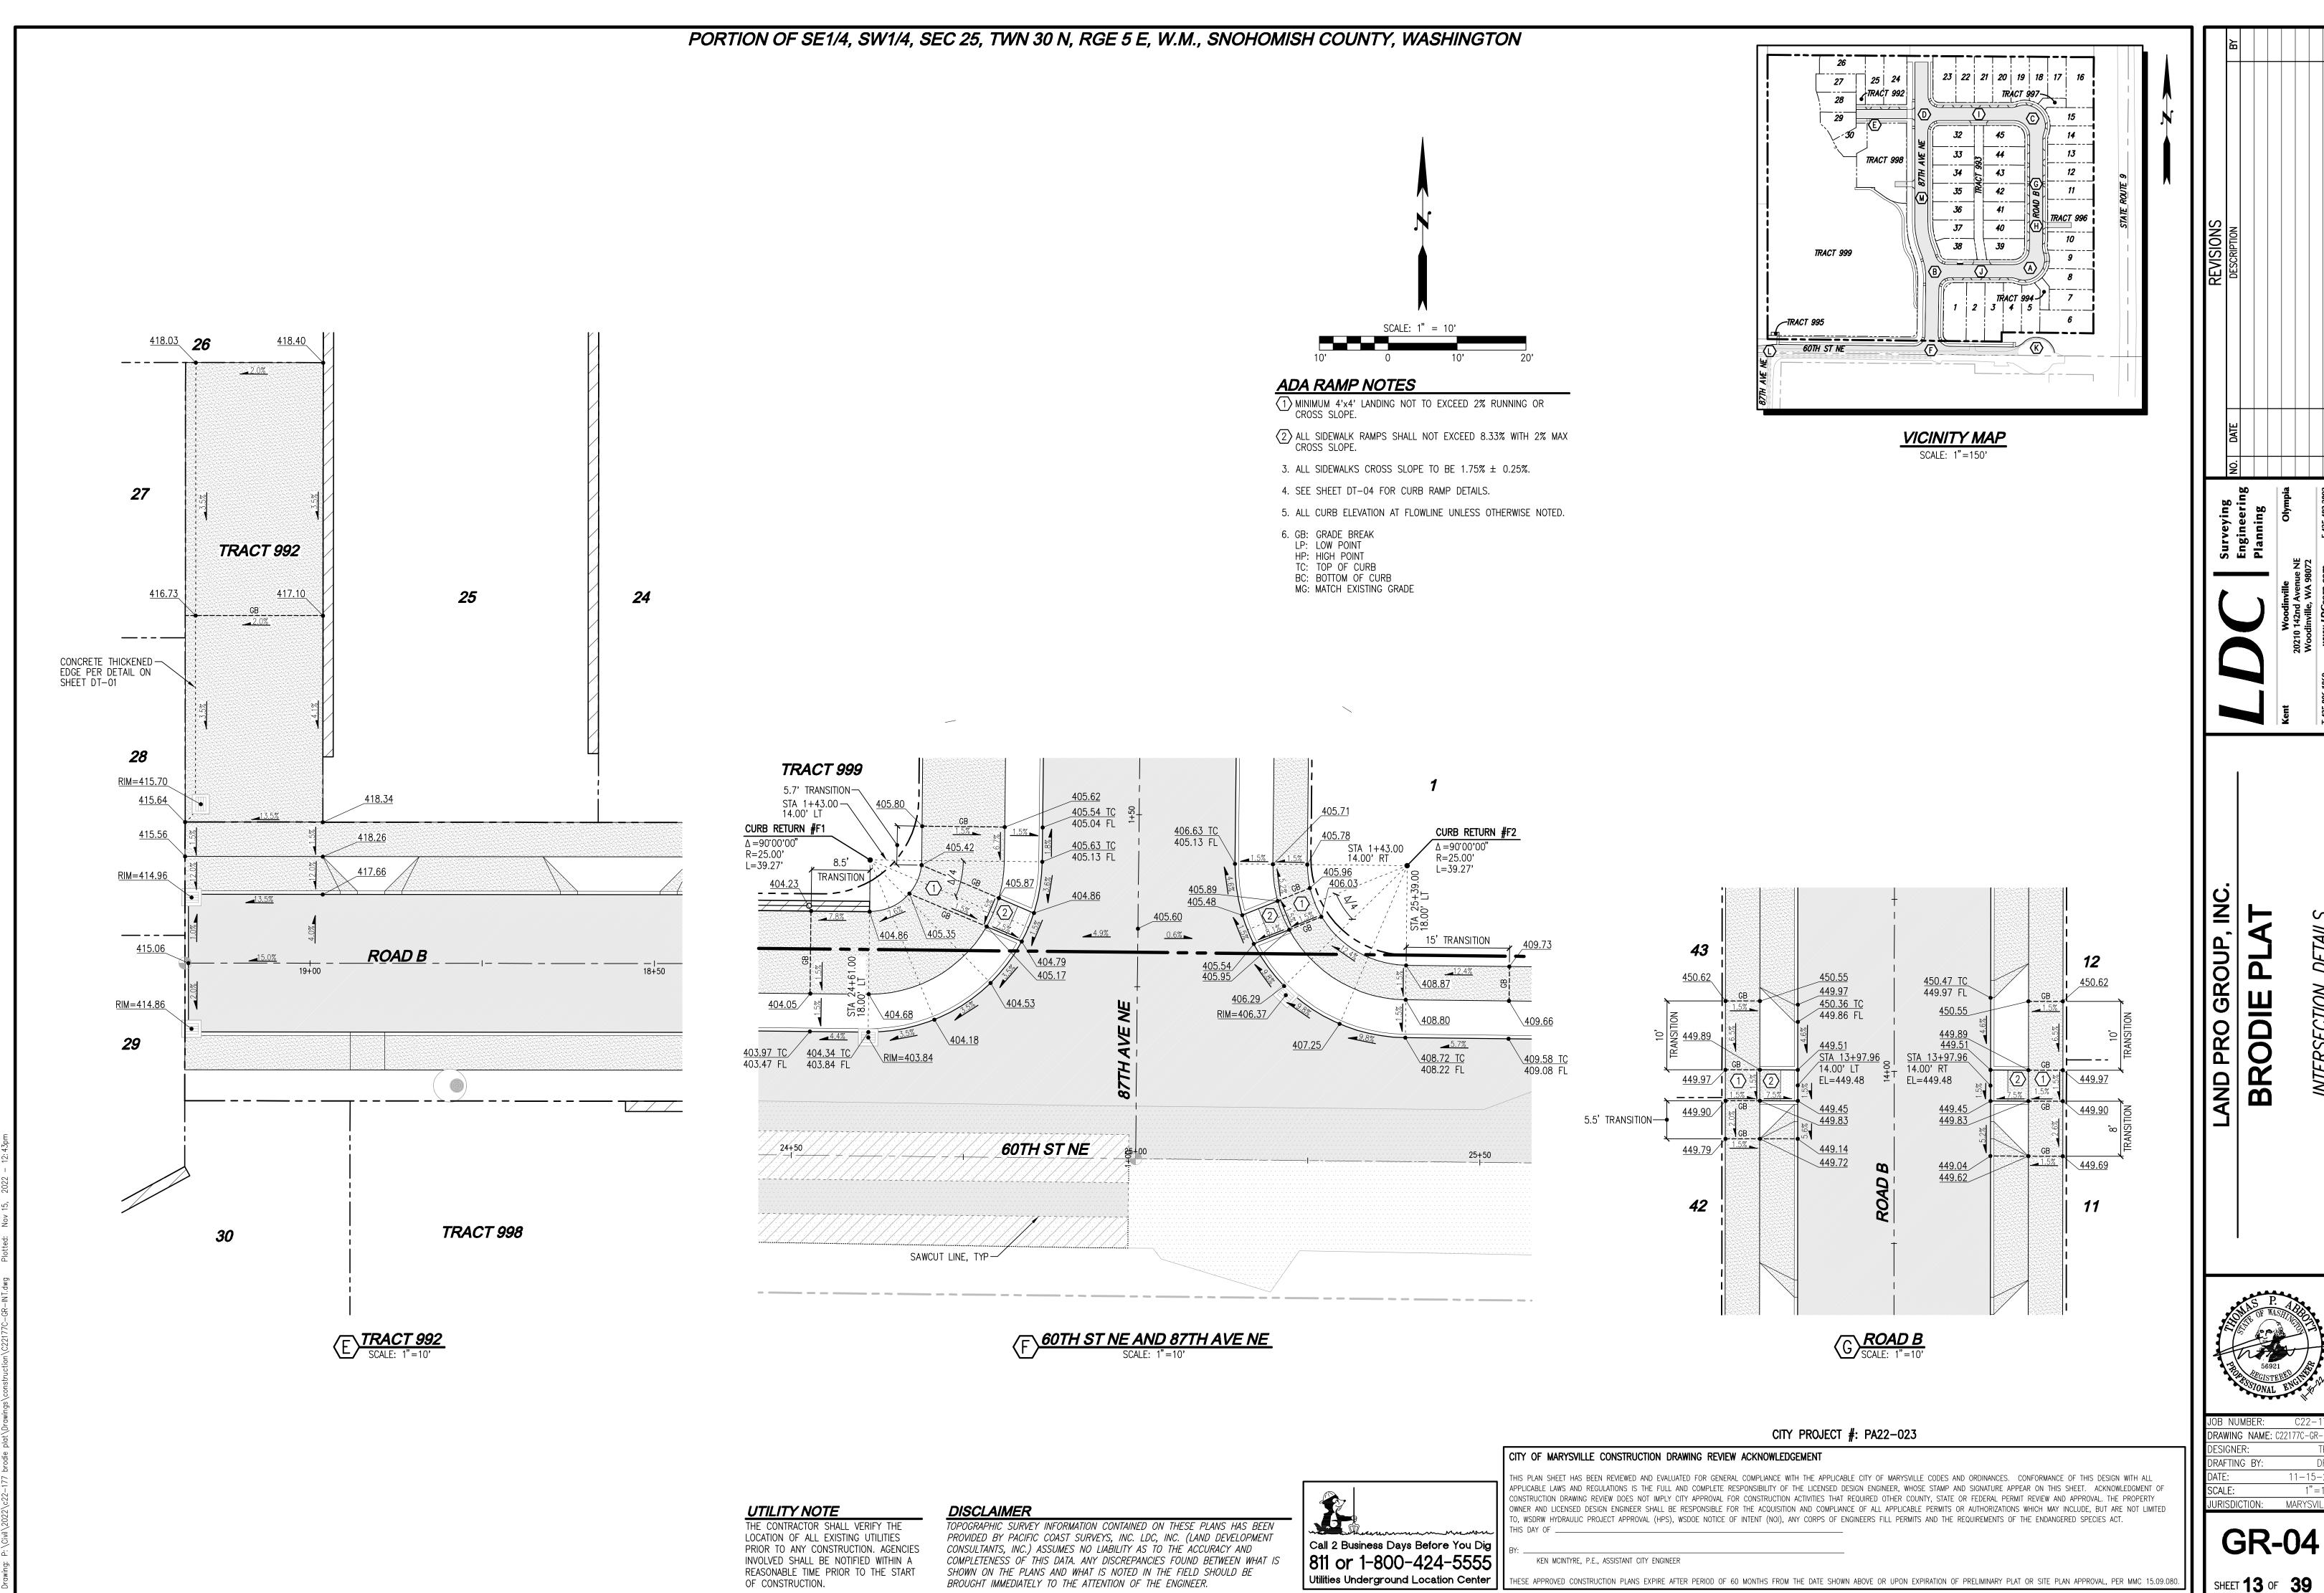RD-01

SHEET **15** OF **39**

Utilities Underground Location Center

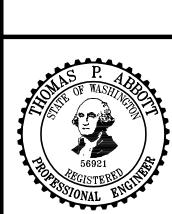

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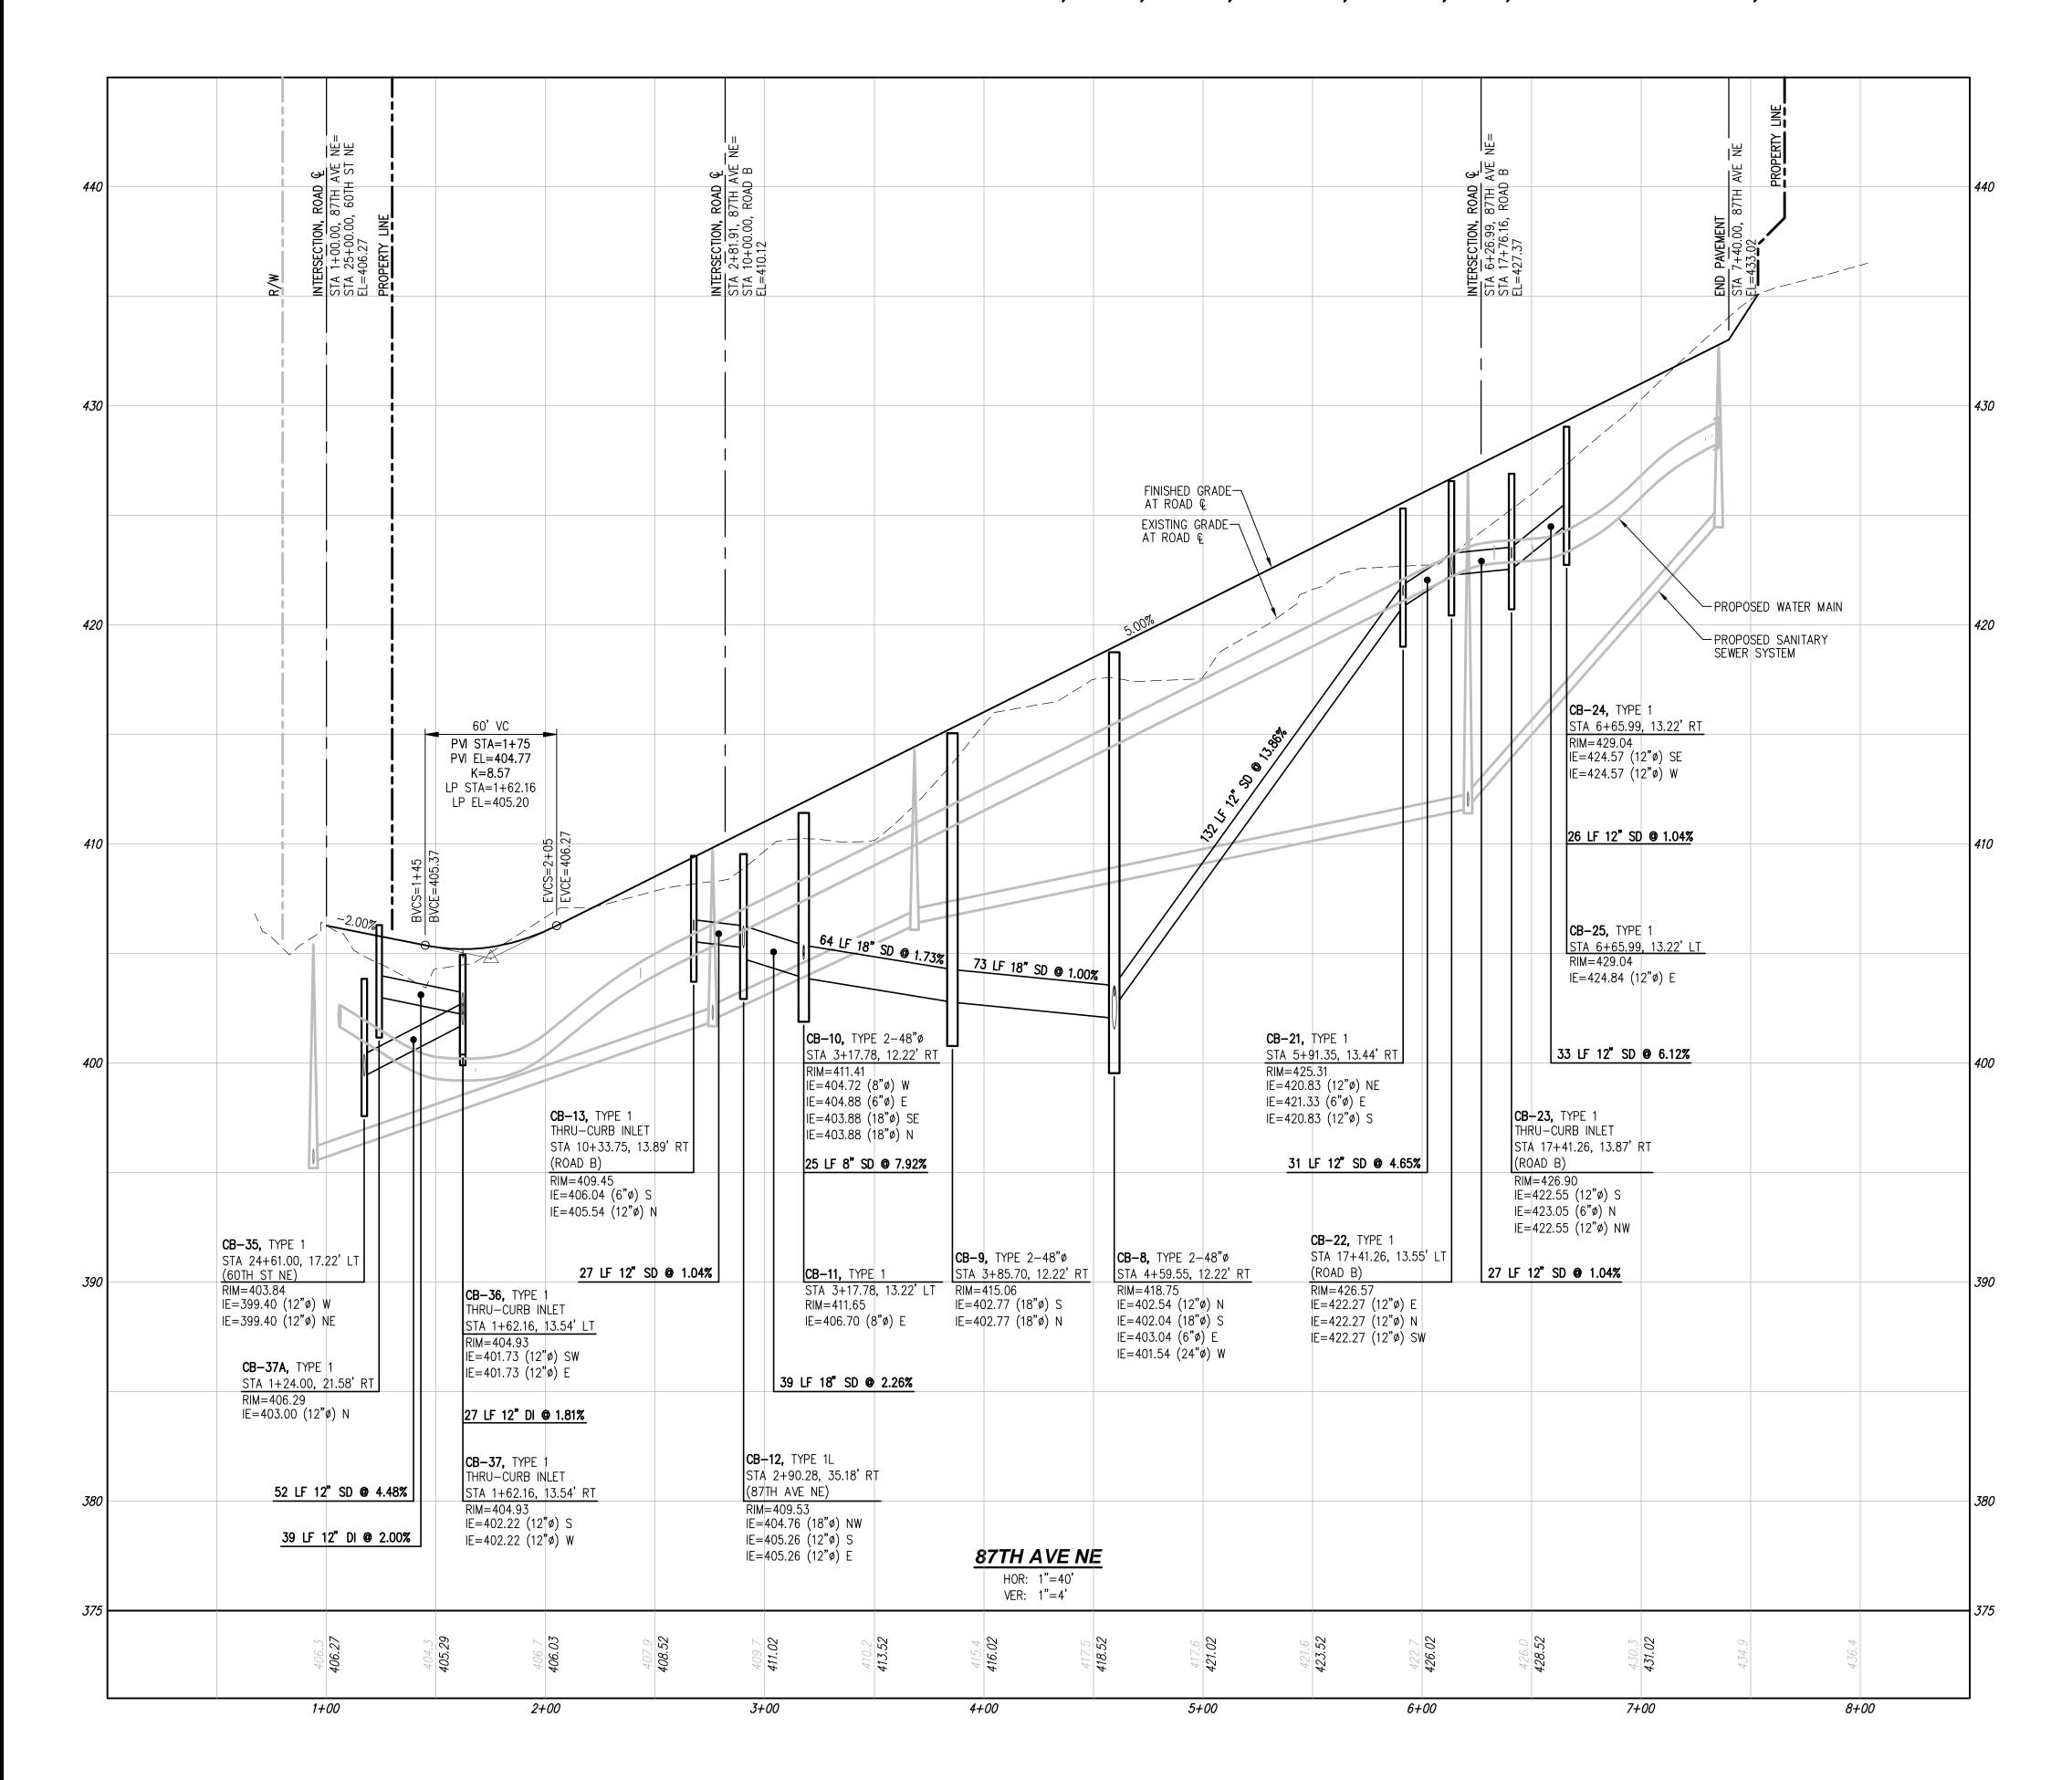
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JURISDICTION: MARYSVILL

11-15-2

BRODIE



YARD DRAIN CLEANOUT TABLE

YD #	DEPTH (FT)	RIM (FT)	IE (FT)	PIPE SIZE (IN)	DOWNSTREAM (LF)	DOWNSTREAM SLOPE
YD-1	3.50	410.08	406.58	6.00	22.0	2.5%
YD-2	3.50	413.17	409.67	6.00	38.0	8.1%
YD-3	3.50	419.41	415.91	6.00	40.0	15.6%
YD-4	3.81	428.41	424.60	6.00	24.0	2.0%
YD-5	4.10	429.67	425.57	6.00	5.0	19.4%
YD-6	3.50	440.00	436.50	6.00	45.0	7.4%
YD-7	3.50	436.65	433.15	6.00	34.0	9.3%
YD-8	3.50	433.48	429.98	6.00	23.0	10.9%
YD-9	3.50	436.93	433.43	6.00	26.0	13.3%
YD-10	3.50	439.64	436.14	6.00	20.0	13.7%
YD-11	3.50	449.40	445.90	6.00	111.0	8.8%
YD-12	3.50	450.93	447.43	6.00	40.0	3.8%
YD-13	3.50	451.89	448.39	6.00	40.0	3.4%
YD-14	3.50	450.53	447.03	6.00	42.0	4.6%
YD-15	5.05	450.16	445.11	6.00	7.0	10.9%
YD-16	3.50	457.76	454.26	6.00	40.0	15.3%
YD-17	3.50	451.63	448.13	6.00	26.0	14.5%
YD-18	3.50	448.52	445.02	6.00	40.0	4.5%
YD-19	2.73	445.96	443.23	6.00	21.0	2.0%
YD-20	3.50	441.91	438.41	6.00	40.0	13.2%
YD-21	3.50	436.65	433.15	6.00	40.0	14.0%
YD-22	3.50	431.05	427.55	6.00	39.0	7.0%
YD-23	3.50	428.32	424.82	6.00	19.0	9.3%
YD-24	4.00	425.19	421.19	6.00	5.0	18.8%
YD-25	3.50	423.75	420.25	6.00	53.0	16.9%
YD-26	3.12	417.42	414.30	6.00	40.0	2.0%
YD-27	2.63	416.13	413.50	6.00	40.0	2.0%
YD-28	2.85	415.55	412.70	6.00	5.0	21.0%
YD-29	3.41	415.06	411.65	6.00	15.0	8.6%
YD-30	2.73	415.00	412.27	6.00	31.0	2.0%
YD-31	4.29	426.00	421.71	6.00	19.0	2.0%
YD-32	3.50	426.32	422.82	6.00	35.0	3.2%
YD-33	8.25	423.01	414.76	6.00	19.0	41.3%
YD-34	13.80	420.72	406.92	6.00	20.0	19.4%
YD-35	6.08	417.77	411.69	6.00	26.0	18.3%
YD-36	2.71	415.20	412.49	6.00	40.0	2.0%
YD-37	3.50	411.25	407.75	6.00	21.0	13.7%
YD-38	7.75	428.50	420.75	6.00	26.0	19.3%
YD-39	10.86	433.00	422.14	6.00	7.0	19.9%
YD-40	6.25	436.00	429.75	6.00	39.0	19.5%
YD-41	3.50	438.00	434.50	6.00	39.0	12.2%
YD-42	3.50	439.57	436.07	6.00	40.0	3.9%
YD-43	3.15	440.37	437.22	6.00	36.0	2.0%

CITY PROJECT #: PA22-023

CITY OF MARYSVILLE CONSTRUCTION DRAWING REVIEW ACKNOWLEDGEMENT

THIS PLAN SHEET HAS BEEN REVIEWED AND EVALUATED FOR GENERAL COMPLIANCE WITH THE APPLICABLE CITY OF MARYSVILLE CODES AND ORDINANCES. CONFORMANCE OF THIS DESIGN WITH ALL APPLICABLE LAWS AND REGULATIONS IS THE FULL AND COMPLETE RESPONSIBILITY OF THE LICENSED DESIGN ENGINEER, WHOSE STAMP AND SIGNATURE APPEAR ON THIS SHEET. ACKNOWLEDGMENT OF CONSTRUCTION DRAWING REVIEW DOES NOT IMPLY CITY APPROVAL FOR CONSTRUCTION ACTIVITIES THAT REQUIRED OTHER COUNTY, STATE OR FEDERAL PERMIT REVIEW AND APPROVAL. THE PROPERTY OWNER AND LICENSED DESIGN ENGINEER SHALL BE RESPONSIBLE FOR THE ACQUISITION AND COMPLIANCE OF ALL APPLICABLE PERMITS OR AUTHORIZATIONS WHICH MAY INCLUDE, BUT ARE NOT LIMITED TO, WSDRW HYDRAULIC PROJECT APPROVAL (HPS), WSDOE NOTICE OF INTENT (NOI), ANY CORPS OF ENGINEERS FILL PERMITS AND THE REQUIREMENTS OF THE ENDANGERED SPECIES ACT.

KEN MCINTYRE, P.E., ASSISTANT CITY ENGINEER

THESE APPROVED CONSTRUCTION PLANS EXPIRE AFTER PERIOD OF 60 MONTHS FROM THE DATE SHOWN ABOVE OR UPON EXPIRATION OF PRELIMINARY PLAT OR SITE PLAN APPROVAL, PER MMC 15.09.080.

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LAND PRO GROUP,

BRODIE

	JOB NUMBER:	C22-17
	DRAWING NAME:	C22177C-RD-F
1	DESIGNER:	TP
Ш	DRAFTING BY:	DP
Ш	DATE:	11-15-2
Ш	SCALE:	1"=40
	JURISDICTION:	MARYSVILL

RD-03

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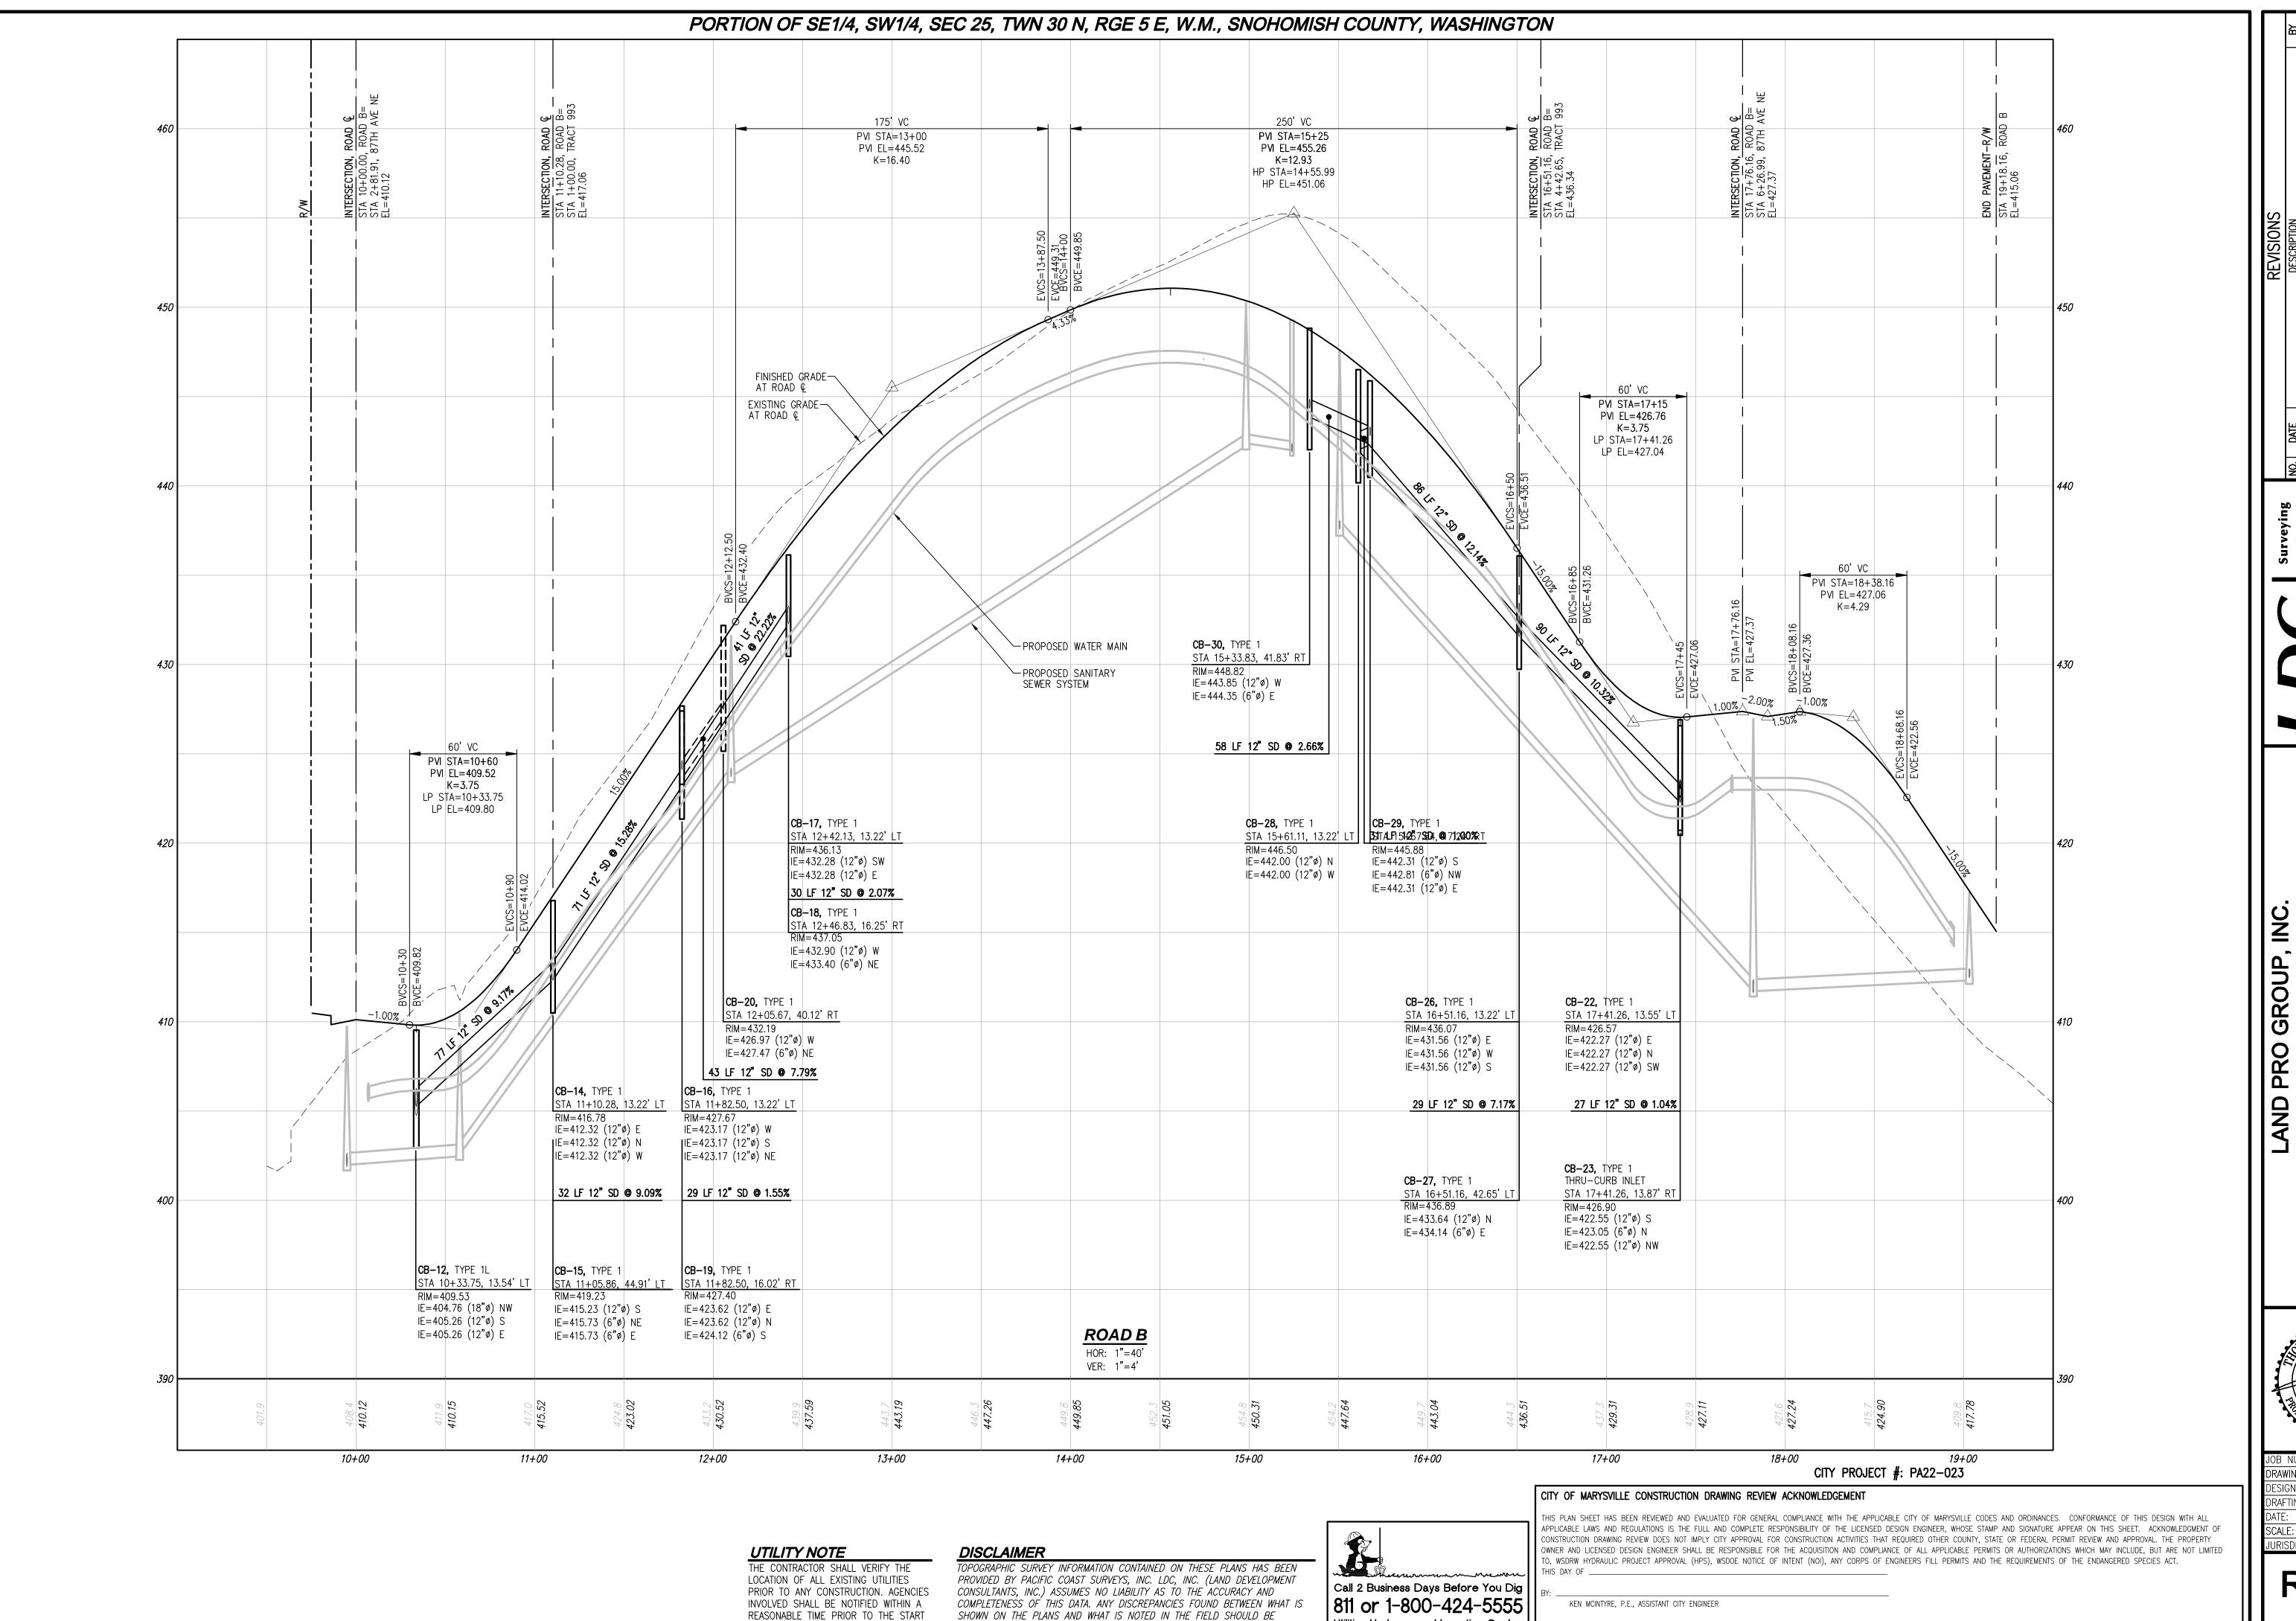
UTILITY NOTE

THE CONTRACTOR SHALL VERIFY THE LOCATION OF ALL EXISTING UTILITIES PRIOR TO ANY CONSTRUCTION. AGENCIES INVOLVED SHALL BE NOTIFIED WITHIN A REASONABLE TIME PRIOR TO THE START OF CONSTRUCTION.

DISCLAIMER

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Call 2 Business Days Before You Dig 811 or 1-800-424-5555 Utilities Underground Location Center




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OF CONSTRUCTION.

Utilities Underground Location Center

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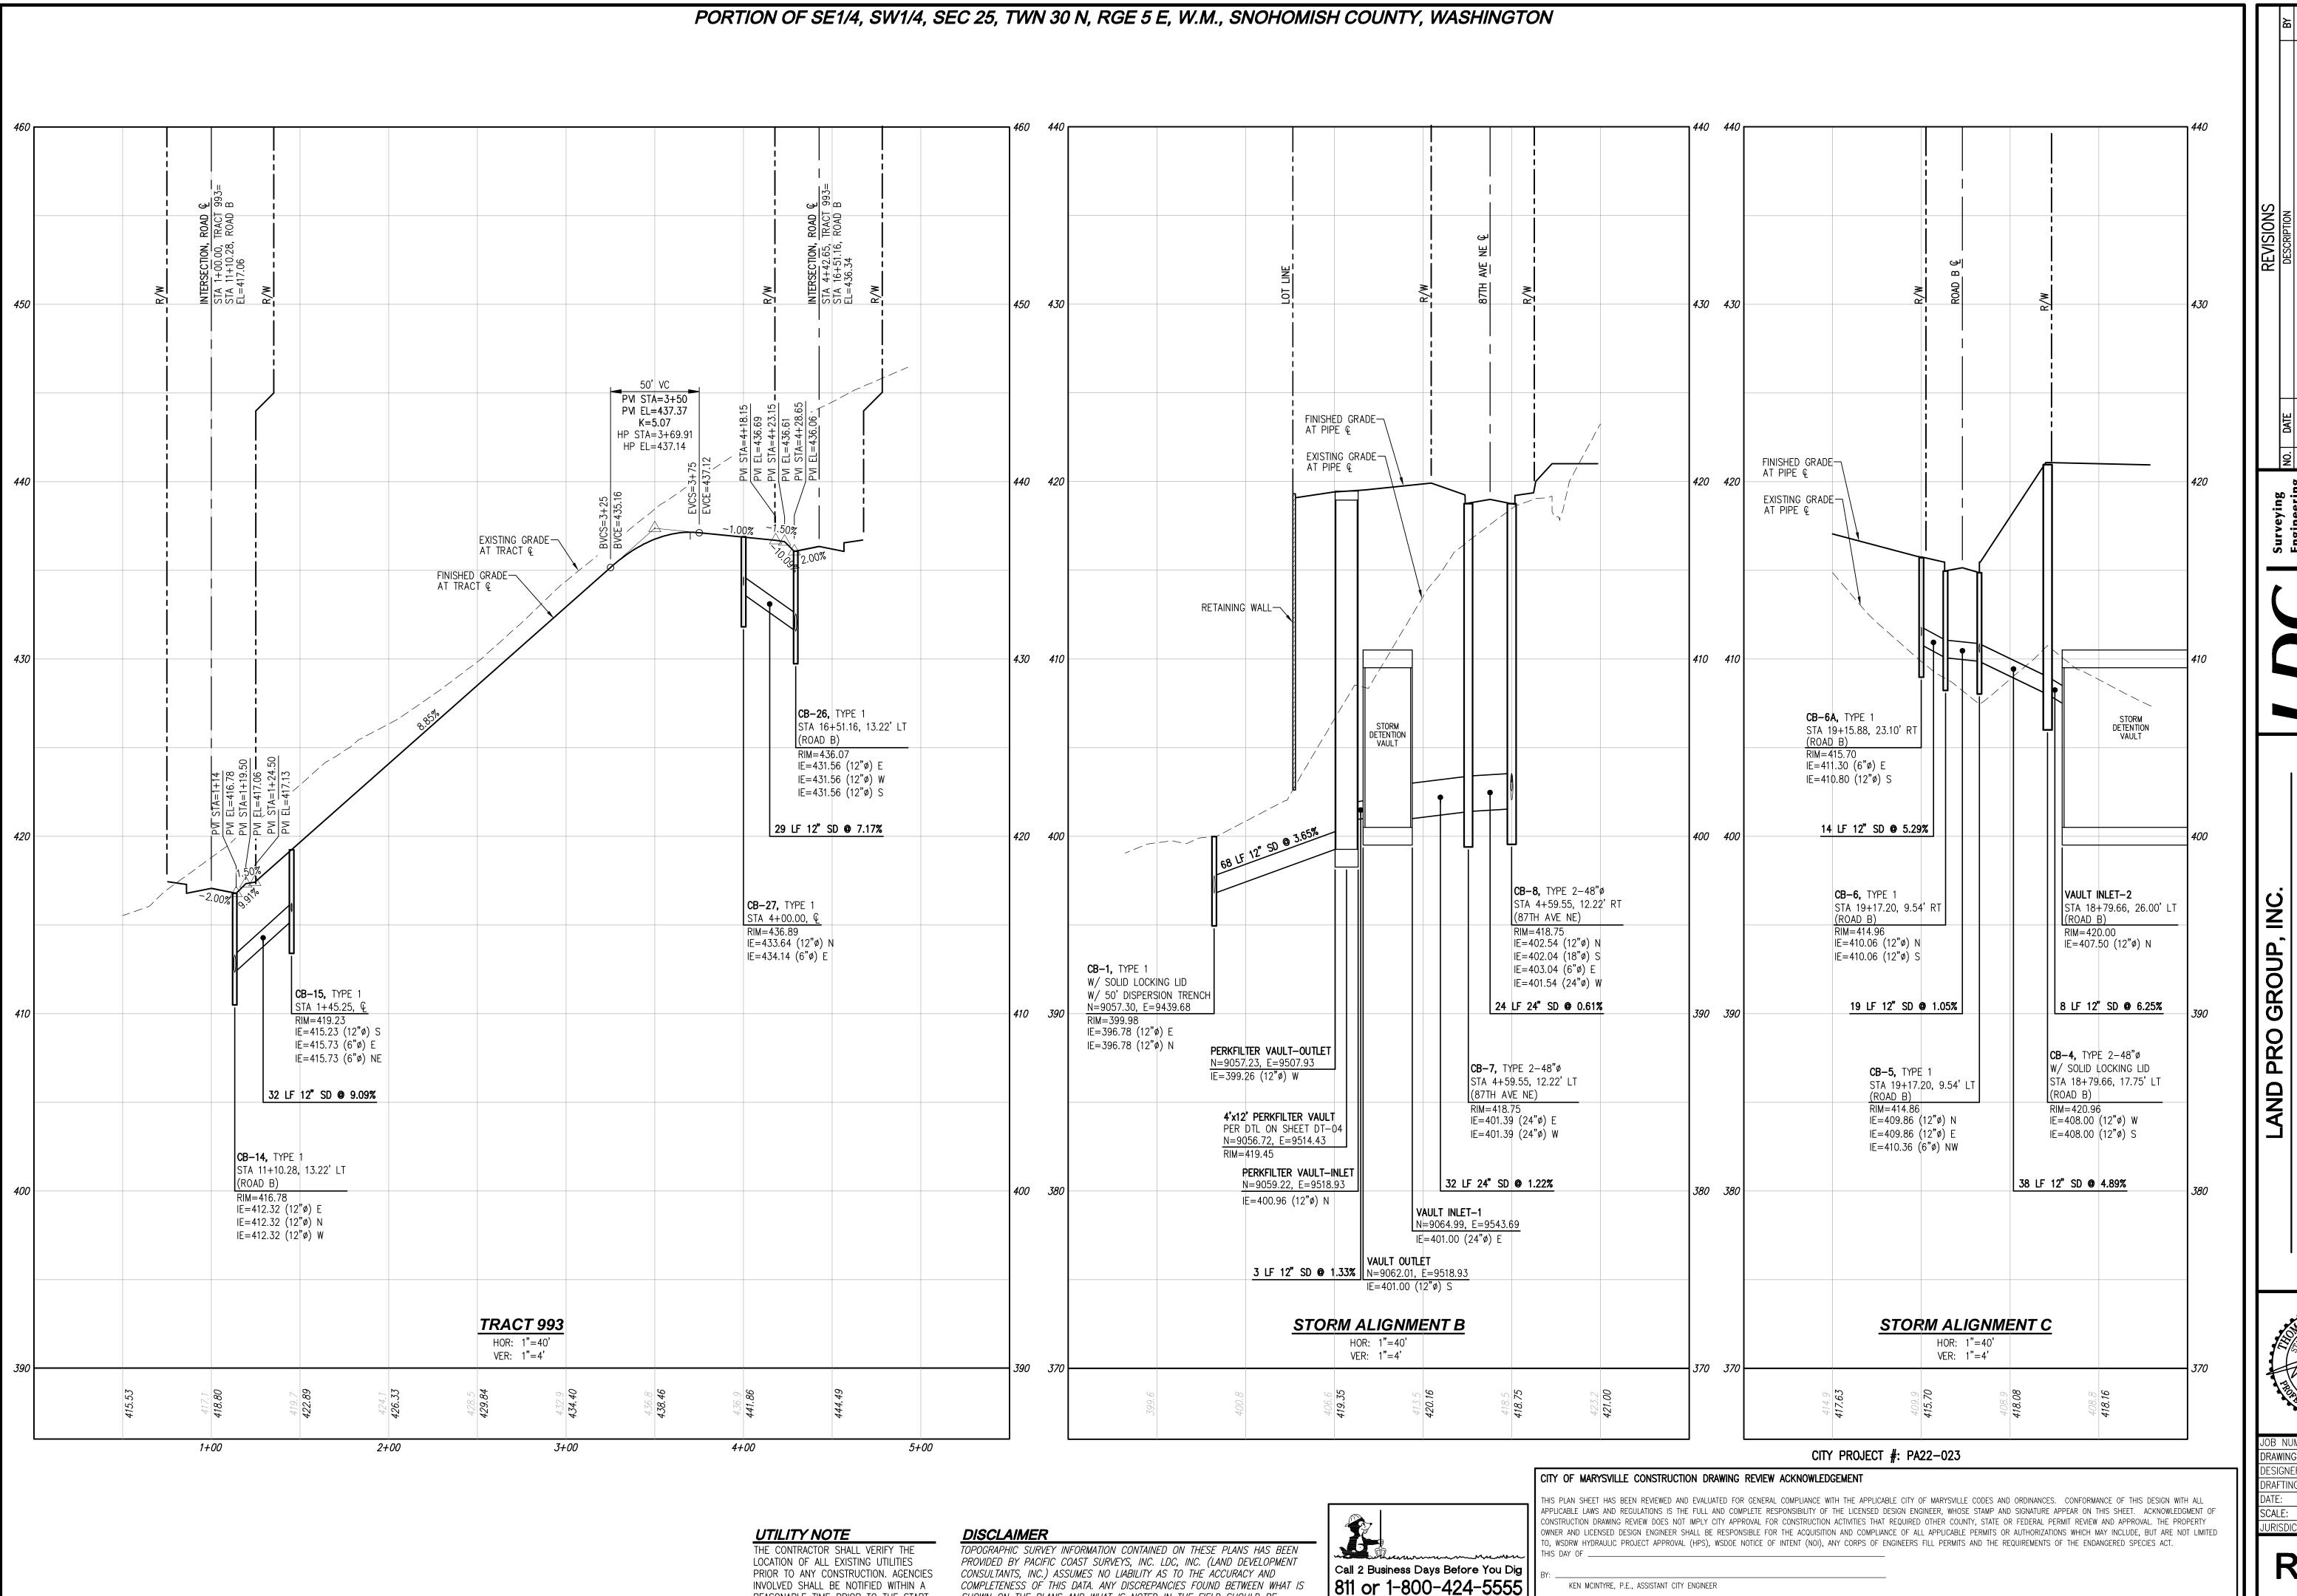
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JURISDICTION: MARYSVILL

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Utilities Underground Location Center

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REASONABLE TIME PRIOR TO THE START

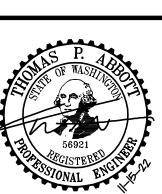
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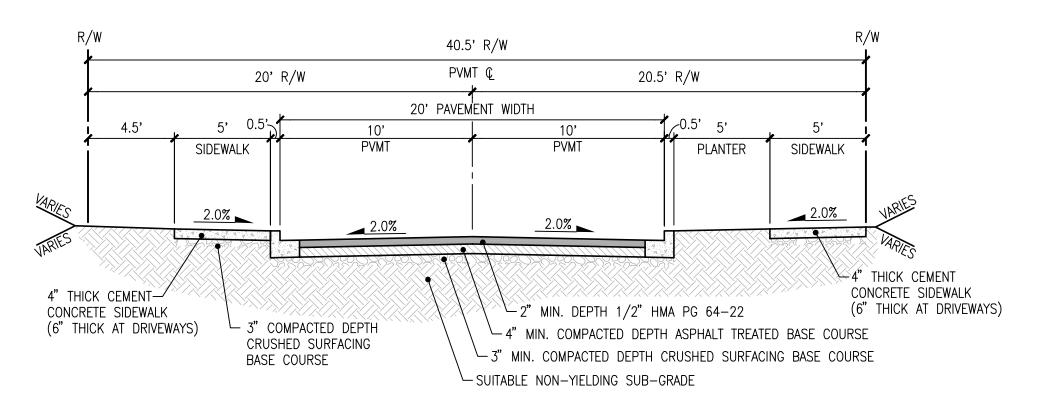
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JURISDICTION: MARYSVILL


60TH ST NE STA 21+52.02 TO STA 24+54




PROPOSED INTERNAL 50' ROW PRD ROAD SECTION (PARKING LOCATION VARIES)

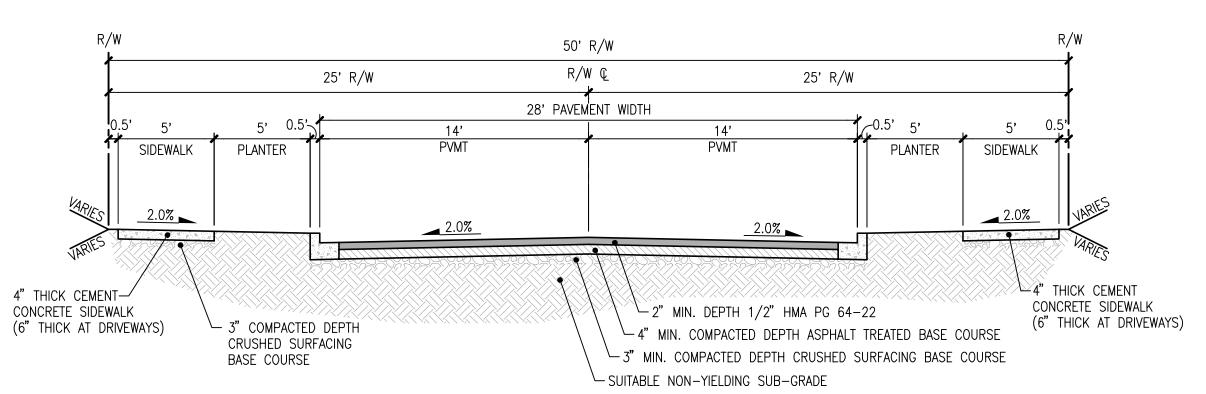

PROPOSED INTERNAL 40.5' ROW PRD ROAD SECTION (PARKING LOCATION VARIES)

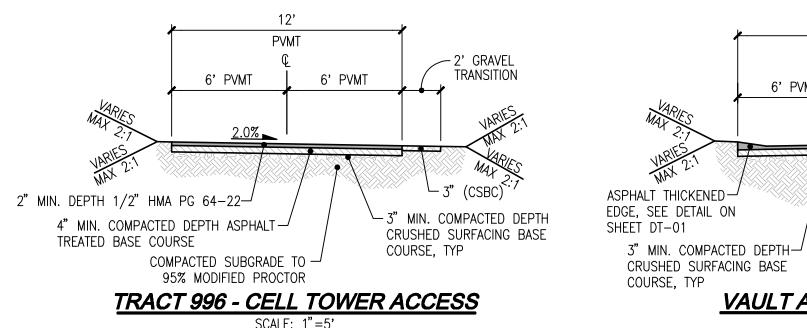

SCALE: 1"=5'

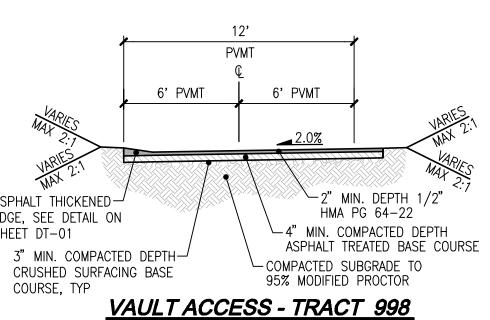

SCALE: 1"=5

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PRIOR TO ANY CONSTRUCTION. AGENCIES

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UTILITY NOTE

OF CONSTRUCTION.

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50'R/W

SAWCUT, SEE— PLAN, TYP

30'± PAVEMENT WIDTH

30'R/W

SIDEWALK

4" THICK CEMENT -

CONCRETE SIDEWALK

(6" THICK AT DRIVEWAYS)

SIDEWALK

4" THICK CEMENT— CONCRETE SIDEWALK

(6" THICK AT DRIVEWAYS)

PLANTER

-3" COMPACTED DEPTH

CRUSHED SURFACING

32' R/W

PLANTER

· 3" COMPACTED DEPTH CRUSHED SURFACING

TRACT

PVMT

TRACTS 992 AND 993 SCALE: 1"=5'

10' PVMT

√3' CONC VALLEY GUTTER

- COMPACTED SUBGRADE TO

95% MODIFIED PROCTOR

-4" BASE COURSE/CRUSHED ROCK

10' PVMT

6" THICK CEMENT CONCRETE — STAMPED PER DESIGN ON SHEET DT—01 OR EQUIVALENT

CITY APPROVED DESIGN

BASE COURSE

BASE COURSE

R∕W Ç

___ 2" MIN. DEPTH 1/2" HMA PG 64-22

SUITABLE NON-YIELDING SUB-GRADE

R∕W Ç

28' PAVEMENT WIDTH

60TH ST NE STA 25+39 TO STA 26+52.21 SCALE: 1"=5'

57'R/W

PROPOSED 87TH AVE NE ROAD SECTION

20' R/W

25'R/W

2" MIN. DEPTH 1/2" HMA PG 64-22

SUITABLE NON-YIELDING SUB-GRADE

10' PVMT

6" THICK CEMENT CONCRETE —

STAMPED PER DESIGN ON SHEET DT-01 OR EQUIVALENT CITY APPROVED DESIGN

-CONCRETE THICKENED

EDGE, SEE DETAIL ON SHEET DT-01

└─4" MIN. COMPACTED DEPTH ASPHALT TREATED BASE COURSE

└─3" MIN. COMPACTED DEPTH CRUSHED SURFACING BASE COURSE

20'

TRACT

20'

PVMT

TRACTS 994 AND 997

10' PVMT

-4" BASE COURSE/CRUSHED ROCK

COMPACTED SUBGRADE TO 95% MODIFIED PROCTOR

12'±

EX PVMT

2.0%

- 4" MIN. COMPACTED DEPTH ASPHALT TREATED BASE COURSE

─3" MIN. COMPACTED DEPTH CRUSHED SURFACING BASE COURSE

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CITY PROJECT #: PA22-023


KEN MCINTYRE, P.E., ASSISTANT CITY ENGINEER THESE APPROVED CONSTRUCTION PLANS EXPIRE AFTER PERIOD OF 60 MONTHS FROM THE DATE SHOWN ABOVE OR UPON EXPIRATION OF PRELIMINARY PLAT OR SITE PLAN APPROVAL, PER MMC 15.09.080.

EX R/W


SIDEWALK


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ALL ACCESS RIMS TO BE CLOSED, SOLID LOCKING, UNLESS OTHERWISE NOTED ON THIS SHEET.

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LAND PRO GROUP,
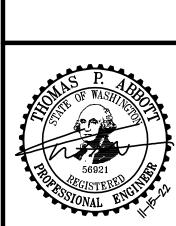
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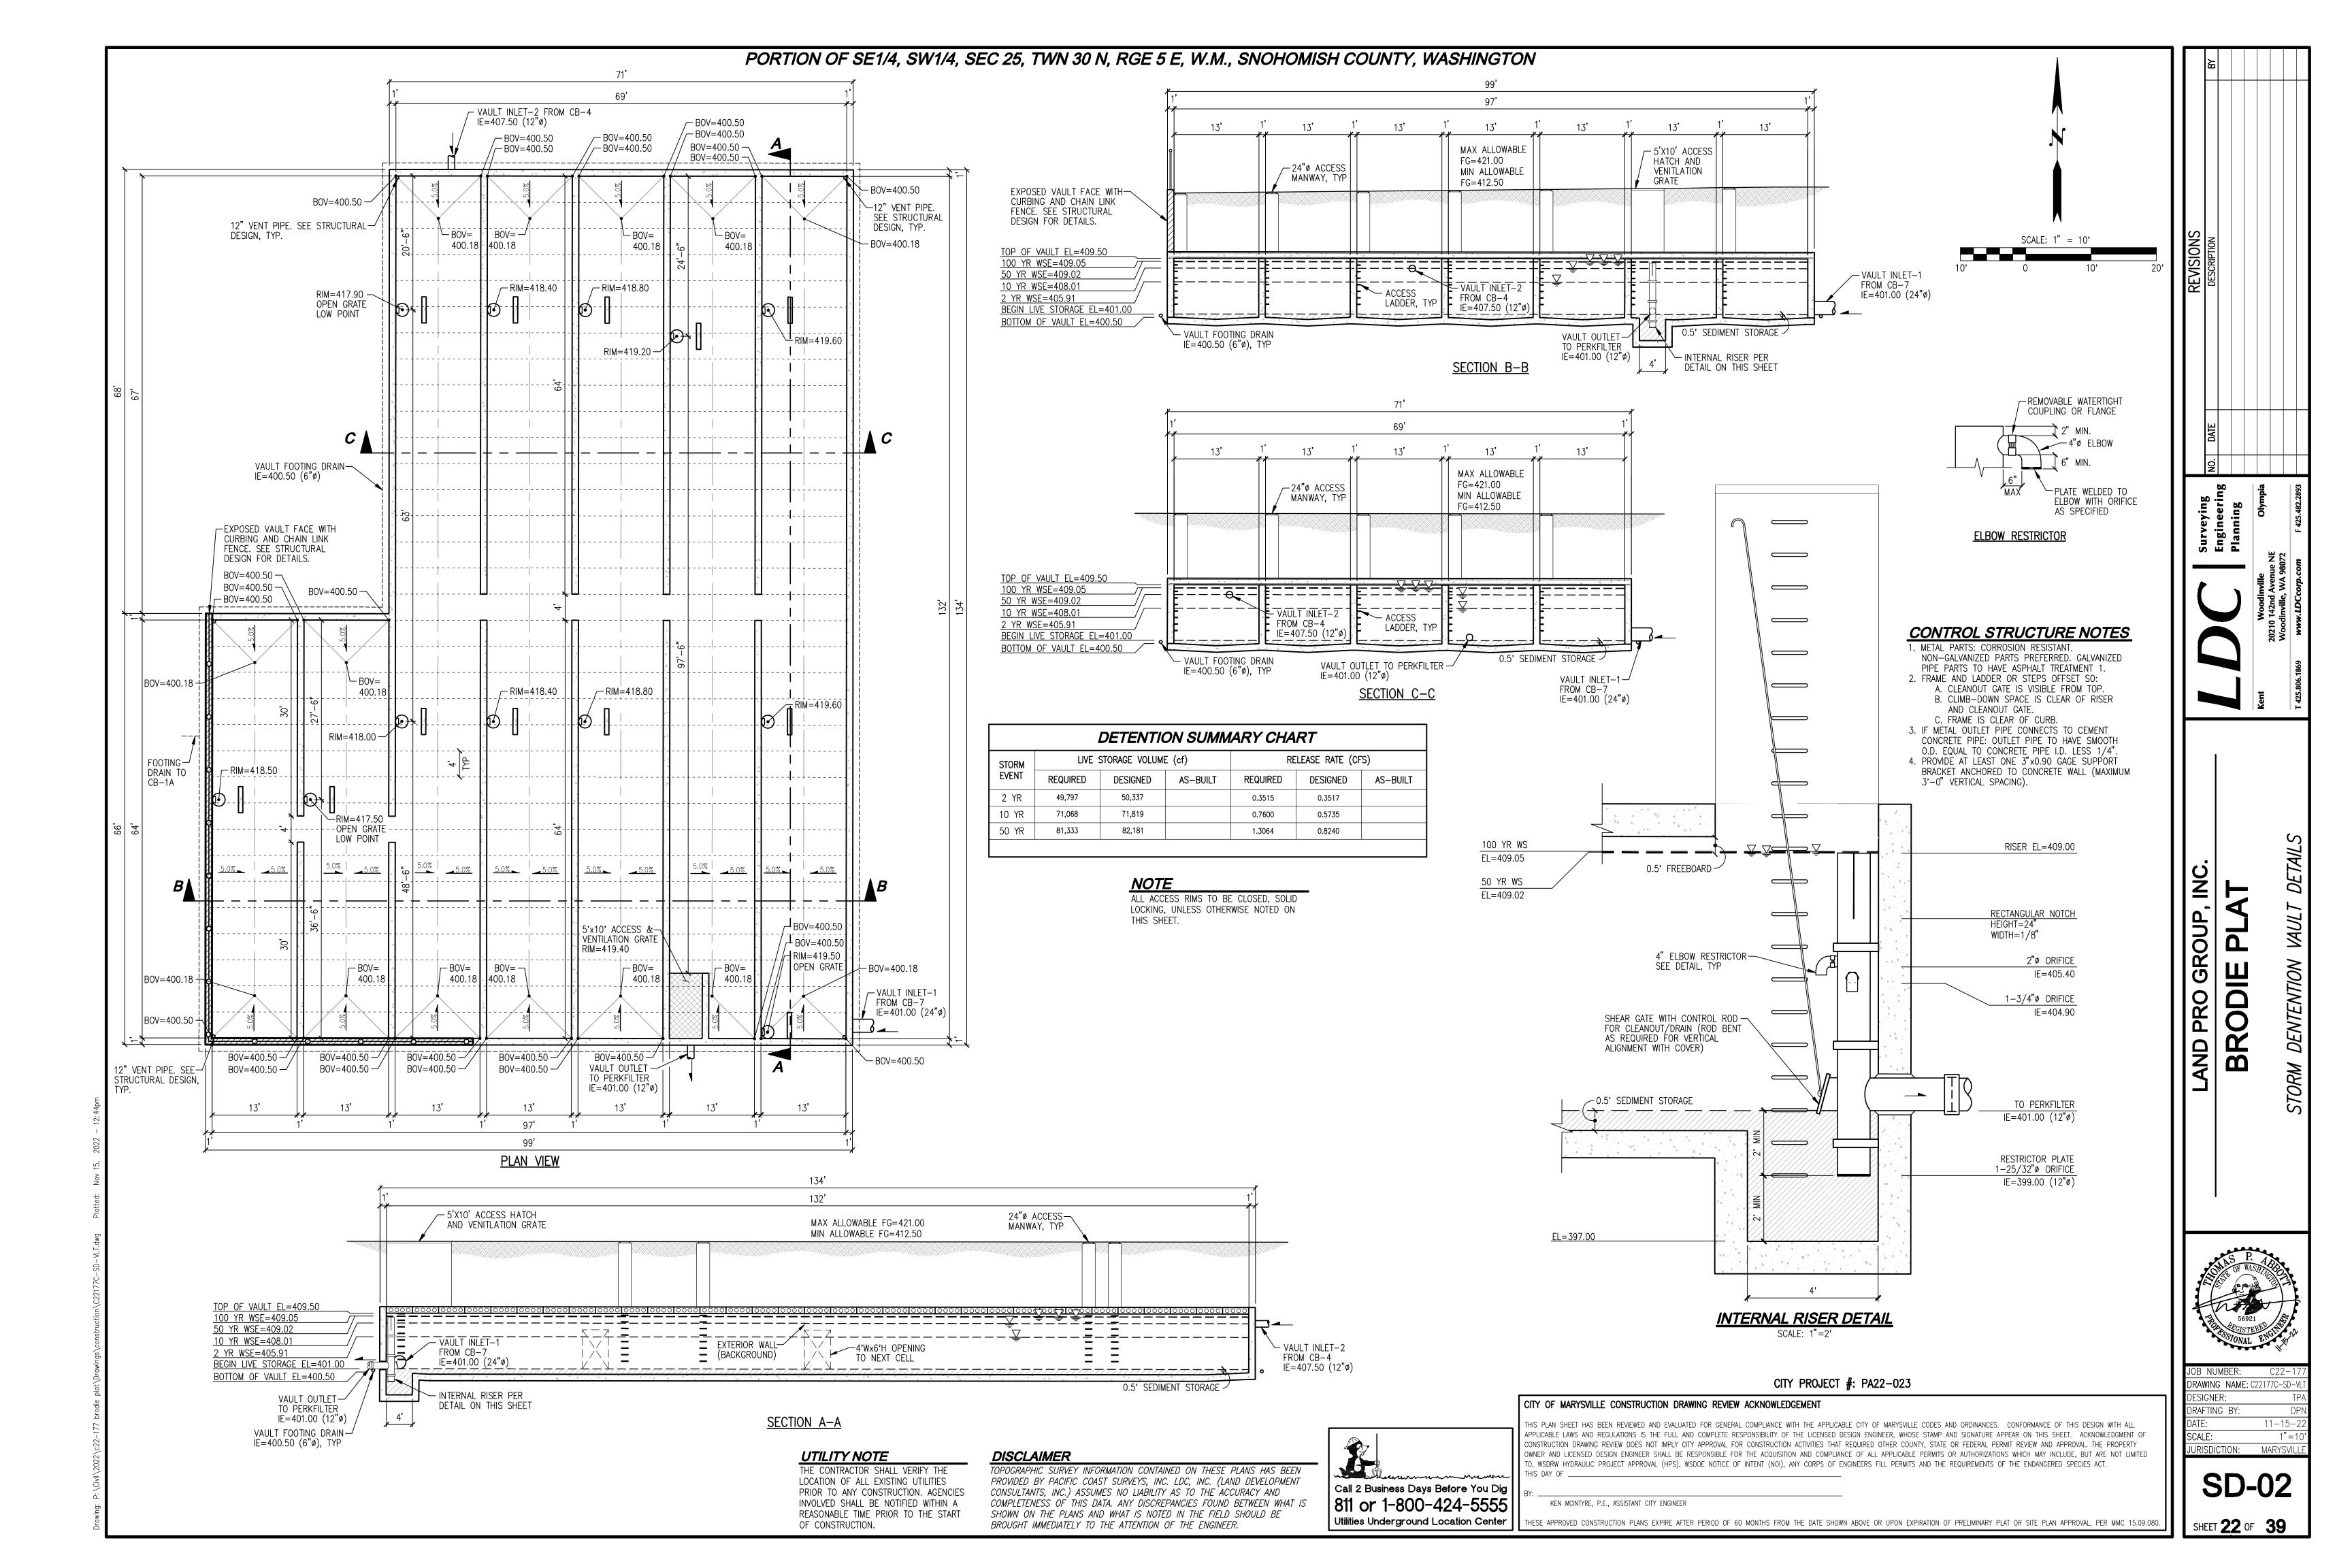
UTILITY NOTE


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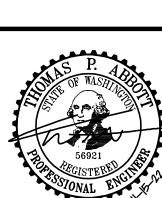


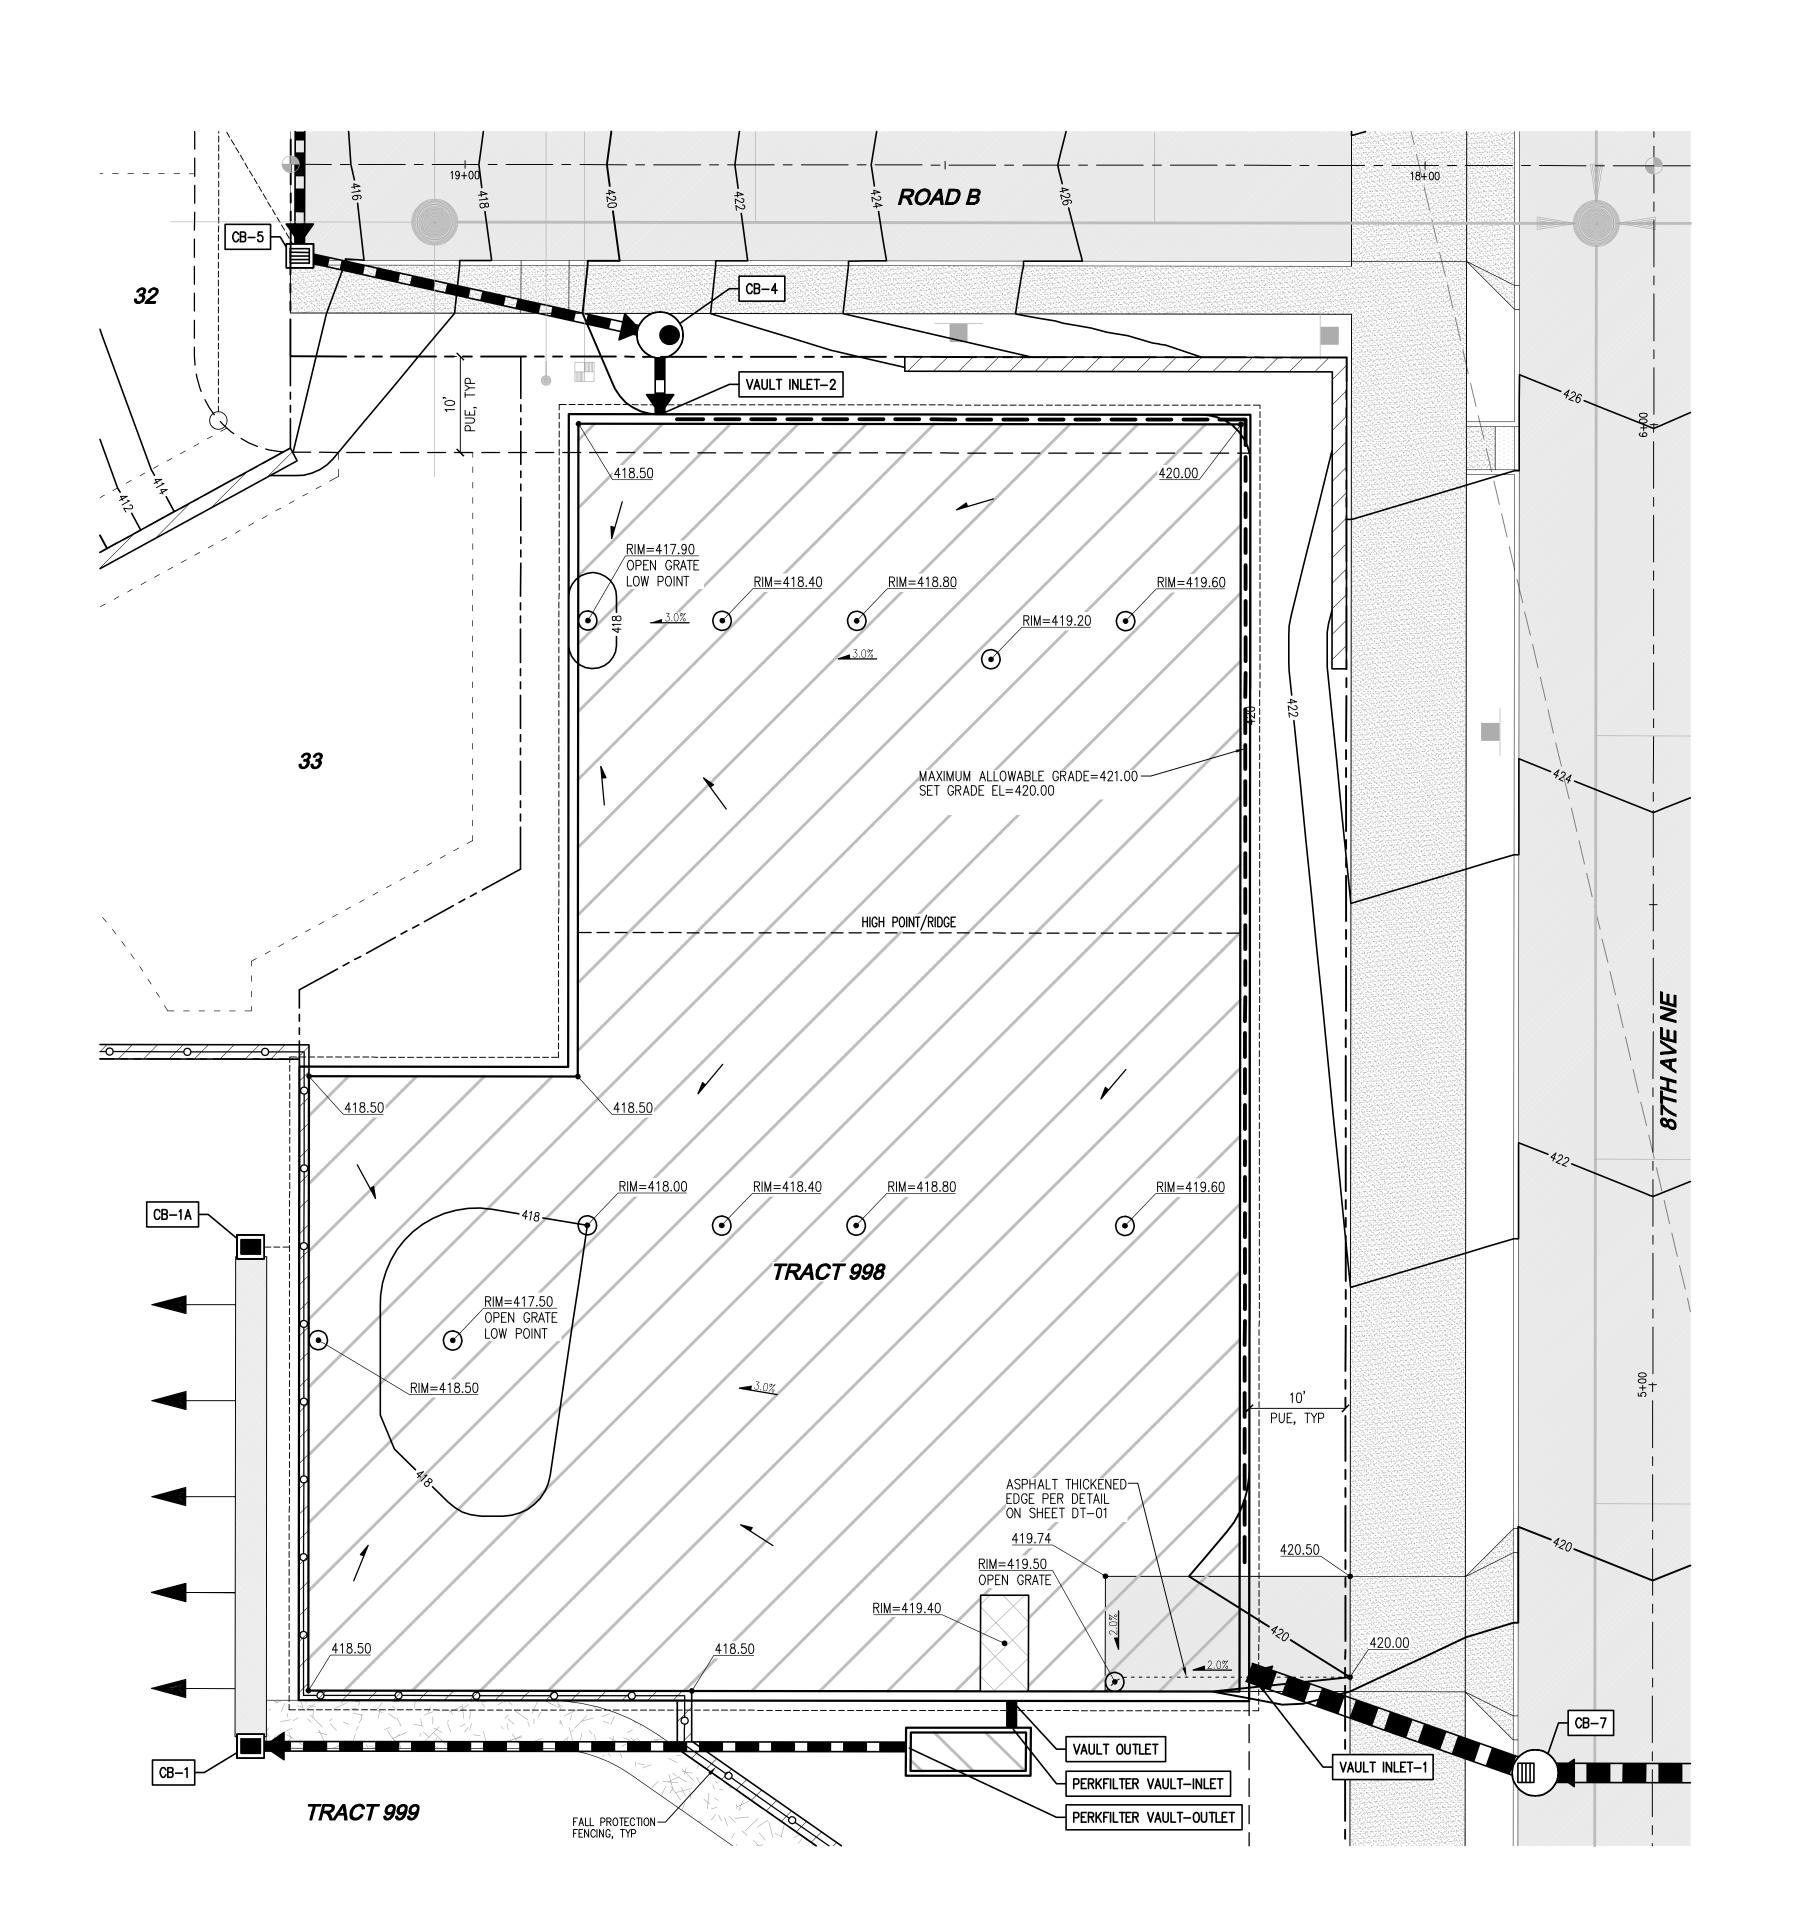

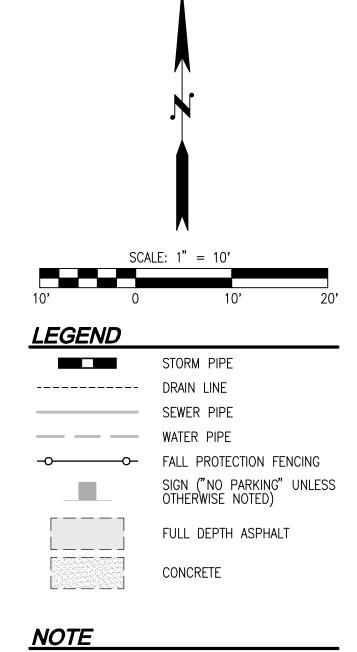BROUGHT IMMEDIATELY TO THE ATTENTION OF THE ENGINEER.

OF CONSTRUCTION.

BRODIE

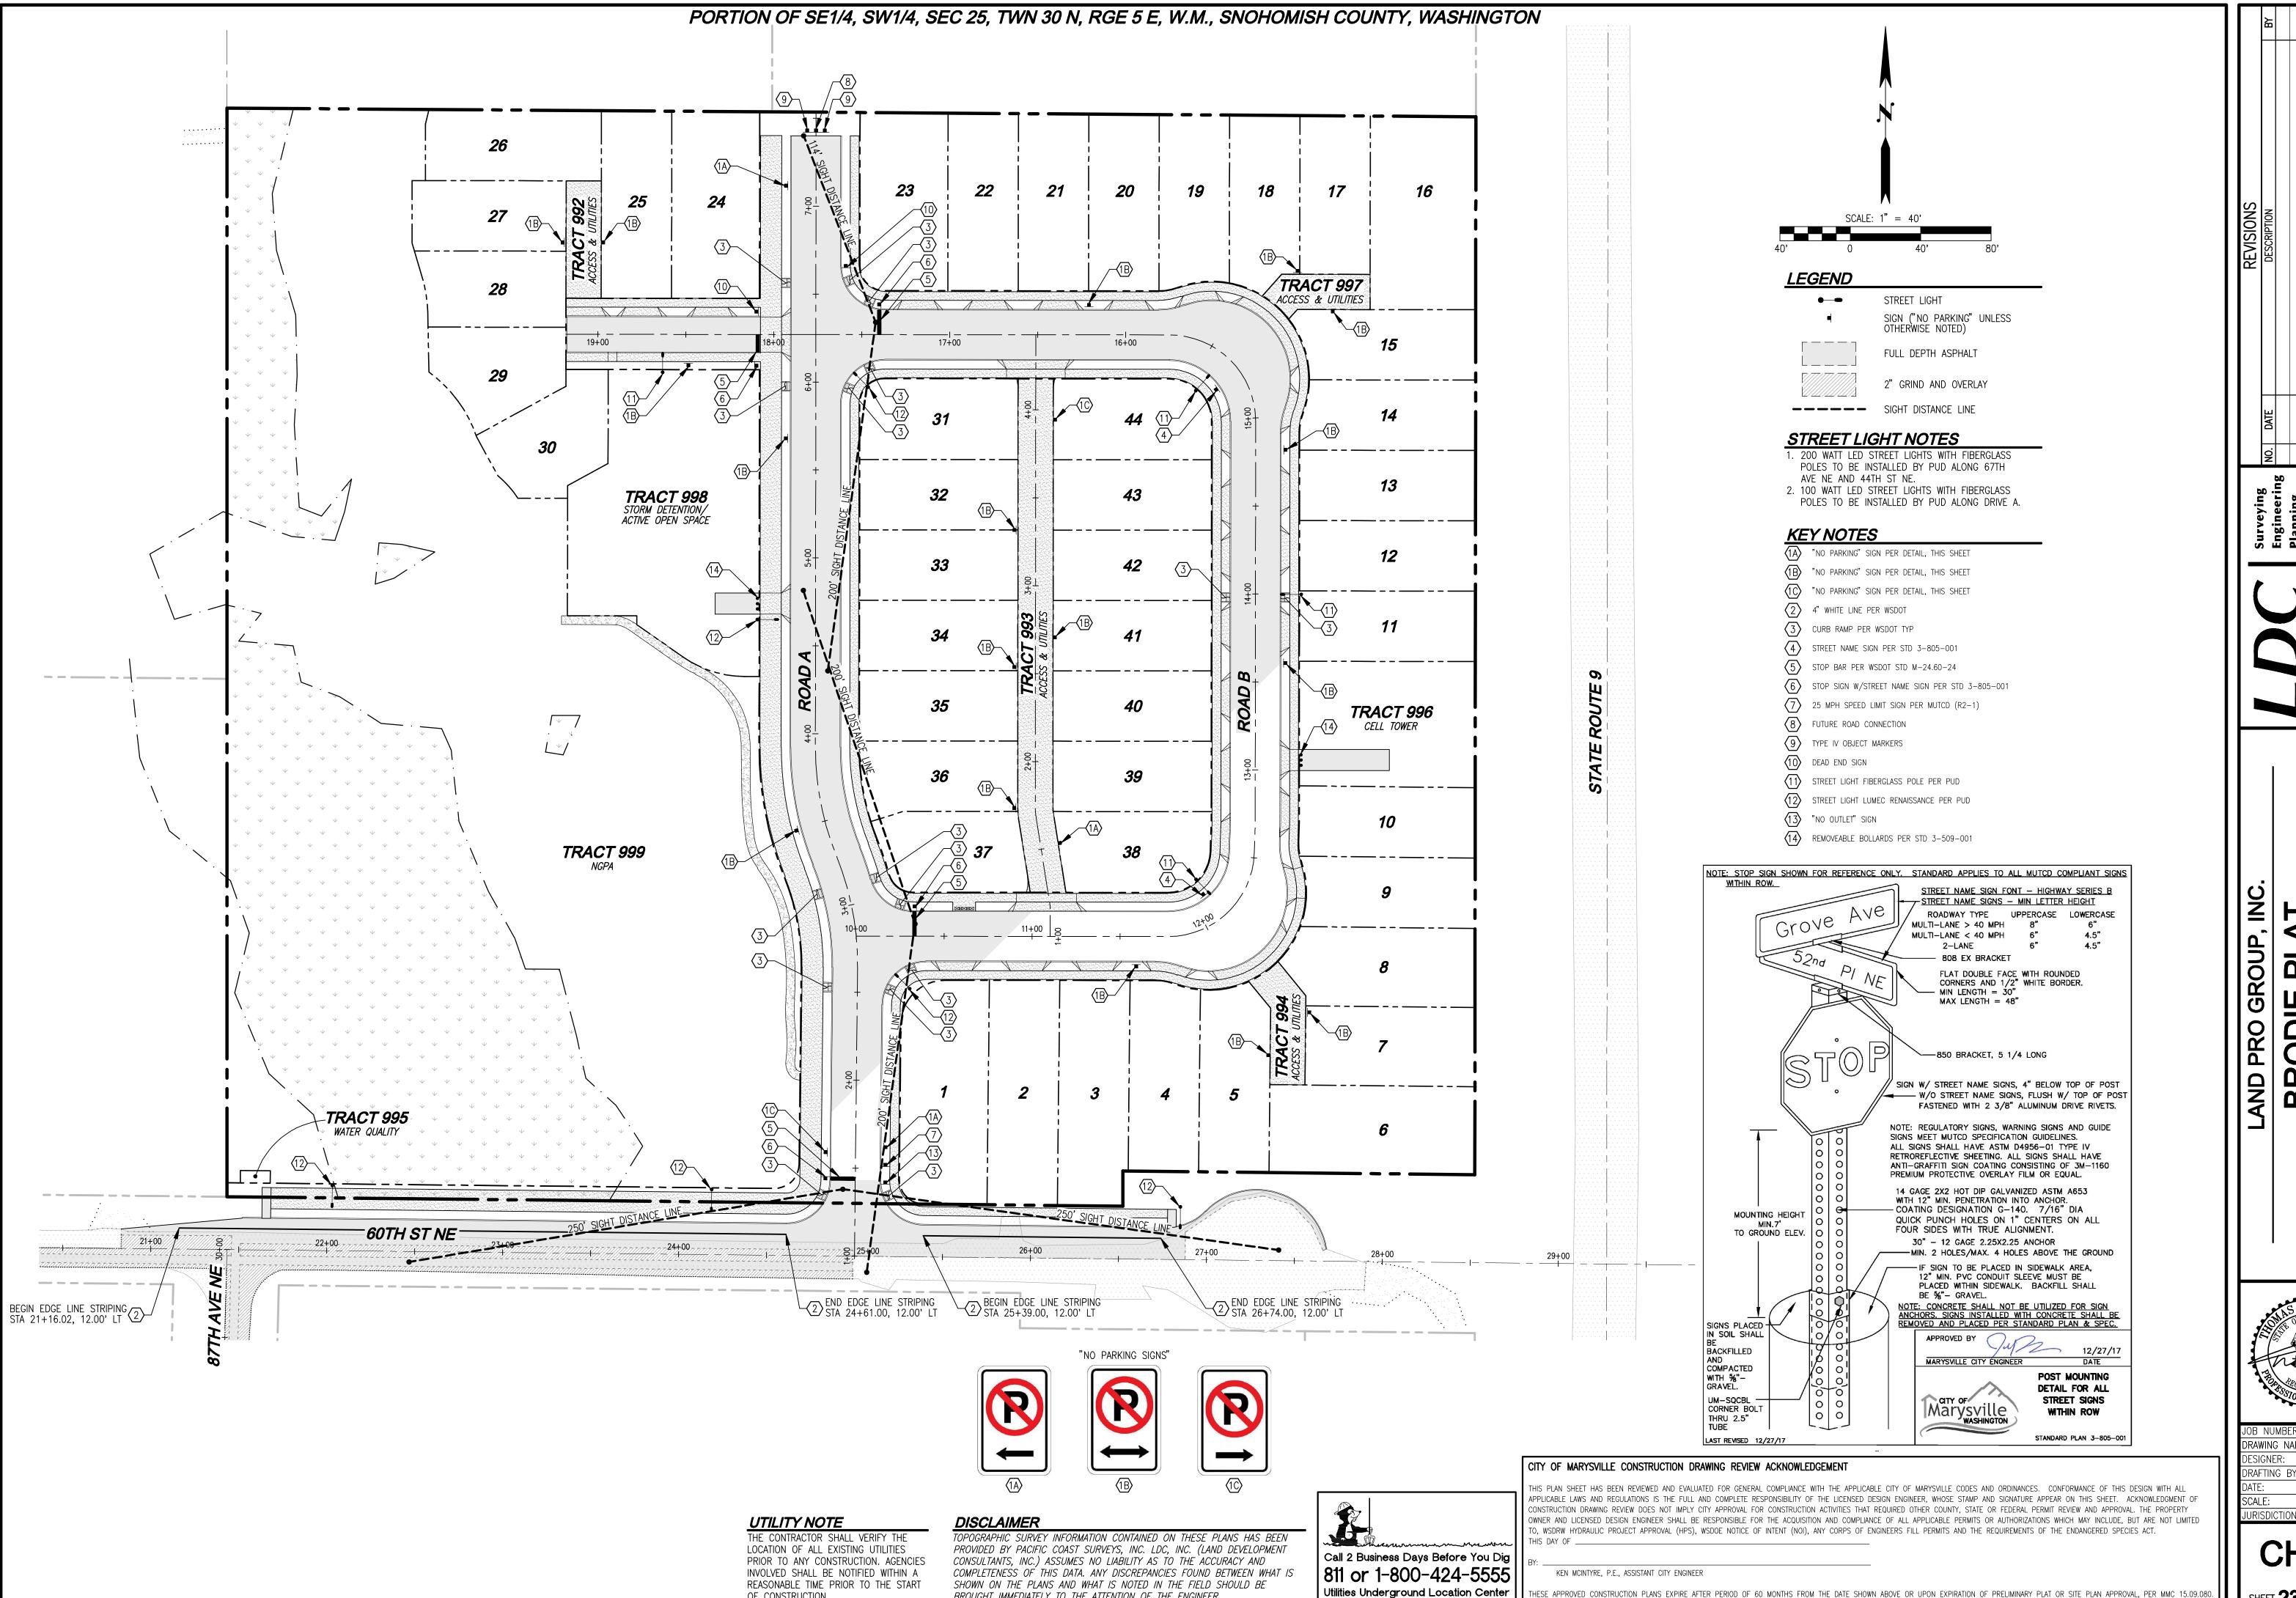

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DESIGNER:	
DRAFTING BY:	
DATE:	11-15
SCALE:	1"=

URISDICTION: MARYSVIL

GENERAL NOTES

- ALL WORK IN CITY RIGHT-OF-WAY REQUIRES A PERMIT FROM THE CITY OF MARYSVILLE. PRIOR TO ANY WORK COMMENCING, THE GENERAL CONTRACTOR SHALL ARRANGE FOR A PRECONSTRUCTION MEETING AT THE DEVELOPMENT SERVICES CENTER TO BE ATTENDED BY ALL CONTRACTORS THAT WILL PERFORM WORK SHOWN ON THE APPROVED ENGINEERING PLANS, REPRESENTATIVES FROM ALL APPLICABLE UTILITY COMPANIES, THE PROJECT OWNER AND APPROPRIATE CITY STAFF. CONTACT DEVELOPMENT SERVICES AT (360-363-8100) TO SCHEDULE THE MEETING. THE CONTRACTOR IS RESPONSIBLE TO HAVE THEIR OWN SET OF APPROVED PLANS AT THE MEETING.
- AFTER COMPLETION OF ALL ITEMS SHOWN ON THESE PLANS AND BEFORE ACCEPTANCE OF THE PROJECT THE CONTRACTOR SHALL OBTAIN A "PUNCH LIST" PREPARED BY THE CITY'S INSPECTOR DETAILING REMAINING ITEMS OF WORK TO BE COMPLETED. ALL ITEMS OF WORK SHOWN ON THESE PLANS SHALL BE COMPLETED TO THE SATISFACTION OF THE CITY PRIOR TO ACCEPTANCE OF THE WATER. SANITARY SEWER AND STORM SYSTEMS
- ALL MATERIALS AND WORKMANSHIP SHALL CONFORM TO THE STANDARD SPECIFICATIONS FOR ROAD, BRIDGE, AND MUNICIPAL CONSTRUCTION (HEREINAFTER REFERRED TO AS THE "STANDARD SPECIFICATIONS"), WASHINGTON STATE DEPARTMENT OF TRANSPORTATION AND AMERICAN PUBLIC WORKS ASSOCIATION, WASHINGTON STATE CHAPTER, LATEST EDITION, UNLESS SUPERSEDED OR AMENDED BY THE CITY OF MARYSVILLE CITY ENGINEERING DESIGN AND DEVELOPMENT STANDARDS (HEREINAFTER REFERRED TO AS THE "CITY STANDARDS")
- ALL WORK WITHIN THE DEVELOPMENT AND CITY RIGHT-OF-WAY SHALL BE SUBJECT TO THE
- INSPECTION OF THE CITY ENGINEER OR DESIGNATED REPRESENTATIVE. PRIOR TO ANY SITE CONSTRUCTION INCLUDING CLEARING/LOGGING OR GRADING, THE SITE CLEARING LIMITS SHALL BE LOCATED AND FIELD IDENTIFIED BY THE PROJECT SURVEYOR (OR PROJECT ENGINEER) AS REQUIRED BY THESE PLANS. THE PROJECT SURVEYOR'S NAME AND PHONE NUMBER IS DARREN RIDDLE, PLS AT (425) 512-7099.
- THE DEVELOPER, CONTRACTOR AND PROJECT ENGINEER IS RESPONSIBLE FOR WATER QUALITY AS DETERMINED BY THE MONITORING PROGRAM ESTABLISHED BY THE PROJECT ENGINEER. THE PROJECT ENGINEER'S NAME AND PHONE NUMBER IS MARK VILLWOCK AT (425) 806-1869. THE CONTRACTOR SHALL BE RESPONSIBLE FOR OBTAINING ALL PERMITS FOR UTILITY, ROAD, AND RIGHT-OF-WAY CONSTRUCTION. THE CONTRACTOR FOR THIS PROJECT IS TO BE
- DETERMINED. THE CONSTRUCTION STORMWATER POLLUTION PREVENTION PLAN (SWPPP) BEST MANAGEMENT PRACTICES (BMP'S) SHALL BE CONSTRUCTED IN ACCORDANCE WITH THE APPROVED SWPPP PRIOR TO ANY GRADING OR EXTENSIVE LAND CLEARING. THESE FACILITIES MUST BE SATISFACTORILY MAINTAINED UNTIL CONSTRUCTION AND LANDSCAPING IS COMPLETED AND FINAL STABILIZATION HAS OCCURRED. SEDIMENT LADEN WATERS SHALL NOT ENTER THE CITY
- STORMWATER DRAINAGE SYSTEM OR A NATURAL DRAINAGE SYSTEM. THE CONTRACTOR SHALL KEEP TWO SETS OF PLANS ON SITE AT ALL TIMES FOR RECORDING RECORD DRAWING INFORMATION; ONE SET SHALL BE SUBMITTED TO THE PROJECT ENGINEER, AND ONE SET SHALL BE SUBMITTED TO THE CITY ENGINEER AT COMPLETION OF CONSTRUCTION AND PRIOR TO FINAL ACCEPTANCE OF WORK.
-). PRIOR TO CONSTRUCTION THE OWNER AND/OR CONTRACTOR SHALL NOTIFY THE PROJECT ENGINEER AND THE CITY ENGINEER WHEN CONFLICTS EXIST BETWEEN THE PLANS AND FIELD CONDITIONS. CONFLICTS SHALL BE RESOLVED (INCLUDING PLAN AND PROFILE REVISIONS) AND RESUBMITTED FOR APPROVAL PRIOR TO PROCEEDING WITH CONSTRUCTION.
- ANY REVISIONS MADE TO THESE PLANS, OR CHANGES TO THE DESIGN MUST BE REVIEWED AND APPROVED BY THE DEVELOPER'S ENGINEER AND THE CITY PRIOR TO ANY IMPLEMENTATION IN THE FIELD. THE CITY SHALL NOT BE RESPONSIBLE FOR ANY ERRORS AND/OR OMISSIONS ON THESE PLANS.
- 12. THE CONTRACTOR SHALL HAVE ALL UTILITIES VERIFIED ON THE GROUND PRIOR TO ANY CONSTRUCTION. CALL (811) AT LEAST TWO WORKING DAYS IN ADVANCE. PRIOR TO CONSTRUCTION THE OWNER AND/OR CONTRACTOR SHALL NOTIFY THE PROJECT ENGINEER AND THE CITY ENGINEER WHEN CONFLICTS EXIST BETWEEN THE PLANS AND FIELD CONDITIONS. CONFLICTS SHALL BE RESOLVED (INCLUDING PLAN AND PROFILE REVISIONS) AND RESUBMITTED FOR APPROVAL PRIOR TO PROCEEDING WITH CONSTRUCTION
- 13. CITY OF MARYSVILLE HORIZONTAL DATUM SHALL BE NAD 83, AND THE VERTICAL DATUM SHALL BE NAVD 88, IN WASHINGTON STATE PLANE COORDINATES (FEET), WASHINGTON NORTH ZONE 4601. A LIST OF BENCHMARKS IS AVAILABLE THROUGH THE PUBLIC WORKS DEPARTMENT. 14. TEMPORARY STREET PATCHING SHALL BE ALLOWED FOR AS APPROVED BY THE CITY ENGINEER TEMPORARY STREET PATCHING SHALL BE PROVIDED BY PLACEMENT AND COMPACTION OF ATB
- OR CLASS B ASPHALT CONCRETE. CONTRACTOR SHALL BE RESPONSIBLE FOR MAINTENANCE AS REQUIRED 15. PROVIDE TRAFFIC CONTROL PLAN(S) IN ACCORDANCE WITH THE MANUAL ON UNIFORM TRAFFIC
- CONTROL DEVICES (MUTCD) AS REQUIRED. 16. IT SHALL BE THE RESPONSIBILITY OF THE CONTRACTOR TO HAVE A COPY OF THESE APPROVED
- PLANS ON CONSTRUCTION SITE AT ALL TIMES. ANY STRUCTURE AND/OR OBSTRUCTION THAT REQUIRES REMOVAL OR RELOCATION RELATING TO THIS PROJECT SHALL BE DONE SO AT THE DEVELOPER'S EXPENSE.
- 18. LOCATIONS OF EXISTING UTILITIES ARE APPROXIMATE. IT SHALL BE THE CONTRACTOR'S RESPONSIBILITY TO DETERMINE THE TRUE ELEVATIONS AND LOCATIONS OF HIDDEN UTILITIES. ALL VISIBLE ITEMS SHALL BE THE ENGINEER'S RESPONSIBILITY. LOCATION OF UTILITIES SHOWN ON CONSTRUCTION PLANS ARE BASED ON BEST RECORDS AVAILABLE AND ARE SUBJECT TO VARIATION. FOR ASSISTANCE IN UTILITY LOCATION, CALL 1-800-424-5555
- 19. THE CONTRACTOR SHALL INSTALL, REPLACE, OR RELOCATE ALL SIGNS, AS SHOWN ON THE PLANS OR AS AFFECTED BY CONSTRUCTION, PER CITY STANDARDS. 20. POWER, STREET LIGHT, CABLE, AND TELEPHONE LINES SHALL BE IN A TRENCH LOCATED WITHIN
- A 10-FOOT UTILITY EASEMENT ADJACENT TO PUBLIC RIGHT-OF-WAY. RIGHT-OF-WAY CROSSINGS SHALL HAVE A MINIMUM HORIZONTAL SEPARATION FROM OTHER UTILITIES (SEWER, WATER, AND STORM) OF 5 FEET.
- 21. ALL CONSTRUCTION SURVEYING FOR EXTENSIONS OF PUBLIC FACILITIES SHALL BE DONE UNDER THE DIRECTION OF A WASHINGTON STATE LICENSED LAND SURVEYOR OR A WASHINGTON STATE LICENSED PROFESSIONAL CIVIL ENGINEER.
- 22. DURING CONSTRUCTION, ALL PUBLIC STREETS ADJACENT TO THIS PROJECT SHALL BE KEPT CLEAN OF ALL MATERIAL DEPOSITS RESULTING FROM ON-SITE CONSTRUCTION, AND EXISTING STRUCTURES SHALL BE PROTECTED AS DIRECTED BY THE CITY
- 23. CERTIFIED RECORD DRAWINGS ARE REQUIRED PRIOR TO PROJECT ACCEPTANCE 24. A NPDES STORMWATER GENERAL PERMIT MAY BE REQUIRED BY THE DEPARTMENT OF ECOLOGY

FOR THIS PROJECT. FOR INFORMATION VISIT THE DEPARTMENT OF ECOLOGY WEB SITE

- WWW.ECY.WA.GOV/PROGRAMS/WQ/STORMWATER/CONSTRUCTION/ 25. ANY DISTURBANCE OR DAMAGE TO CRITICAL AREAS AND ASSOCIATED BUFFERS, OR SIGNIFICANT TREES DESIGNATED FOR PRESERVATION AND PROTECTION SHALL BE MITIGATED IN ACCORDANCE WITH A MITIGATION PLAN REVIEWED AND APPROVED BY THE CITY'S PLANNING DIVISION.
- PREPARATION AND IMPLEMENTATION OF THE MITIGATION PLAN SHALL BE AT THE DEVELOPER'S EXPENSE. 26. A GRADING PERMIT ISSUED PURSUANT TO THE CURRENT ADOPTED INTERNATIONAL BUILDING CODE, AND APPROVAL OF THE TEMPORARY EROSION AND SEDIMENTATION CONTROL PLAN SHALL BE OBTAINED FROM THE COMMUNITY DEVELOPMENT DEPARTMENT PRIOR TO ANY ON-SITE GRADING WORK NOT EXPRESSLY EXEMPT BY THE CURRENT ADOPTED INTERNATIONAL BUILDING
- . PRIOR TO COMMENCEMENT OF FRAMING, FINAL DRAINAGE INSPECTION AND APPROVAL OF THE ROOF LEADER AND POSITIVE FOOTING SYSTEMS SHALL BE COMPLETED BY THE BUILDING DEPARTMENT. CALL 360-363-8100 TO SCHEDULE THE INSPECTION

ROADWAY NOTES

- MONUMENTS SHALL BE INSTALLED AT ALL STREET INTERSECTIONS, AT ANGLE POINTS, AND POINTS OF CURVATURE IN EACH STREET. ALL BOUNDARY MONUMENTS MUST BE INSTALLED ACCORDING TO THE WASHINGTON STATE SUBDIVISION LAWS.
- CURB AND GUTTER INSTALLATION SHALL CONFORM TO CITY STANDARD DETAIL 3-514. SIDEWALKS AND DRIVEWAYS SHALL BE INSTALLED AS LOTS ARE BUILT ON OR PRIOR TO FINAL PLAT APPROVAL. SIDEWALKS AND DRIVEWAYS SHALL CONFORM TO CITY STANDARD DETAIL 3-303-001 AND -002. IF ASPHALT IS DAMAGED DURING REPLACEMENT OF CURB AND GUTTER, THE REPAIR SHALL CONFORM TO CITY STANDARD DETAIL 3-514-001
- THE SURROUNDING GROUND (5 FEET BEYOND THE BASE) FOR ALL POWER TRANSFORMERS, TELEPHONE/TV PEDESTALS, AND STREET LIGHT MAIN DISCONNECTS SHALL BE GRADED TO A POSITIVE 2 PERCENT SLOPE FROM TOP OF CURB.
- SIGNAGE AND TRAFFIC CONTROL DEVICES ARE SAFETY ITEMS AND SHALL BE INSTALLED PRIOR TO ISSUANCE OF ANY CERTIFICATE OF OCCUPANCY OR PLAT APPROVAL. HOWEVER, IN LARGER DEVELOPMENTS, EXACT LOCATIONS OF STOP AND YIELD SIGNS MAY NEED TO BE DETERMINED AFTER FULL BUILDOUT WHEN TRAFFIC PATTERNS HAVE BEEN ESTABLISHED. IN THIS CASE, CONTRACTOR SHALL PROVIDE INDICATED "CITY-PLACED" SIGNS, SIGNPOSTS, AND BRACKETS TO THE CITY SIGN SPECIALIST (425) 328-7954 FOR LATER INSTALLATION BY THE CITY, ALL SIGNAGE SHALL BE IN ACCORDANCE WITH THE MANUAL ON UNIFORM TRAFFIC CONTROL DEVICES
- PRIOR TO ANY SIGN OR STRIPING INSTALLATION OR REMOVAL THE CONTRACTOR SHALL CONTACT THE CITY SIGN SPECIALIST (425) 328-7954 TO ARRANGE FOR AN ON-SITE MEETING TO
- DISCUSS PLACEMENT AND UNIFORMITY. NEW OR REVISED STOP SIGNS OR YIELD SIGNS SHALL BE ADVANCE WARNED USING THE PROCEDURE OUTLINED IN THE MUTCD. ADVANCE WARNING SIGNS AND FLAGS SHALL BE MAINTAINED BY INSTALLER FOR 30 DAYS AND THEN REMOVED.

STORM DRAINAGE NOTES

- DURING CONSTRUCTION, ALL EXISTING AND NEWLY INSTALLED DRAINAGE
- STRUCTURES SHALL BE PROTECTED FROM SEDIMENTS. 2. ALL STORM MANHOLES SHALL CONFORM TO CITY STANDARD DETAIL NO.4-08-009. FLOW CONTROL MANHOLE/OIL WATER SEPARATOR SHALL CONFORM TO CITY STANDARD DETAIL NO. 4-040-004.
- MANHOLE RING AND COVER SHALL CONFORM TO CITY STANDARD DETAIL 4-08-009 AND 4-080-15 THRU 4-080-024. THE COVER SHALL BE MARKED WITH "STORM" OR "DRAIN" IN 2-INCH RAISED LETTERS. MINIMUM WEIGHT OF THE FRAME SHALL BE 210 POUNDS. MINIMUM WEIGHT OF THE COVER SHALL BE 150 POUNDS.
- 4. CATCH BASINS SHALL BY TYPE I UNLESS OTHERWISE APPROVED BY THE CITY ENGINEER OR DESIGNATED REPRESENTATIVE. TYPE I CATCH BASINS SHALL CONFORM TO CITY STANDARD DETAIL NO.4-080-007 AND 4-080-008 AND SHALL BE USED ONLY FOR DEPTHS LESS THAN 5 FEET FROM TOP OF THE GRATE TO THE INVERT OF THE STORM PIPE.
- 5. CATCH BASINS TYPE II SHALL CONFORM TO CITY STANDARD DETAIL NO. 4-08-009 AND SHALL BE USED FOR DEPTHS GREATER THAN 5 FEET FROM TOP OF THE GRATE TO THE INVERT OF THE STORM PIPE.
- 6. CAST IRON OR DUCTILE IRON FRAME AND GRATE SHALL CONFORM TO CITY STANDARD DETAIL NO.4-080-022. GRATE SHALL BE MARKED WITH "DRAINS TO STREAM". SOLID CATCH BASIN LIDS (SQUARE UNLESS NOTED AS ROUND) SHALL CONFORM TO WSDOT STANDARD PLAN B-30.20-02 (OLYMPIC FOUNDRY NO. SM60, SM52, OR SM44 OR EQUAL). VANED GRATES SHALL BE REQUIRED ON ALL STORM STRUCTURES WHEN ROADWAY PROFILE IS GREATER THAN 3% AND SHALL CONFORM TO WSDOT STANDARD PLAN B-30.30-01 (OLYMPIC FOUNDRY NO. SM60V OR EQUAL). GRATES LOCATED IN THE GUTTER FLOW LINE SHALL BE DEPRESSED 0.1 FEET BELOW PAVEMENT LEVEL.
- 7. ALL CATCH BASINS AND MANHOLES LOCATED OUTSIDE OF PAVED AREAS. SHALL BE PLACED IN A SIX FOOT SQUARE BY FOUR INCH THICK CONCRETE PAD. 8. ALL CATCH BASINS AND MANHOLES SHALL HAVE LOCKING LIDS. ROLLED GRATES ARE NOT APPROVED FOR USE OUTSIDE OF THE CITY RIGHT-OF-WAY OR FOR
- USE WITH TYPE II MANHOLES. 9. CONTRACTOR SHALL BE RESPONSIBLE FOR ADJUSTING ALL MANHOLE, INLET AND CATCH BASIN FRAMES AND GRATES TO GRADE JUST PRIOR TO CURB INSTALLATION AND/OR PAVING.
- 10. TRENCHING, BEDDING, AND BACKFILL FOR PIPE SHALL CONFORM TO CITY STANDARD DETAIL NO. 3-703-002 AND-003.
- 11. TRENCH BACKFILL OF NEW UTILITIES AND STORMWATER DRAINAGE SYSTEM FEATURES SHALL BE COMPACTED TO 95% MAXIMUM DENSITY (MODIFIED PROCTOR) UNDER ROADWAYS AND 90% MAXIMUM DENSITY (MODIFIED PROCTOR) OFF ROADWAYS. COMPACTION SHALL BE PERFORMED IN ACCORDANCE WITH SECTIONS 7-08.3(3) AND 2-03.3(14)C - METHOD B AS DEFINED IN THE CURRENT EDITION OF THE WSDOT STANDARD SPECIFICATIONS FOR ROAD, BRIDGE, AND MUNICIPAL CONSTRUCTION. FOR PERMEABLE PAVEMENT AND OTHER STORMWATER BMP'S DESIGNED TO INFILTRATE SUBGRADE COMPACTION SHOULD BE "FIRM AND UNYIELDING" (QUALITATIVE), AND 90- 92% STANDARD PROCTOR (QUANTITATIVE). DO NOT ALLOW HEAVY COMPACTION DUE TO HEAVY EQUIPMENT OPERATION. THE SUBGRADE SHOULD NOT BE SUBJECT TO TRUCK TRAFFIC.
- 12. STORM PIPE SHALL BE A MINIMUM OF 10 FEET AWAY FROM BUILDING FOUNDATIONS AND/OR ROOF LINES.
- 13. AFTER ALL OTHER UTILITIES ARE INSTALLED AND PRIOR TO ASPHALT WORK, ALL STORM PIPE SHALL PASS A LOW PRESSURE AIR TEST IN ACCORDANCE WITH SECTION 7-04.3(1) E & F OF THE WSDOT STANDARD SPECIFICATIONS FOR ROAD, BRIDGE, AND MUNICIPAL CONSTRUCTION. PIPE RUNS SHALL BE TESTED WITH PIPE LOADED AND COMPACTED TO FINISH GRADE. PRODUCTS USED TO SEAL THE INSIDE OF THE PIPE ARE NOT TO BE USED TO OBTAIN THE AIR TEST.
- 14. ALL TEMPORARY SEDIMENTATION AND EROSION CONTROL MEASURES, AND PROTECTIVE MEASURES FOR CRITICAL AREAS, PRESERVED NATIVE VEGETATION AND SIGNIFICANT TREES SHALL BE INSTALLED PRIOR TO INITIATING ANY CONSTRUCTION ACTIVITIES.
- 15. STORMWATER FACILITIES WITH SIDE SLOPES STEEPER THAN 3:1 OR WITH A MAXIMUM WATER DEPTH GREATER THAN 3 FEET SHALL REQUIRE A POWDER OR VINYL COATED CHAIN LINK PERIMETER FENCE PER STANDARD PLANS 3-501-007 AND -008. SIDE SLOPE AVERAGING SHALL NOT BE ALLOWED. ALL INLET AND OUTFALL PIPES SHALL HAVE A TRASH RACK INSTALLED AND A MORTARED RIPRAP HEADWALL. REFER TO STORM DRAINAGE NOTE 21.
- 16. PRIOR TO SIDEWALK CONSTRUCTION; LOT DRAINAGE SYSTEMS, STUB-OUTS AND ANY BEHIND SIDEWALK DRAINS MUST BE INSTALLED AS REQUIRED. PIPE SHALL BE PVC 3034, OR SDR-35. STUB-OUTS SHALL BE MARKED WITH A 2" X 4" WITH 3 FEET VISIBLE ABOVE GRADE AND MARKED "STORM". LOCATIONS OF THESE INSTALLATIONS SHALL BE SHOWN ON THE RECORD DRAWING CONSTRUCTION PLANS SUBMITTED TO THE CITY
- 17. STORM WATER RETENTION/DETENTION FACILITIES, STORM DRAINAGE PIPE AND CATCH BASINS SHALL BE FLUSHED AND CLEANED BY THE DEVELOPER PRIOR TO; CITY OF MARYSVILLE FINAL ACCEPTANCE OF THE PROJECT AND; UPON COMMENCEMENT AND COMPLETION OF THE 2-YEAR WARRANTY PERIOD FOR THE STORM DRAINAGE SYSTEM.
- 18. UNLESS OTHERWISE NOTED, ALL STORM SEWER PIPE SHALL BE; (CP) NON-REINFORCED CONCRETE, ASTM C-14; (RCP) REINFORCED CONCRETE FOR CONCRETE PIPE DIAMETERS 24" OR GREATER, ASTM C-76; OR (CMP) CORRUGATED METAL. CMP TO BE; GALVANIZED STEEL WITH TREATMENT ASPHALT COATING OR BETTER; OR CORRUGATED ALUMINUM; OR AASHTO M274-70 ALUMINIZED STEEL. ALL PIPES SHALL BE INSTALLED WITH RUBBER GASKETS AS PER MANUFACTURERS RECOMMENDATIONS. COVERAGE REQUIREMENTS FOR 12" DIAMETER PIPE:


BACKFILL OVER PIPE LESS THAN 12" REQUIRES RCP CLASS IV. BACKFILL OVER PIPE LESS THAN 24" REQUIRES RCP MINIMUM. BACKFILL OVER PIPE GREATER THAN 24" REQUIRES 16 GAGE CMP MINIMUM.


19. CORRUGATED POLYETHYLENE PIPE (CPP): A. ALL PIPE SHALL BE SMOOTH INTERIOR. CPP SHALL BE DOUBLE-WALLED.

- ALL PIPE SHALL MEET AASHTO AND ASTM SPECIFICATIONS. B. UPON REQUEST BY THE CITY INSPECTOR, ALL PIPE RUNS SHALL PASS THE LOW PRESSURE AIR TEST REQUIREMENTS OF SECTION 7-04.3(1) E & F OF THE WSDOT STANDARD SPECIFICATIONS FOR ROAD, BRIDGE, AND MUNICIPAL CONSTRUCTION. PIPE RUNS SHALL BE TESTED WITH PIPE
- LOADED AND COMPACTED TO FINISH GRADE. C. UPON REQUEST BY THE CITY INSPECTOR, PIPE SHALL BE SUBJECT TO MANDREL TESTING (MANDREL SIZE = 90% OF NOMINAL PIPE DIAMETER).
- D. PIPE SHALL BE STORED ON SITE IN SHIPPING BUNKS ON A FLAT LEVEL SURFACE. THIS REQUIREMENT WILL BE STRICTLY ENFORCED; FAILURE TO COMPLY MAY RESULT IN REJECTION OF THE PIPE AND/OR FUTURE RESTRICTION ON USE OF MATERIAL
- . MINIMUM DEPTH OF COVER SHALL BE 2 FEET F. COUPLINGS SHALL BE INTEGRAL BELL AND SPIGOT OR DOUBLE BELL
- SEPARATE COUPLINGS. SPLIT COUPLINGS WILL NOT BE ALLOWED. G. BACKFILL SHALL COMPLY WITH SECTION 7-08.3(3) OF THE WSDOT STANDARD SPECIFICATIONS FOR ROAD, BRIDGE, AND MUNICIPAL

CONSTRUCTION MODIFIED AS FOLLOWS: THE SECOND PARAGRAPH OF SECTION 7-08.3(3) IS DELETED AND REPLACED WITH THE FOLLOWING:

- THE MATERIAL USED FOR BACKFILLING AROUND AND TO A POINT 1 FOOT ABOVE THE TOP OF THE PIPE SHALL BE CLEAN EARTH OR SAND, FREE FROM CLAY. ANY GRAVEL OR STONES INCLUDED IN THE BACKFILL SHALL PASS THROUGH A 1 INCH SIEVE.
- 20. ALL NON-PERFORATED METAL PIPE SHALL HAVE NEOPRENE GASKETS AT THE JOINTS. O-RING GASKETS MAY BE USED FOR TYPE-F COUPLING BAND. 21. CULVERT ENDS SHALL BE BEVELED TO MATCH SIDE SLOPES. FIELD CUTTING OF CULVERT ENDS IS PERMITTED WHEN APPROVED BY THE CITY ENGINEER OR DESIGNATED REPRESENTATIVE.
- 22. ALL FIELD CUT CULVERT PIPE SHALL BE TREATED AS REQUIRED IN THE STANDARD SPECIFICATIONS OR GENERAL SPECIAL PROVISIONS.
- 23. ALL PIPE SHALL BE PLACED ON STABLE EARTH. IF IN THE OPINION OF THE CITY INSPECTOR, THE EXISTING TRENCH FOUNDATION IS UNSATISFACTORY, THEN IT SHALL BE EXCAVATED BELOW GRADE AND BACKFILLED WITH GRAVEL BEDDING TO SUPPORT THE PIPE.
- 24. ALL LANDSCAPED AND LAWN AREAS, EXCEPT AREAS WITHIN THE DRIPLINE OF PRESERVED TREES, SHALL BE AMENDED PER BMP T5.13 POST CONSTRUCTION SOIL QUALITY AND DEPTH IN CHAPTER 5, VOLUME V OF THE STORMWATER MANUAL.

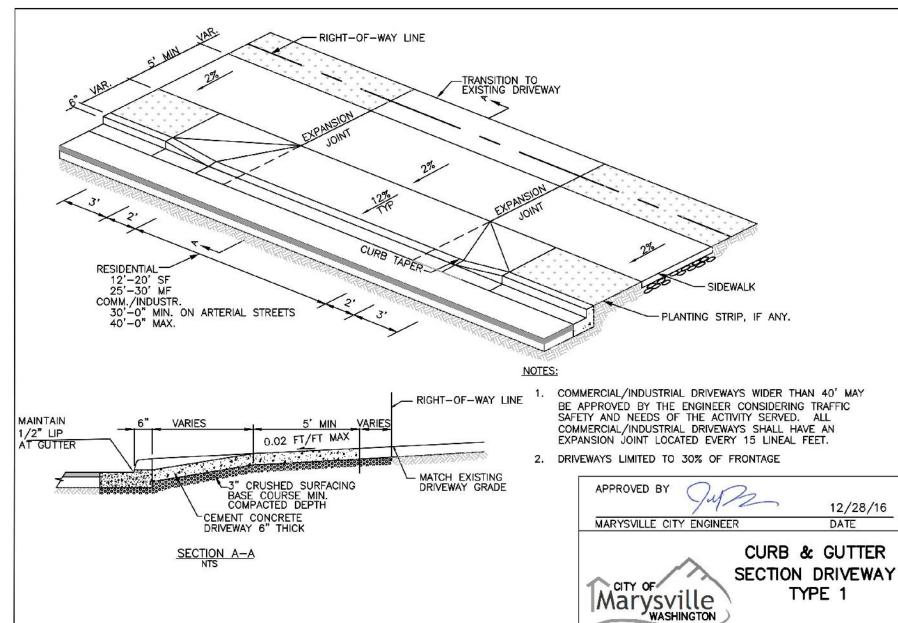


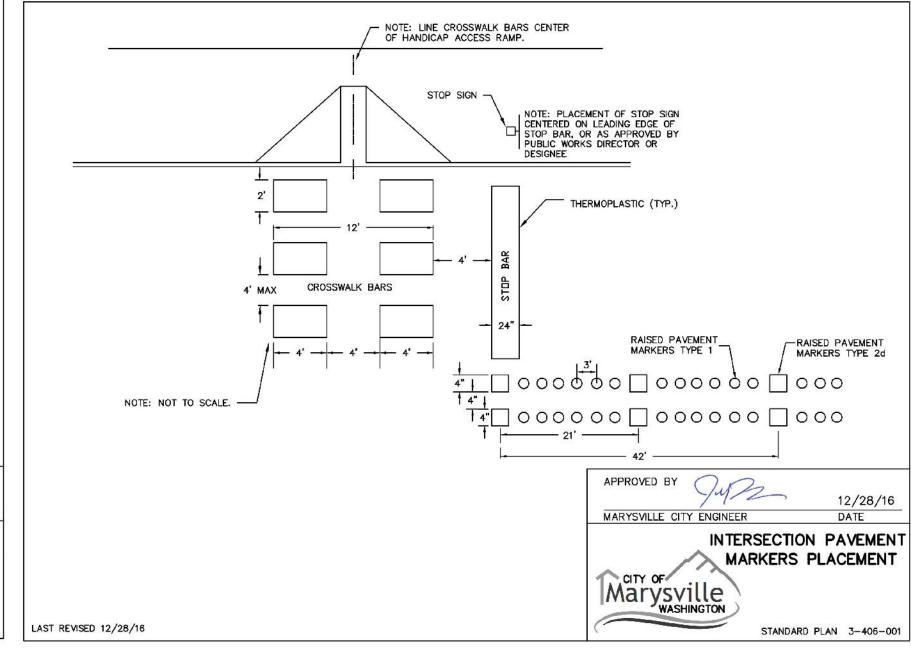


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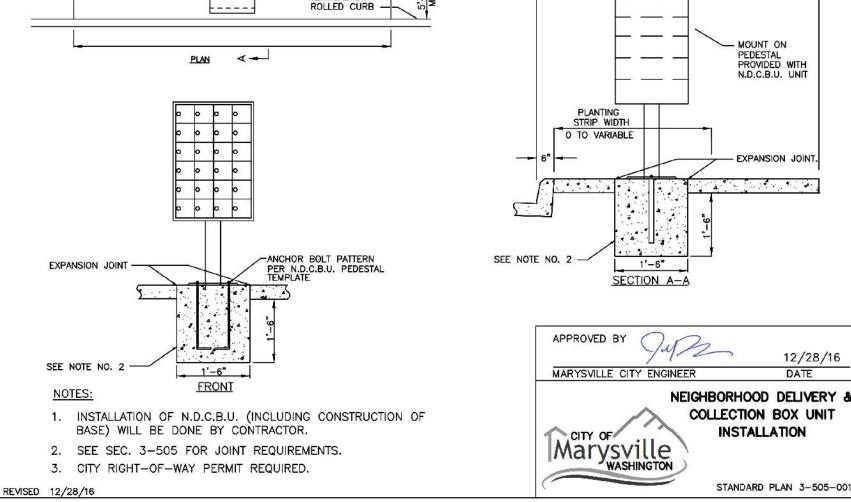
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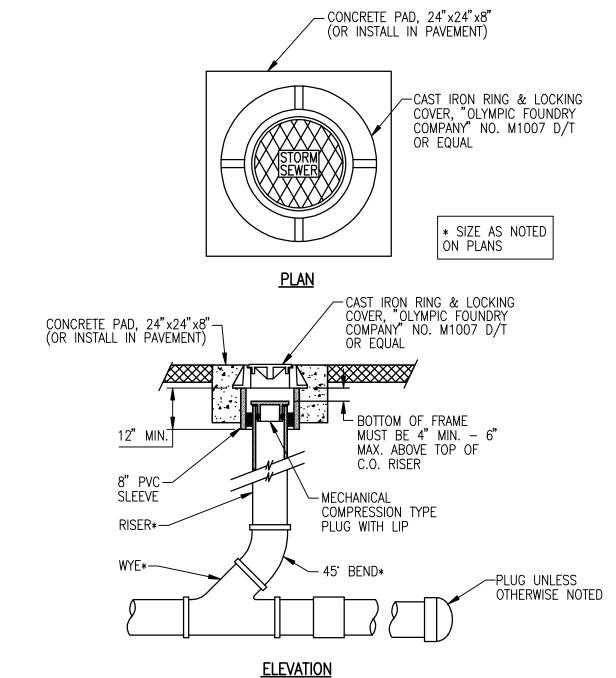
SIDEWALK



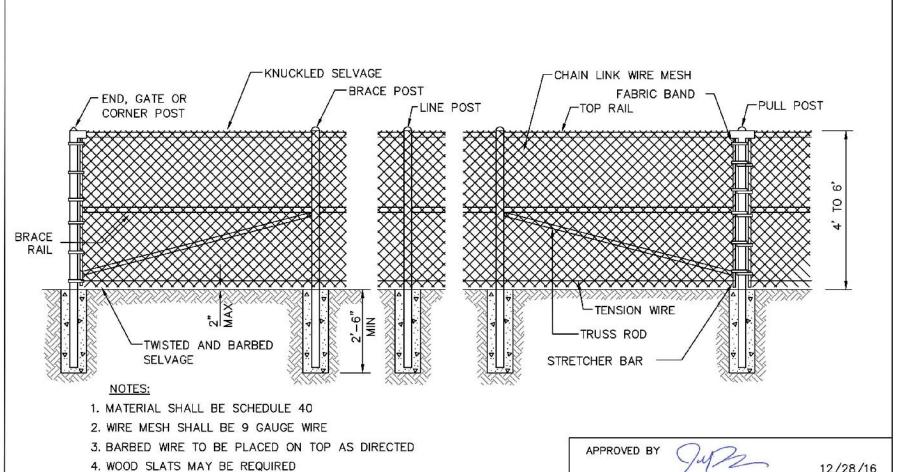

STANDARD PLAN 3-303-001

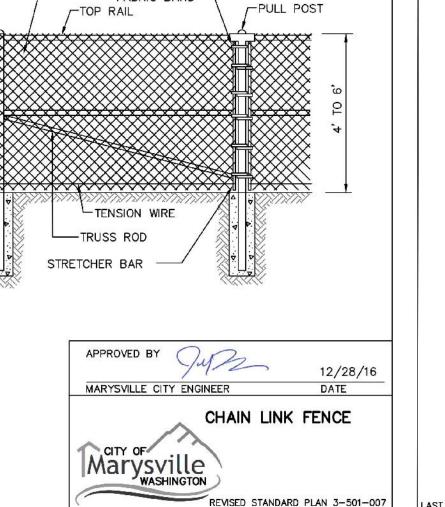



STORM SEWER CLEAN OUT

5. SCHEDULE 40 IS REQUIRED FOR ALL POSTS


8. FENCE SECTION SHALL BE 8' UNLESS OTHERWISE

7. ALL CHAIN LINK FENCE SHALL BE BLACK VINYL OR POWDER

FOR FUTURE SLATES AND WIND SHEAR.


6. TENSION WIRE SHALL BE 7 GAUGE

LAST REVISED 12/28/16

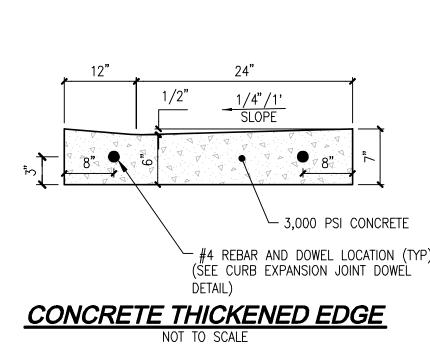

-ASPHALT PAVEMENT

<u>ASPHALT THICKENED EDGE DETAIL</u>

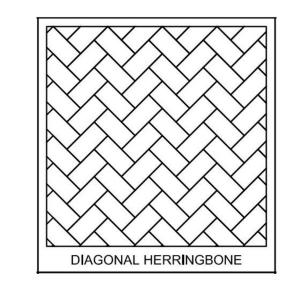

CONCRETE STAMP PATTERN

. CONCRETE STAMP TO BE DIAGONAL HERRINGBONE PATTERN PER ABOVE DETAIL. 2. CONCRETE COLOR TO BE "DRIFTWOOD" OR APPROVED EQUAL.

CITY PROJECT #: PA22-023

CITY OF MARYSVILLE CONSTRUCTION DRAWING REVIEW ACKNOWLEDGEMENT


'HIS PLAN SHEET HAS BEEN REVIEWED AND EVALUATED FOR GENERAL COMPLIANCE WITH THE APPLICABLE CITY OF MARYSVILLE CODES AND ORDINANCES. CONFORMANCE OF THIS DESIGN WITH ALL APPLICABLE LAWS AND REGULATIONS IS THE FULL AND COMPLETE RESPONSIBILITY OF THE LICENSED DESIGN ENGINEER, WHOSE STAMP AND SIGNATURE APPEAR ON THIS SHEET. ACKNOWLEDGMENT OF CONSTRUCTION DRAWING REVIEW DOES NOT IMPLY CITY APPROVAL FOR CONSTRUCTION ACTIVITIES THAT REQUIRED OTHER COUNTY, STATE OR FEDERAL PERMIT REVIEW AND APPROVAL. THE PROPERTY OWNER AND LICENSED DESIGN ENGINEER SHALL BE RESPONSIBLE FOR THE ACQUISITION AND COMPLIANCE OF ALL APPLICABLE PERMITS OR AUTHORIZATIONS WHICH MAY INCLUDE, BUT ARE NOT LIMITED TO, WSDRW HYDRAULIC PROJECT APPROVAL (HPS), WSDOE NOTICE OF INTENT (NOI), ANY CORPS OF ENGINEERS FILL PERMITS AND THE REQUIREMENTS OF THE ENDANGERED SPECIES ACT. THIS DAY OF ___

KEN MCINTYRE, P.E., ASSISTANT CITY ENGINEER

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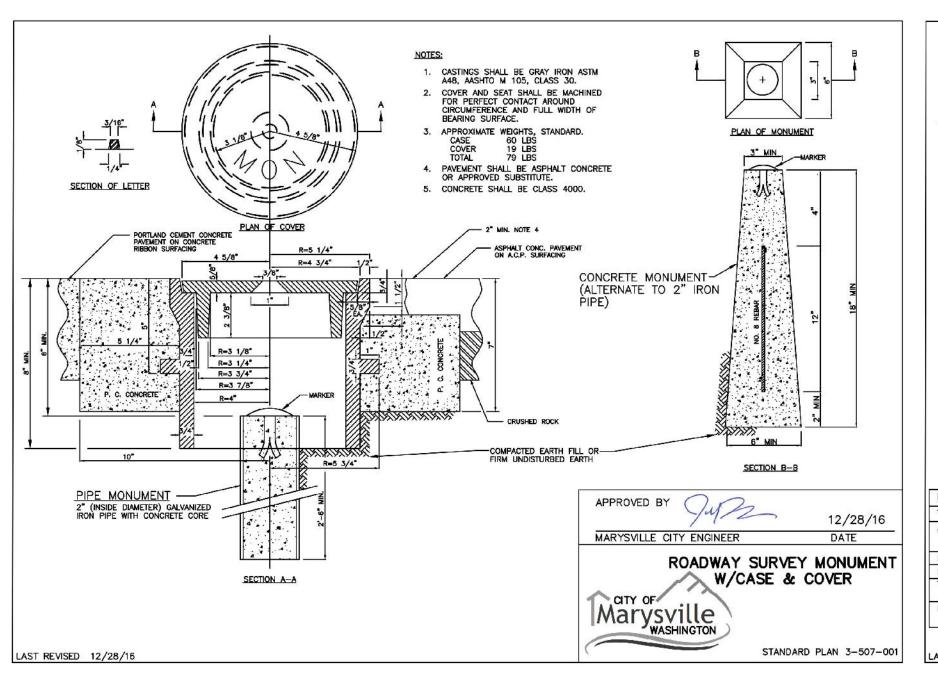
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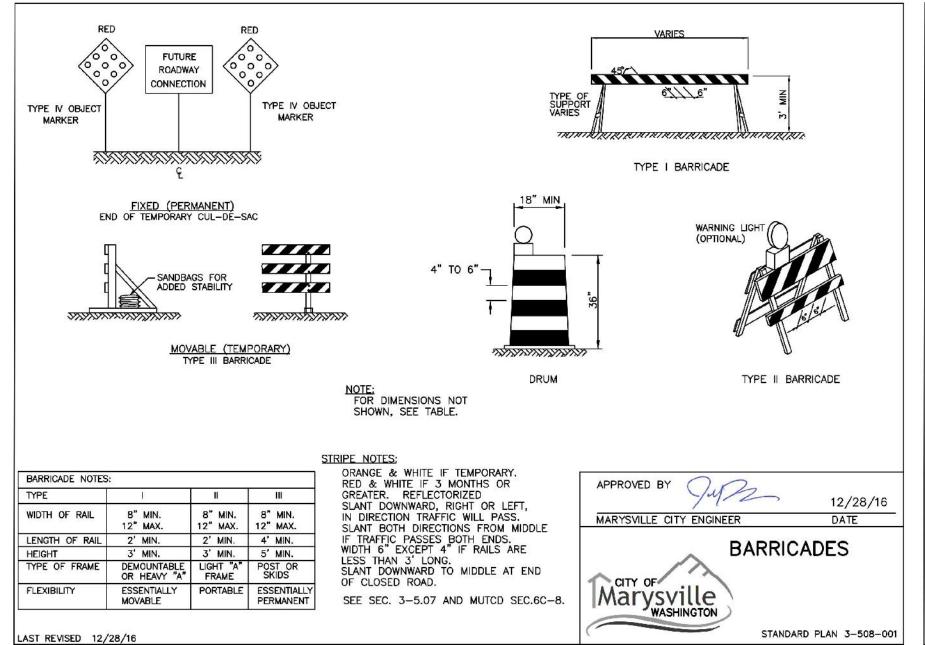
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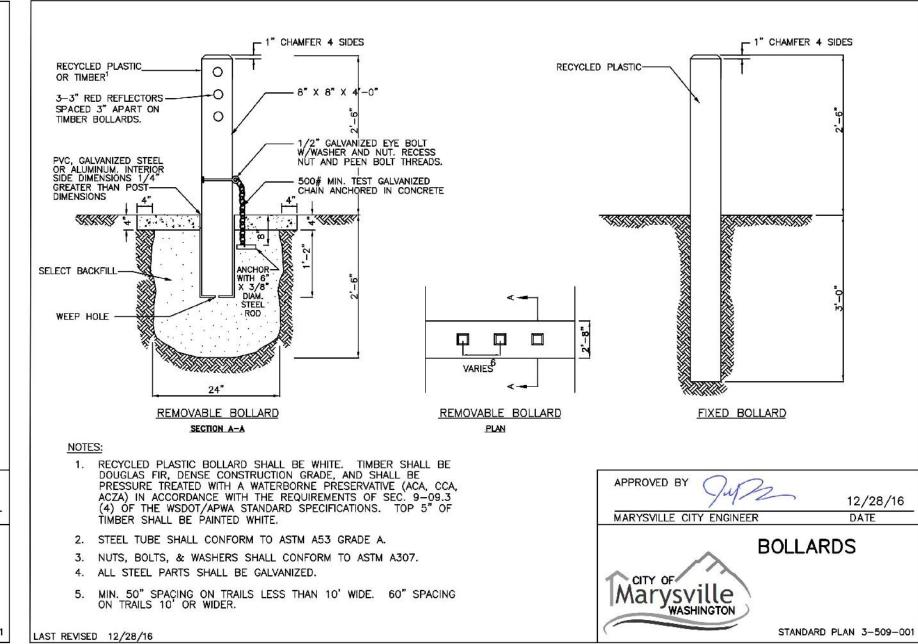



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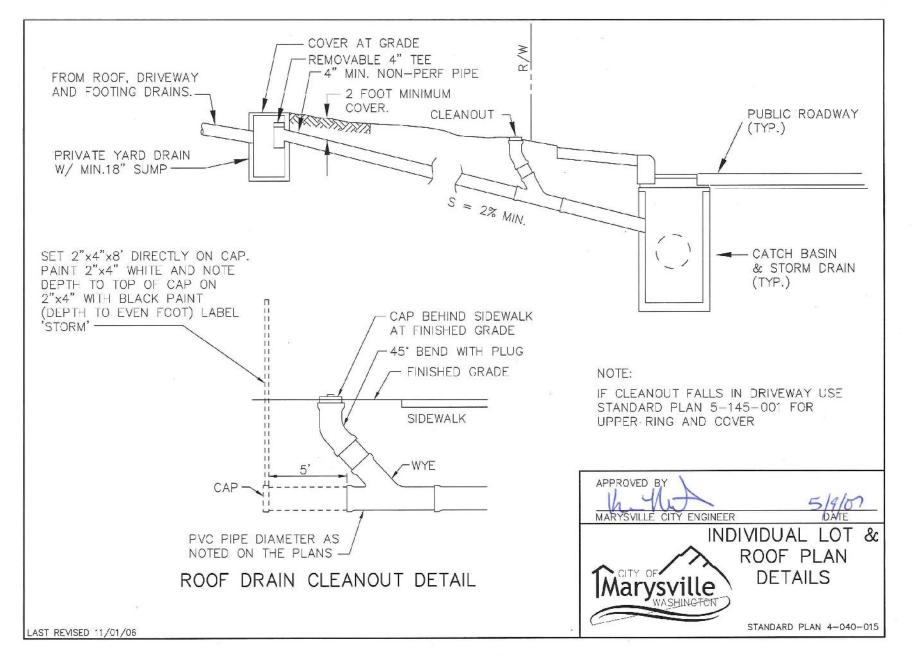
SHEET **24** OF **39**




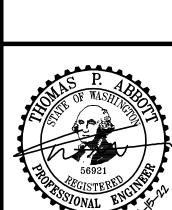








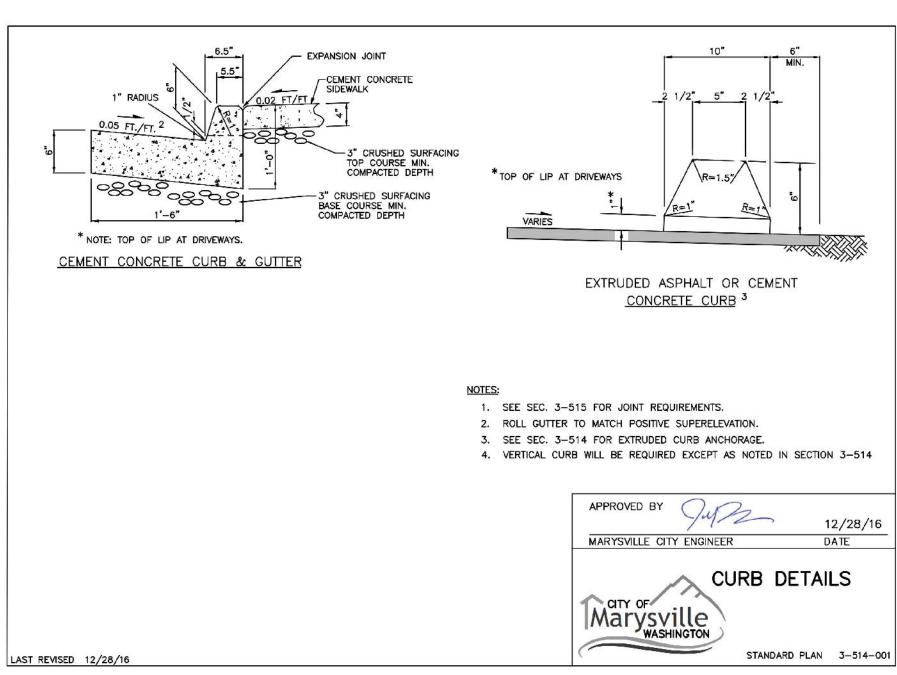

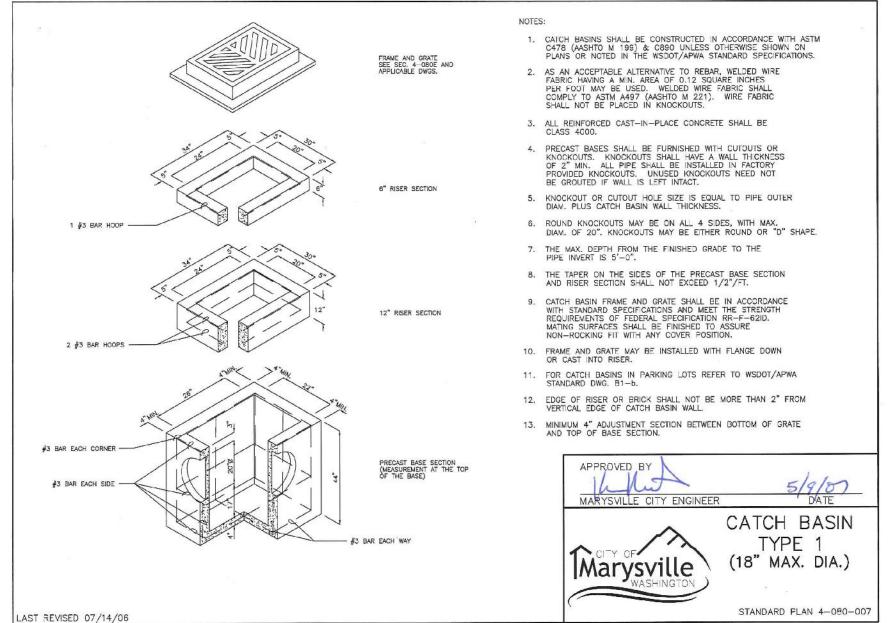

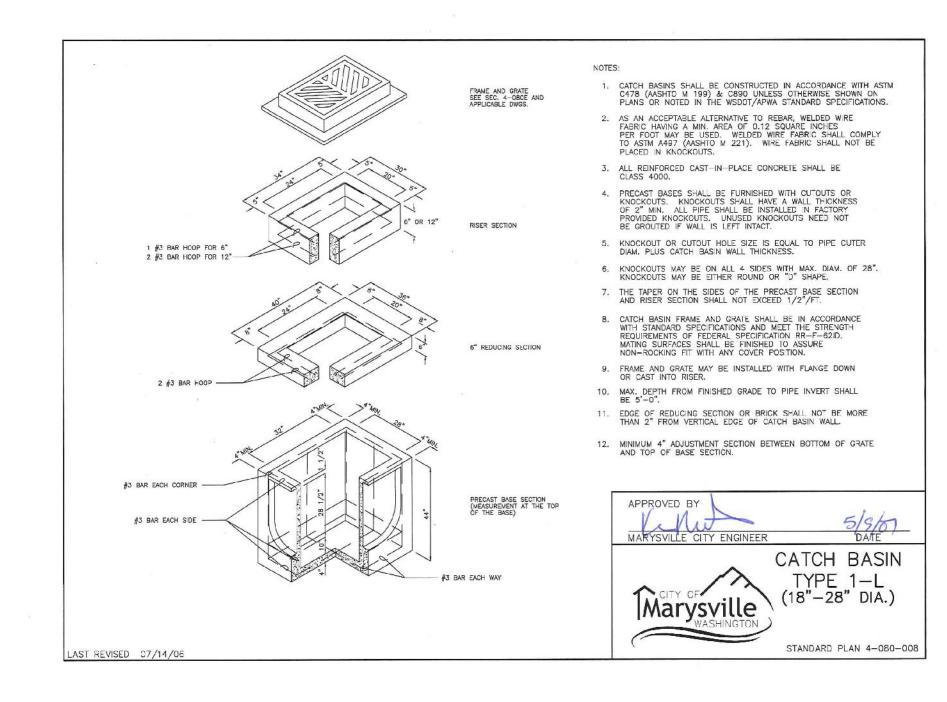

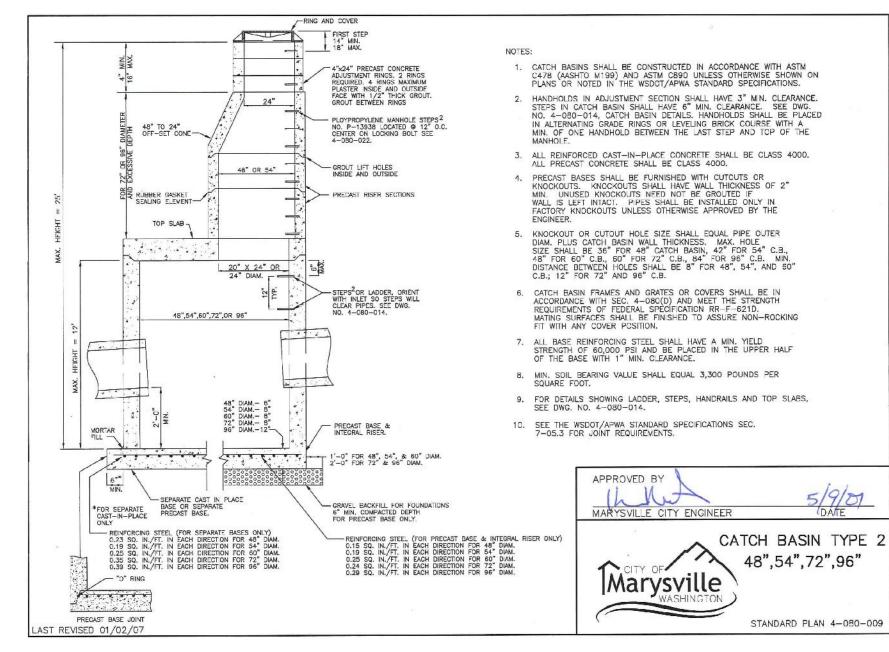

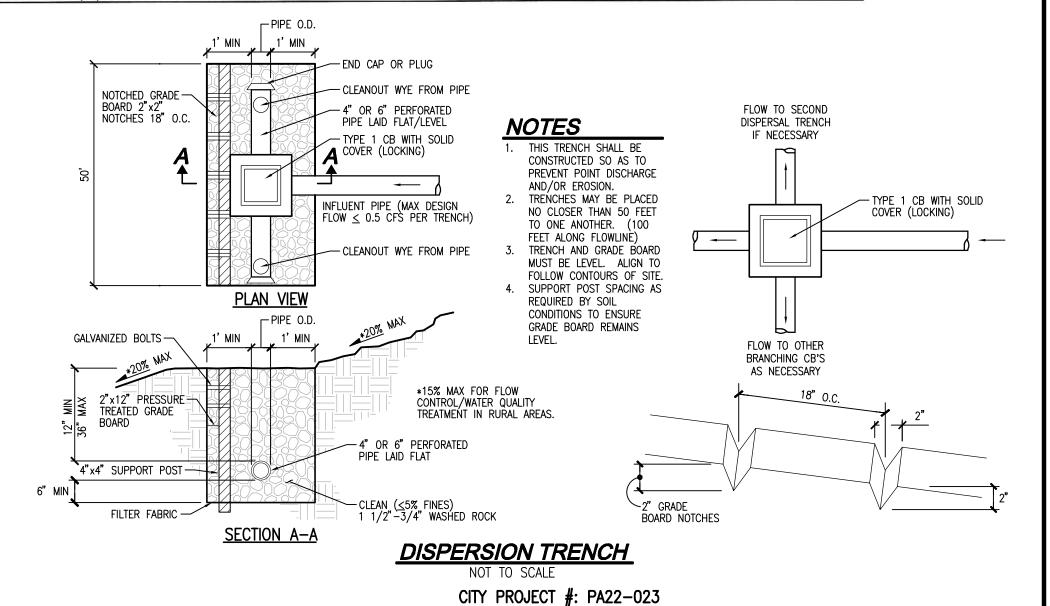

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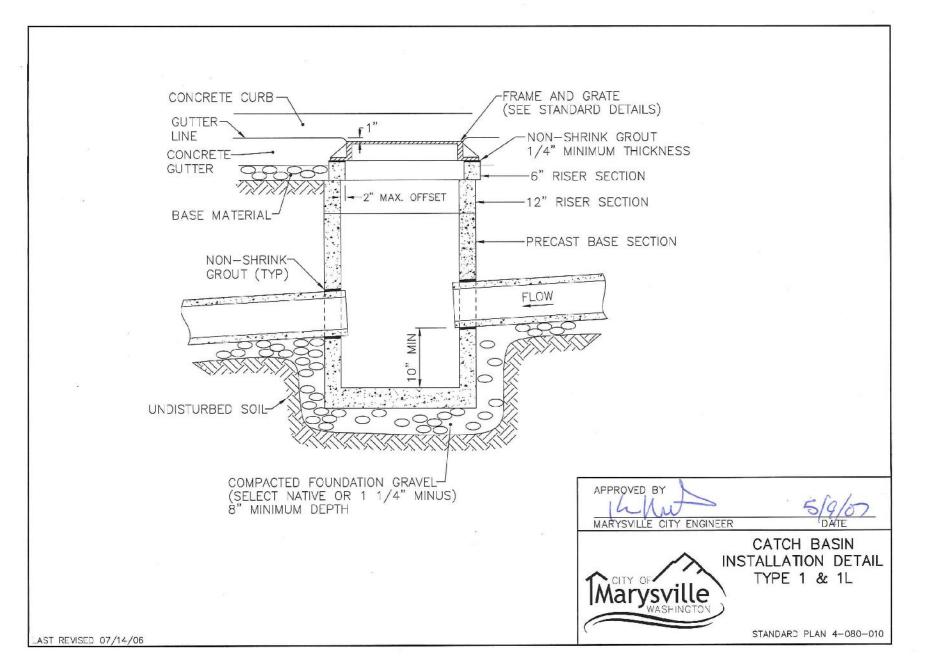
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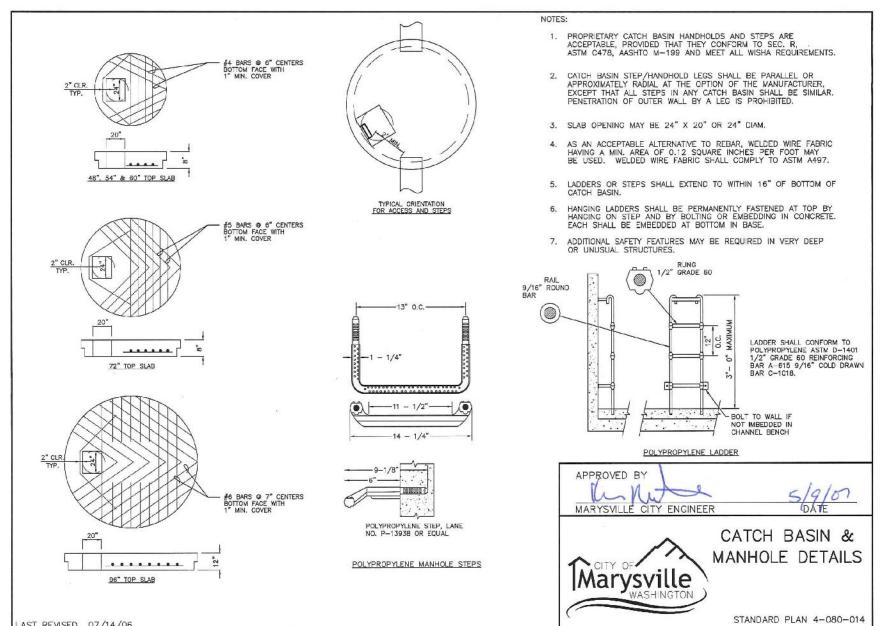
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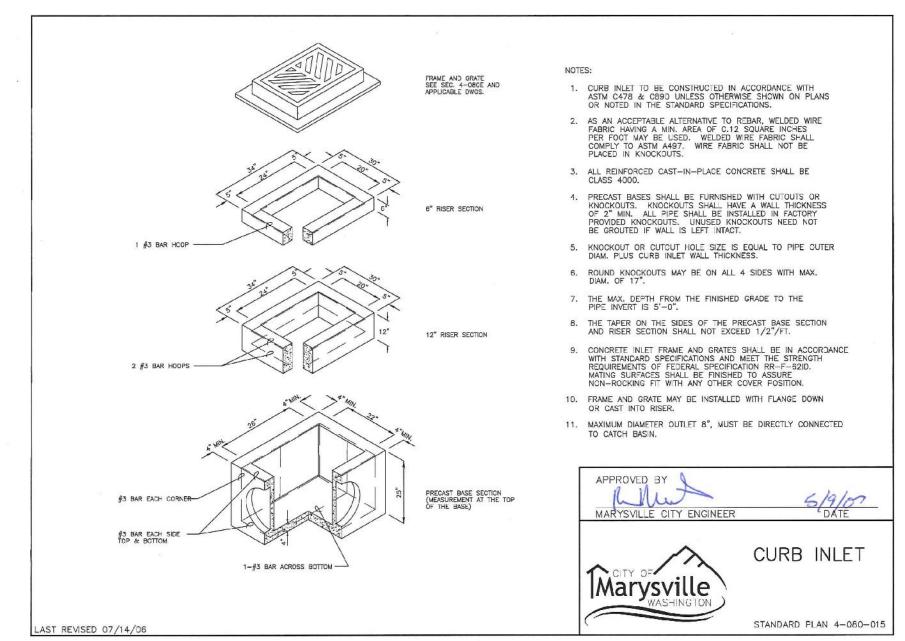
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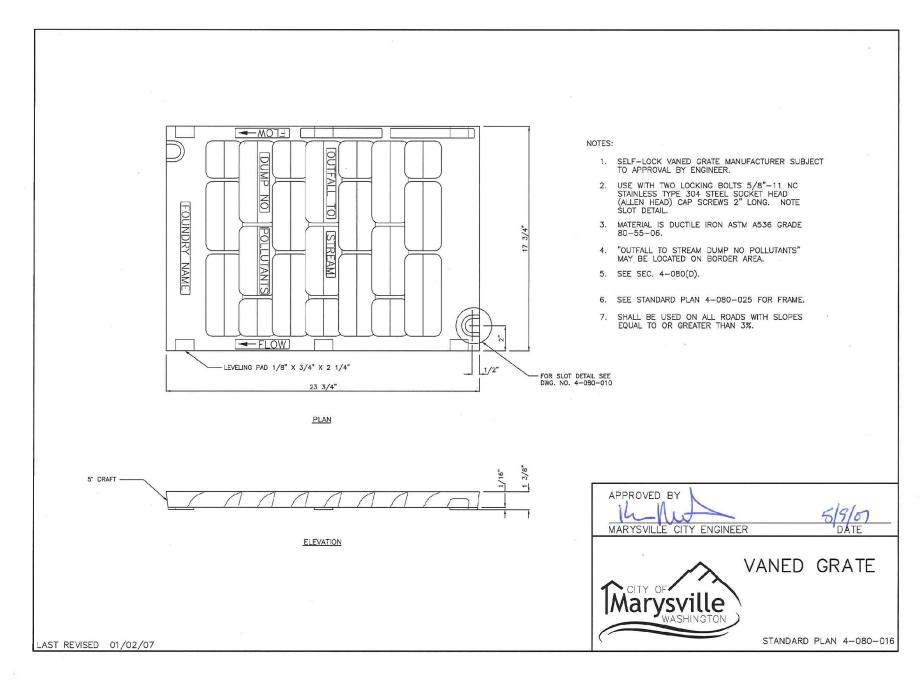
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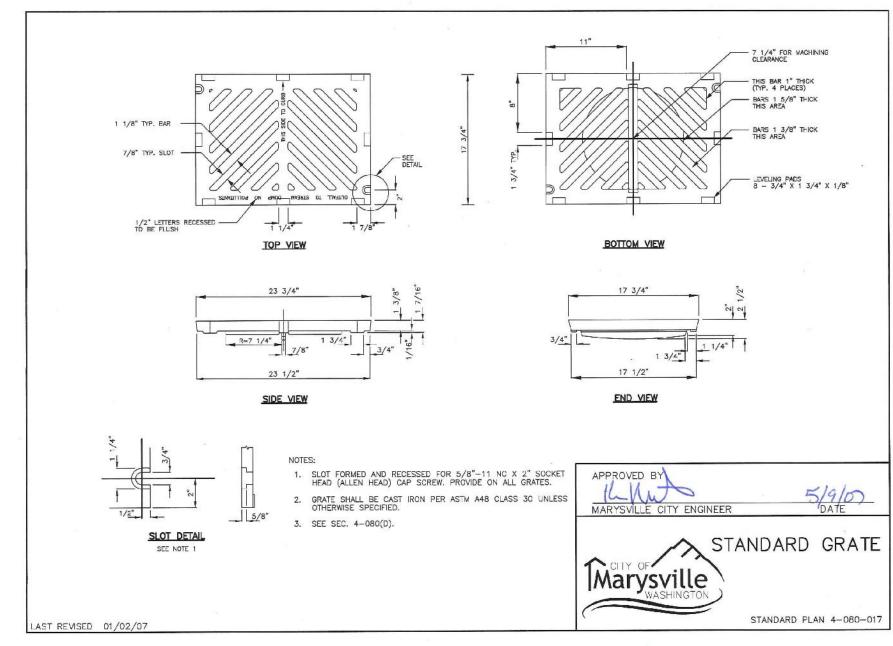
SHEET **25** OF **39**














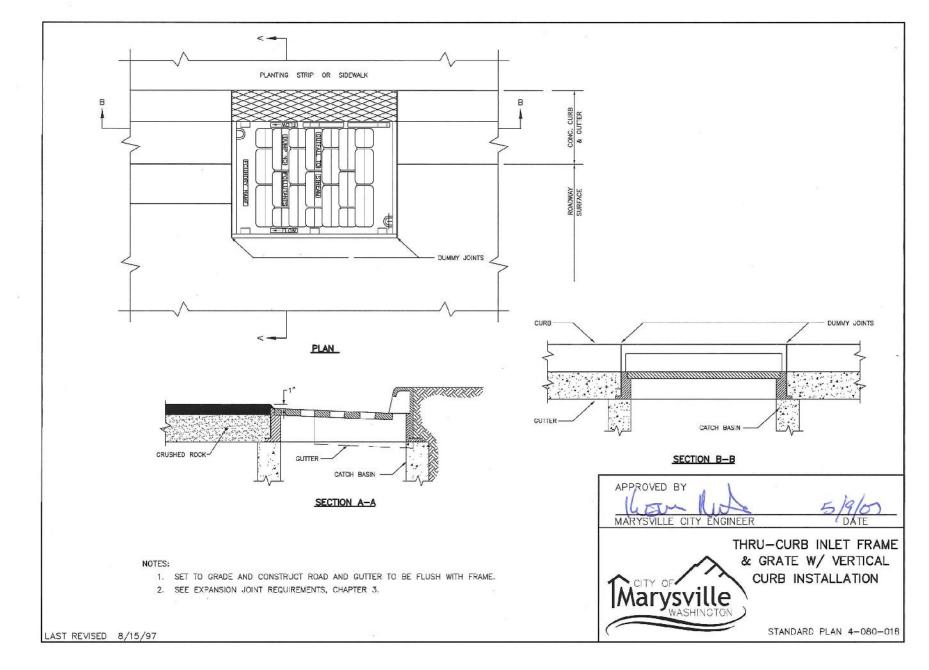

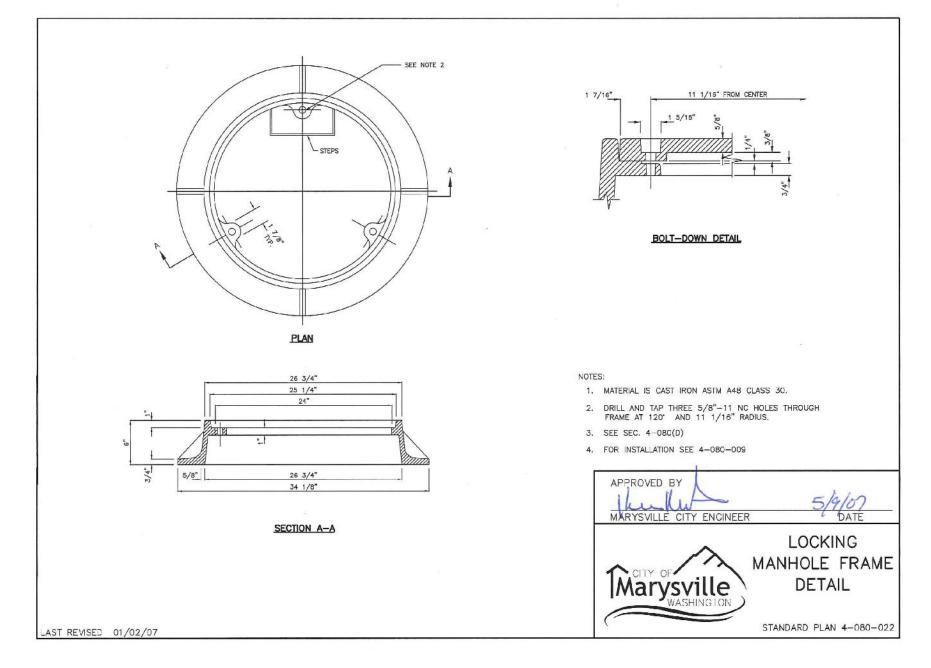

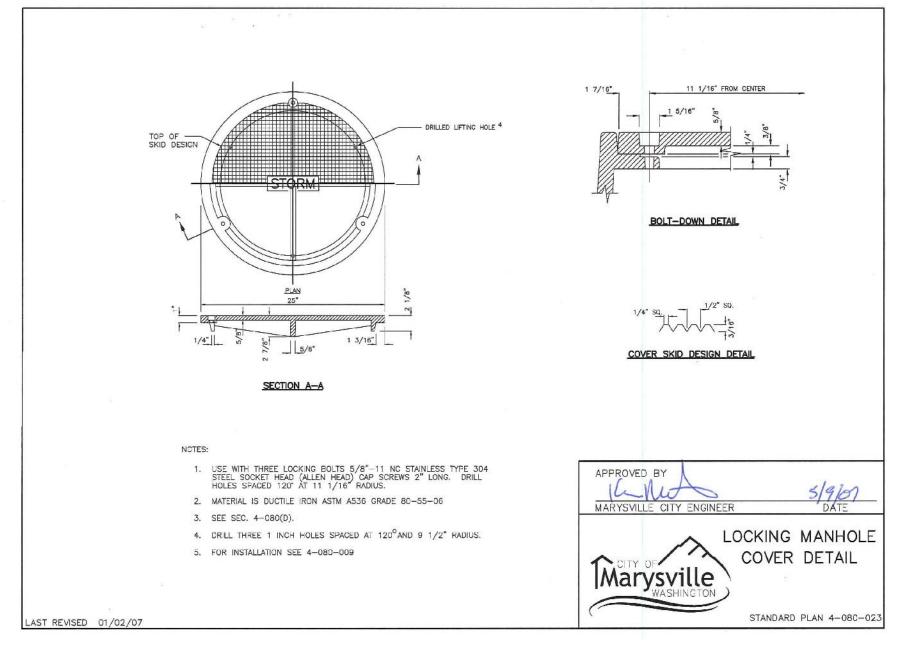

CITY PROJECT #: PA22-023

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KEN MCINTYRE, P.E., ASSISTANT CITY ENGINEER

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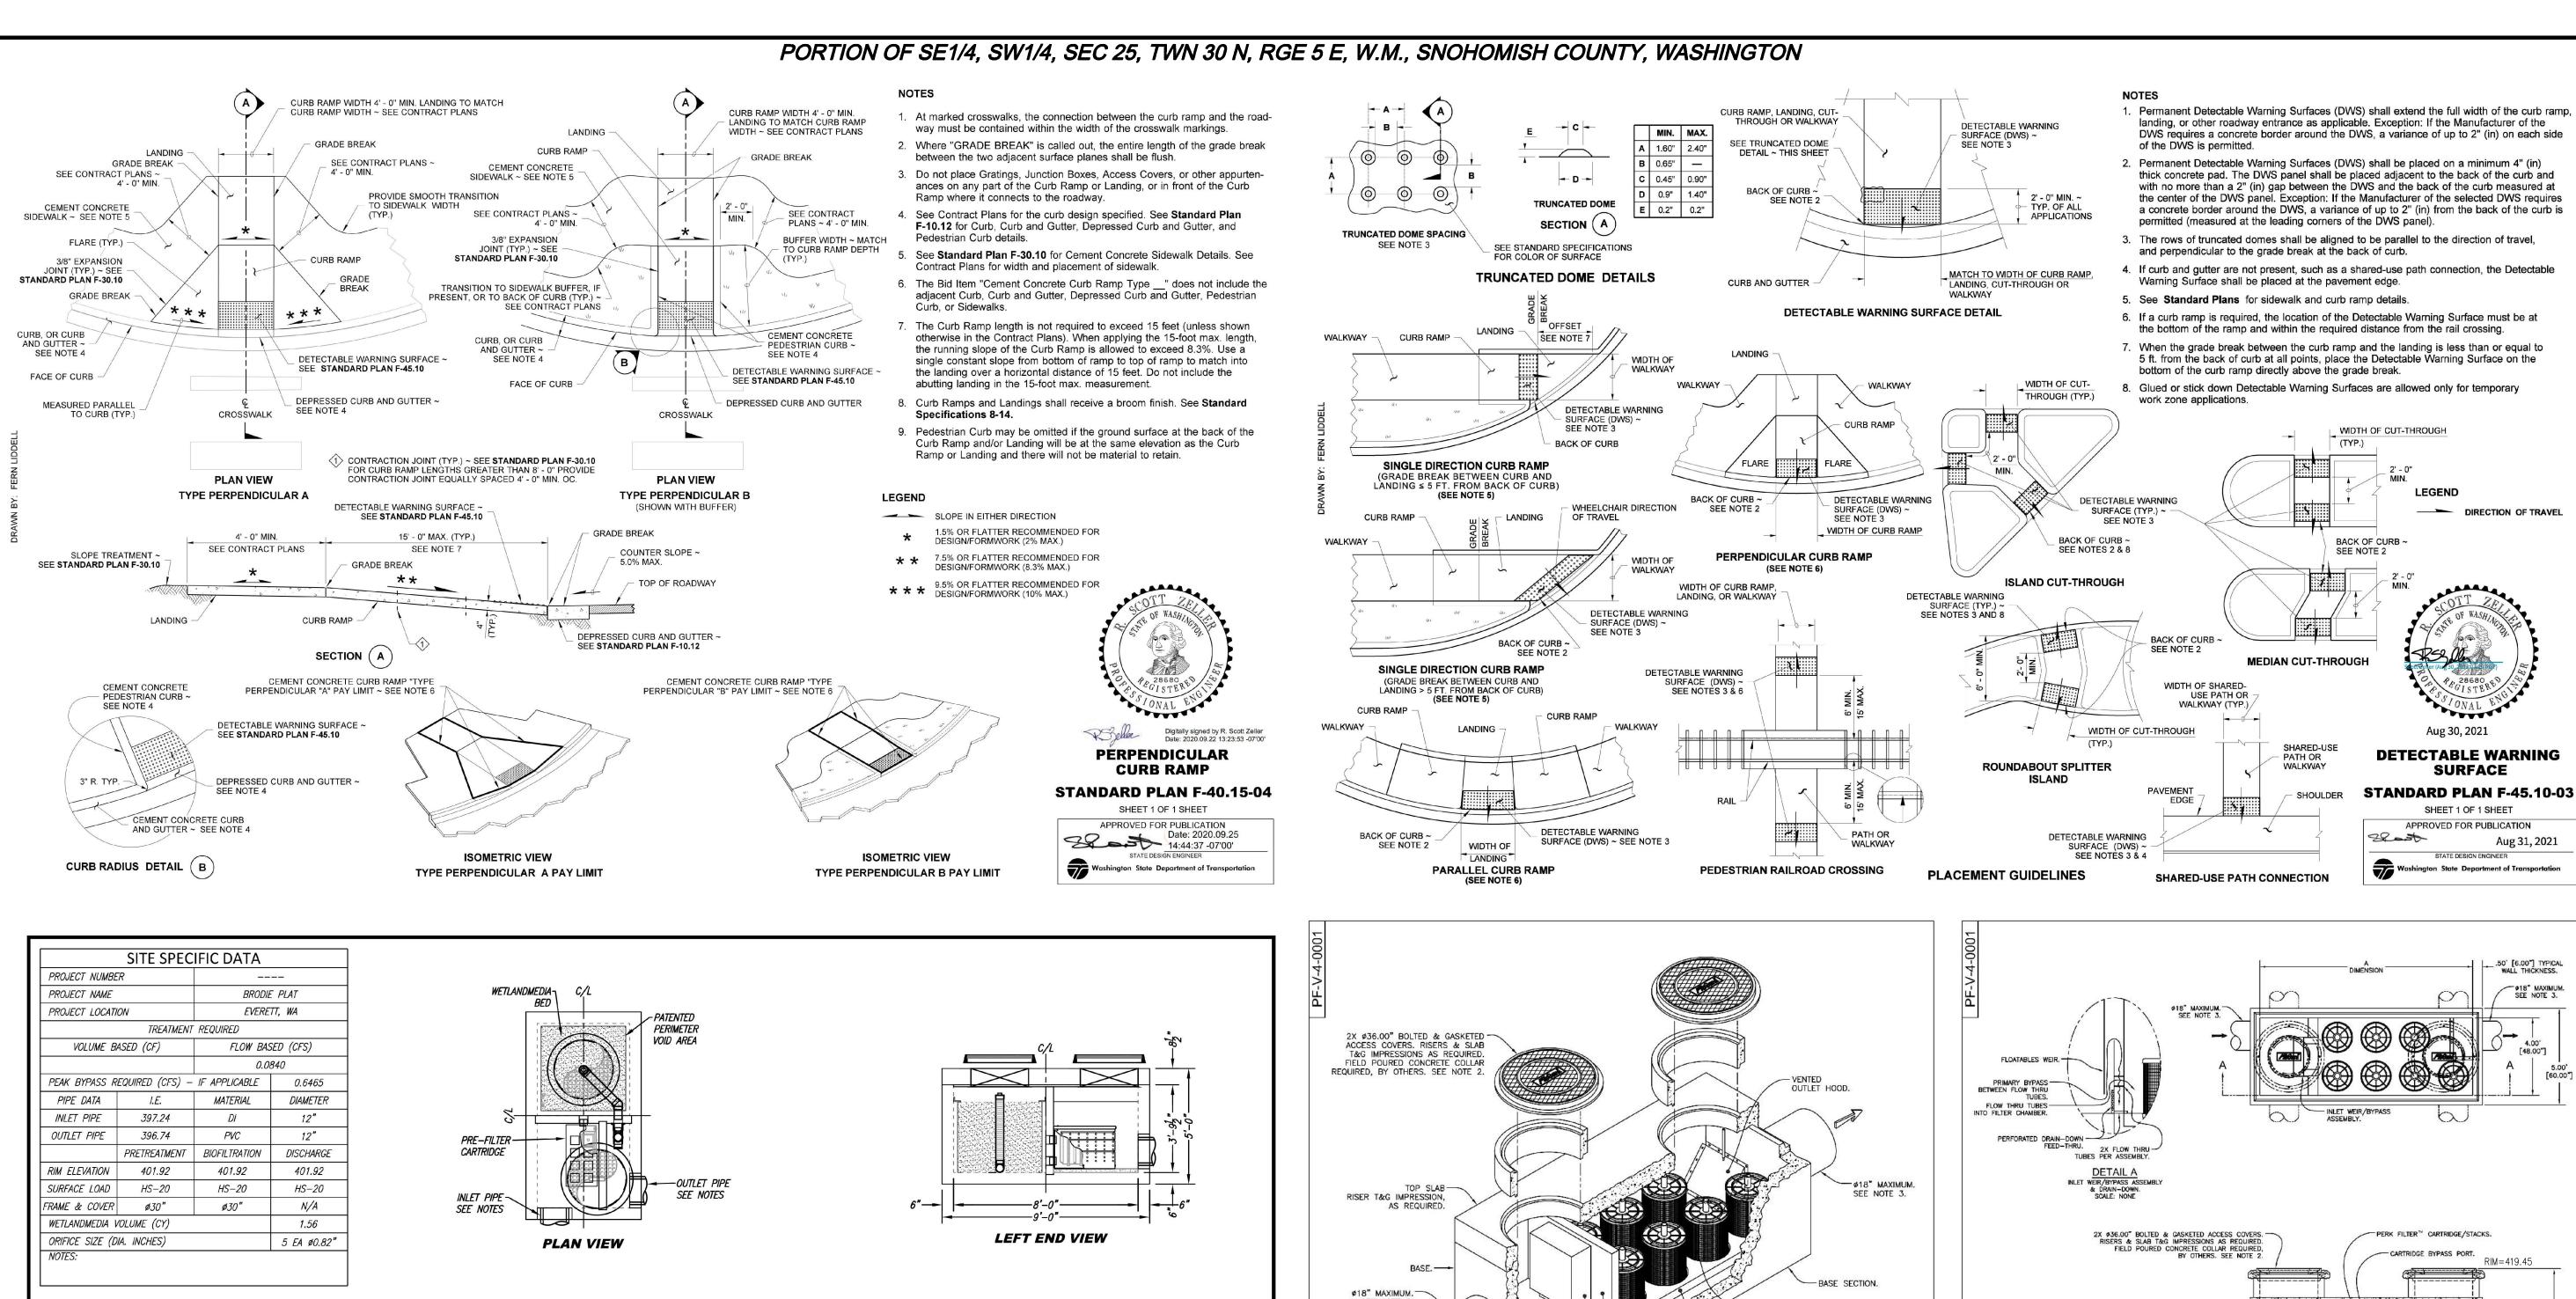
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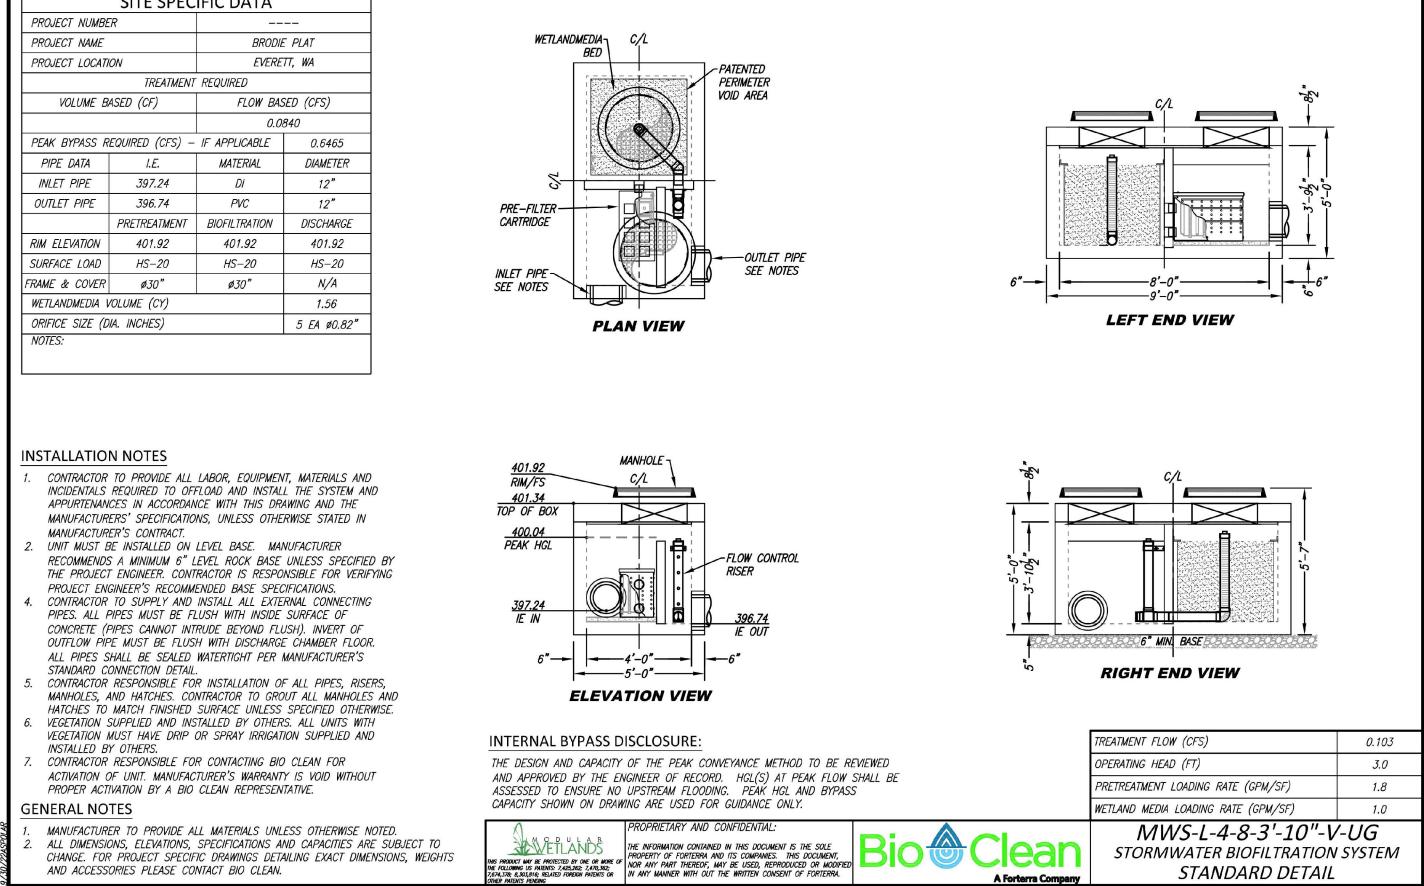
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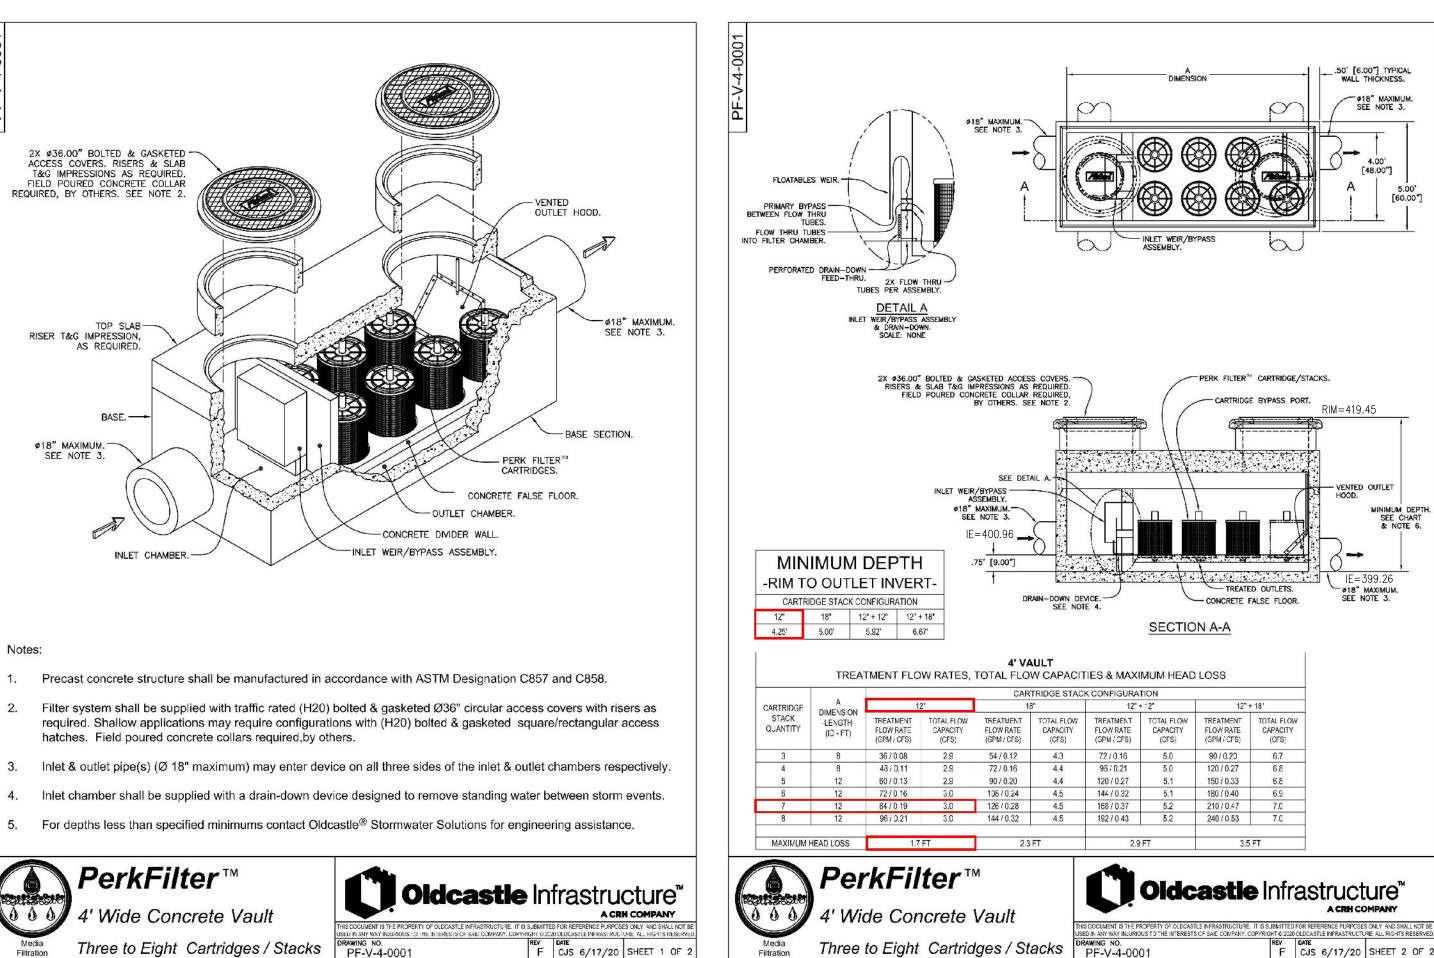
LAND PRO

BRODIE

JOB NUMBER:	C22-1
DRAWING NAME:	C22177C-RD-
DESIGNER:	T
DRAFTING BY:	D
DATE:	11-15-
SCALE:	AS NOT
JURISDICTION	MARYSVII







CITY PROJECT #: PA22-023 CITY OF MARYSVILLE CONSTRUCTION DRAWING REVIEW ACKNOWLEDGEMENT

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THIS DAY OF ______

Y: _____KEN MCINTYRE, P.E., ASSISTANT CITY ENGINEER

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JOB NUMBER: C22-177

DRAWING NAME: C22177C-RD-DT

DESIGNER: TPA

DRAFTING BY: DPN


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SCALE: AS NOTED


JURISDICTION: MARYSVILLE

| DT-04

SHEET **27** OF **3**9

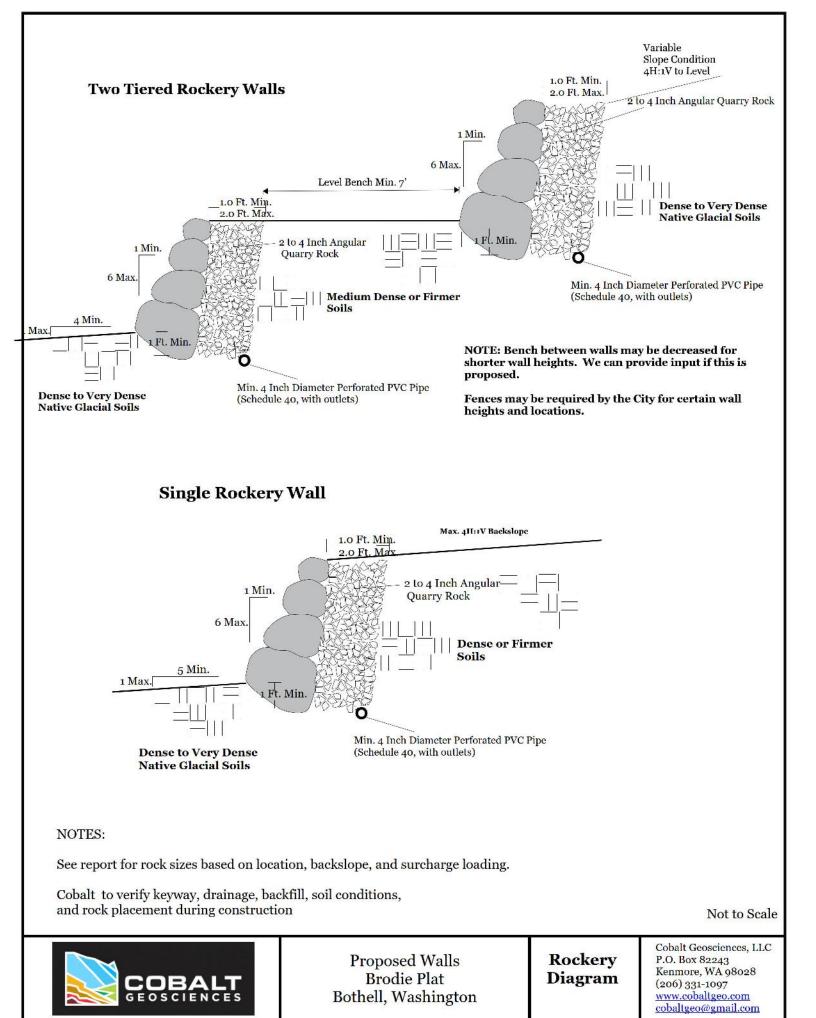

Bothell, Washington

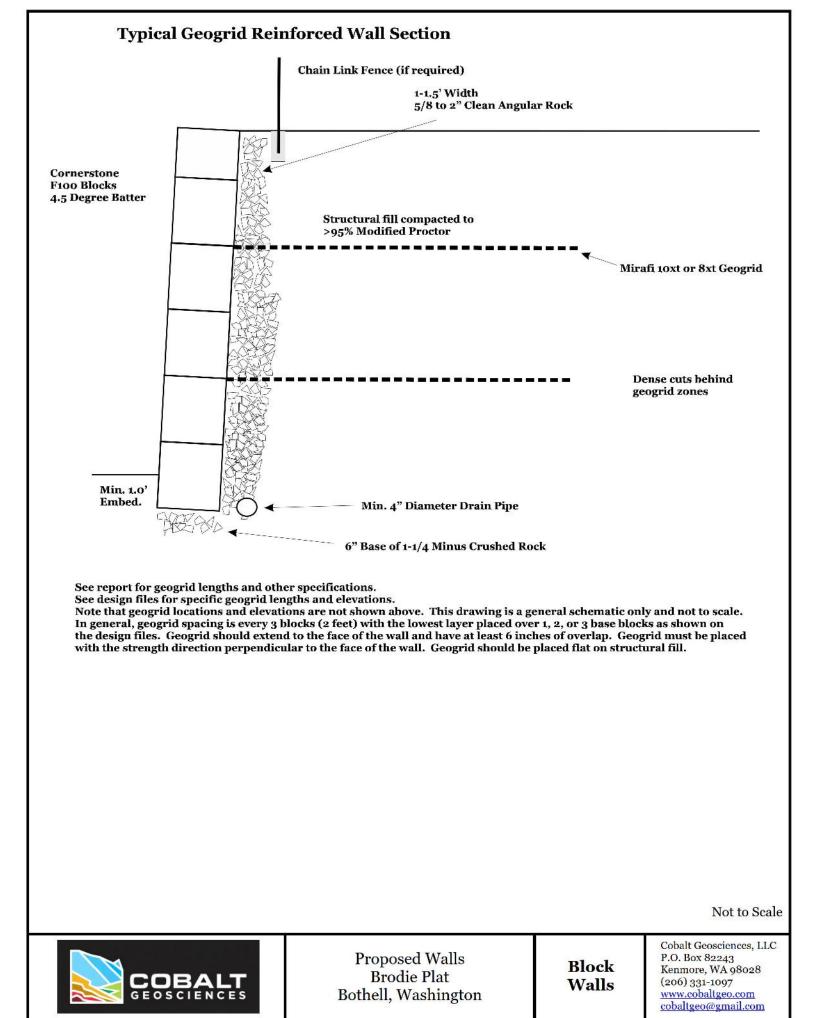

CITY PROJECT #: PA22-023

CITY OF MARYSVILLE CONSTRUCTION DRAWING REVIEW ACKNOWLEDGEMENT

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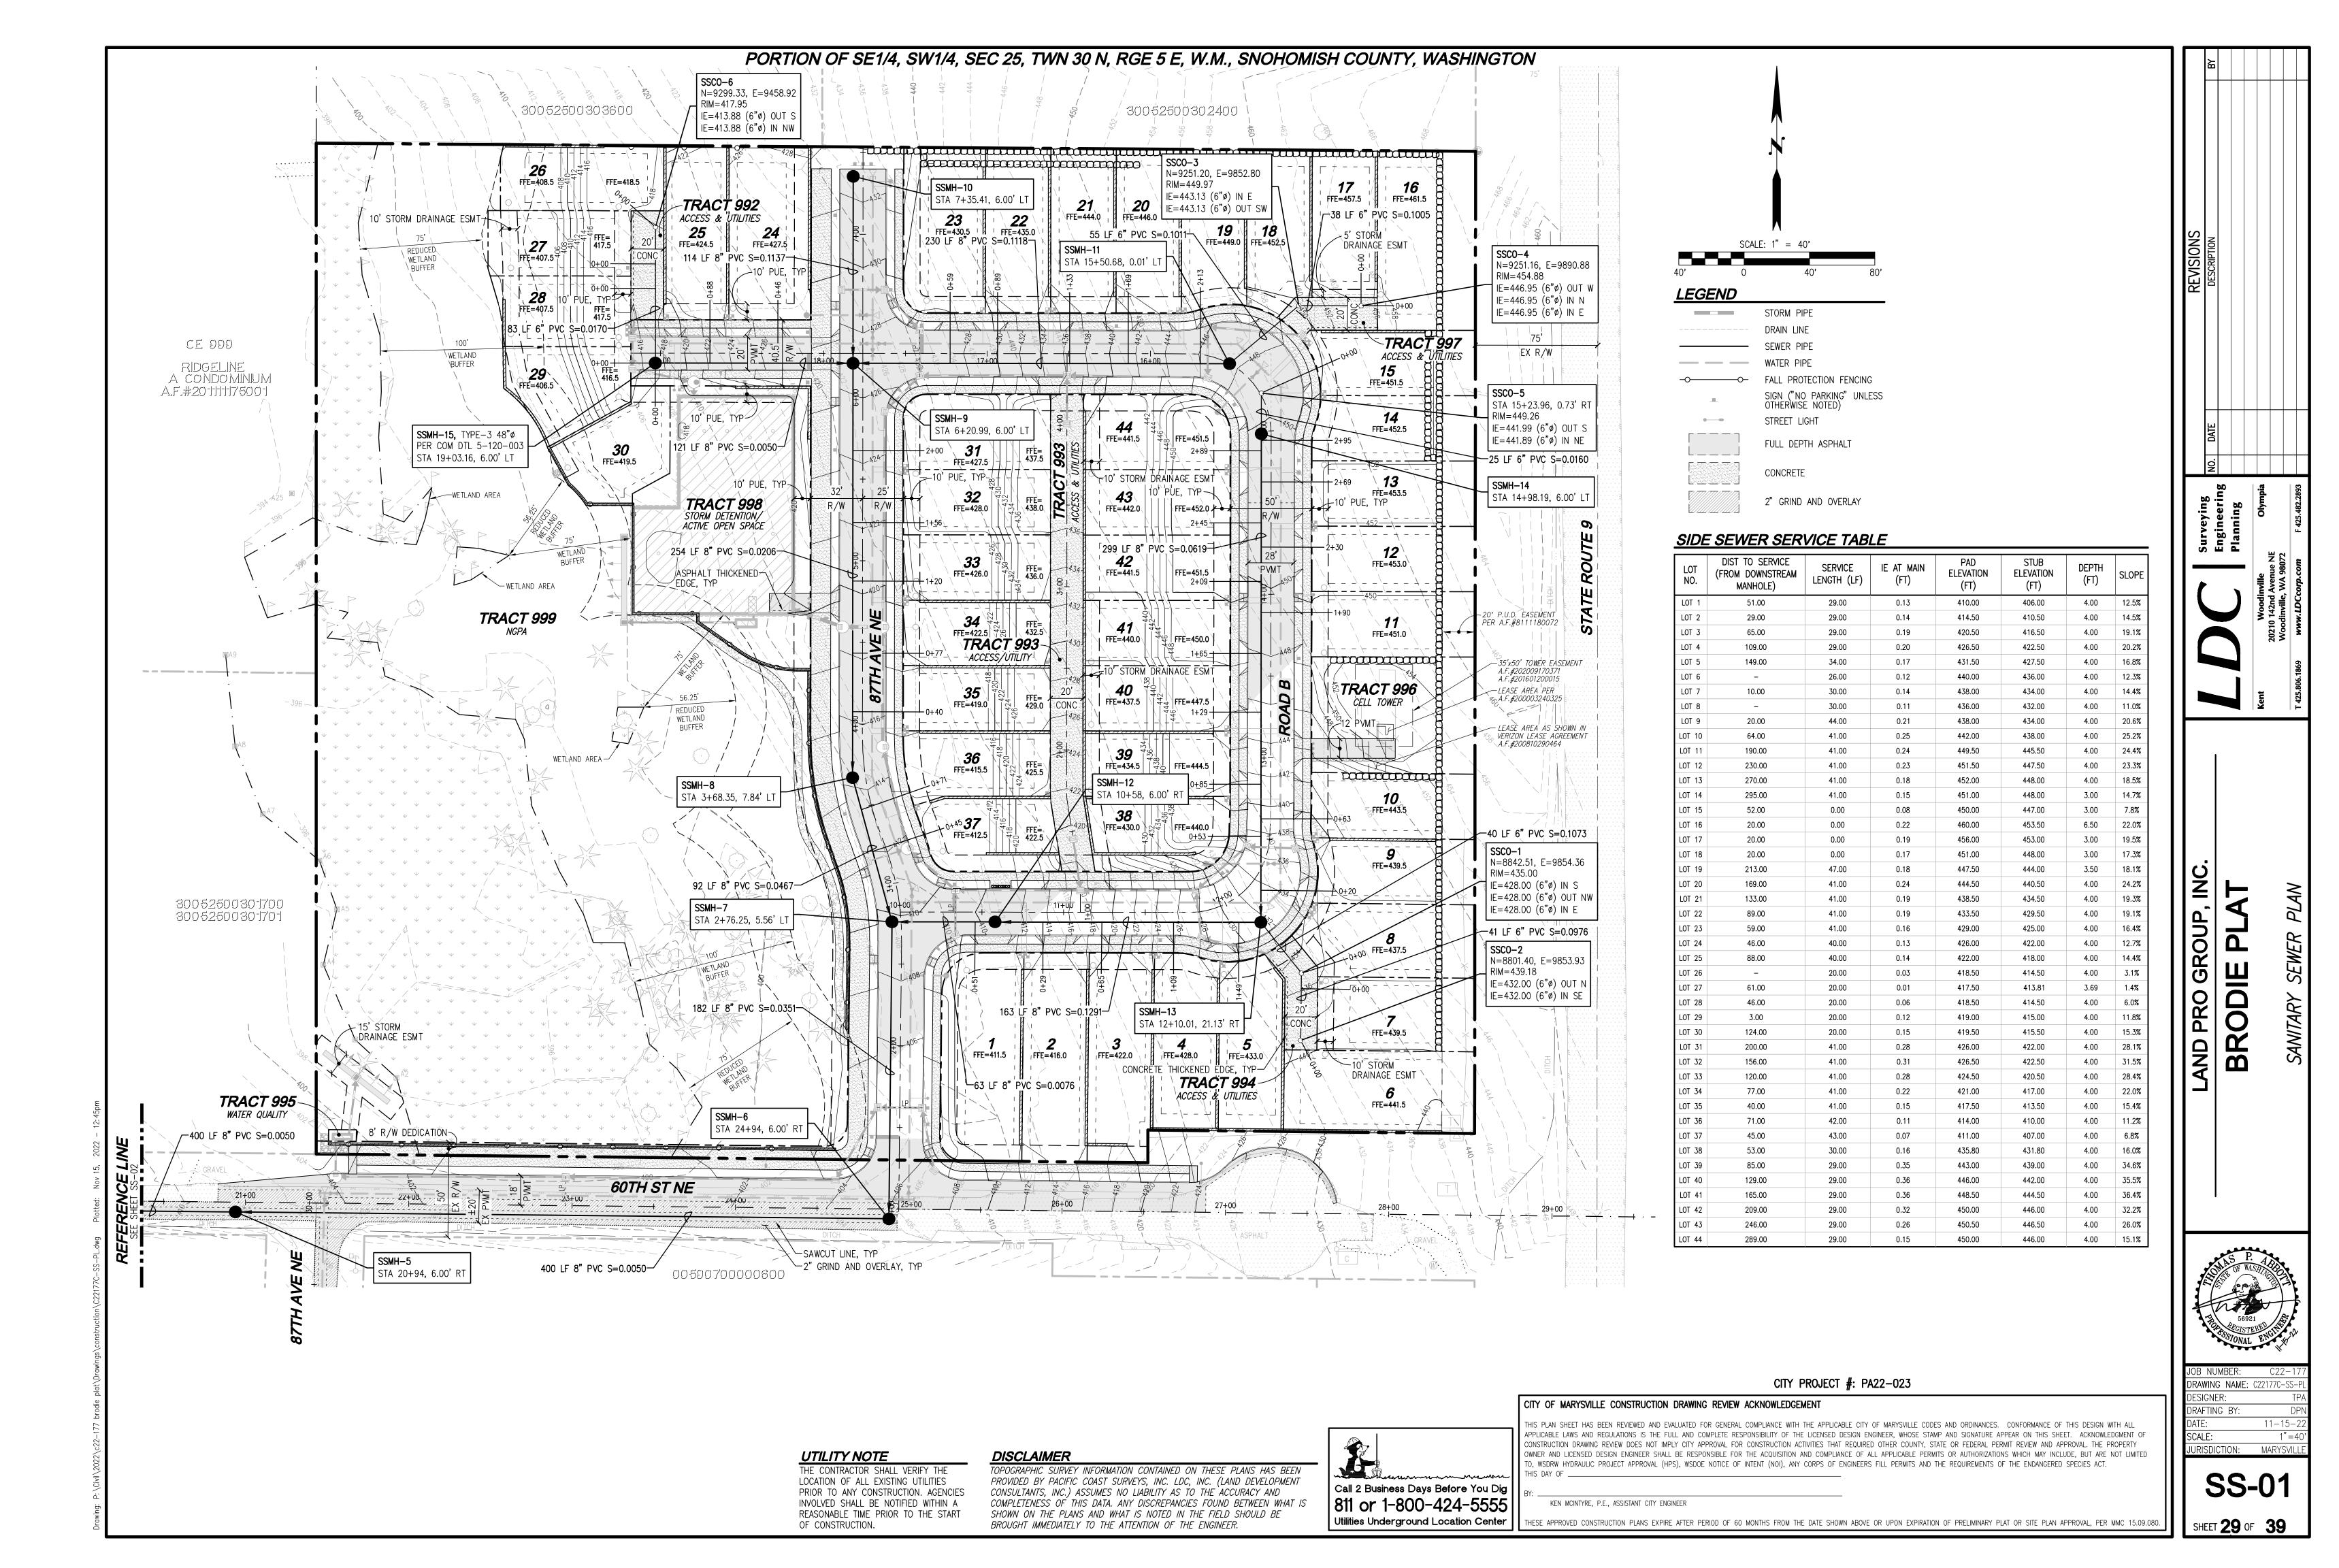
KEN MCINTYRE, P.E., ASSISTANT CITY ENGINEER


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LAND PRO GROUP,

DRAWING NAME: C22177C-RD-DESIGNER: DRAFTING BY: JURISDICTION: MARYSVILI





CITY PROJECT #: PA22-023
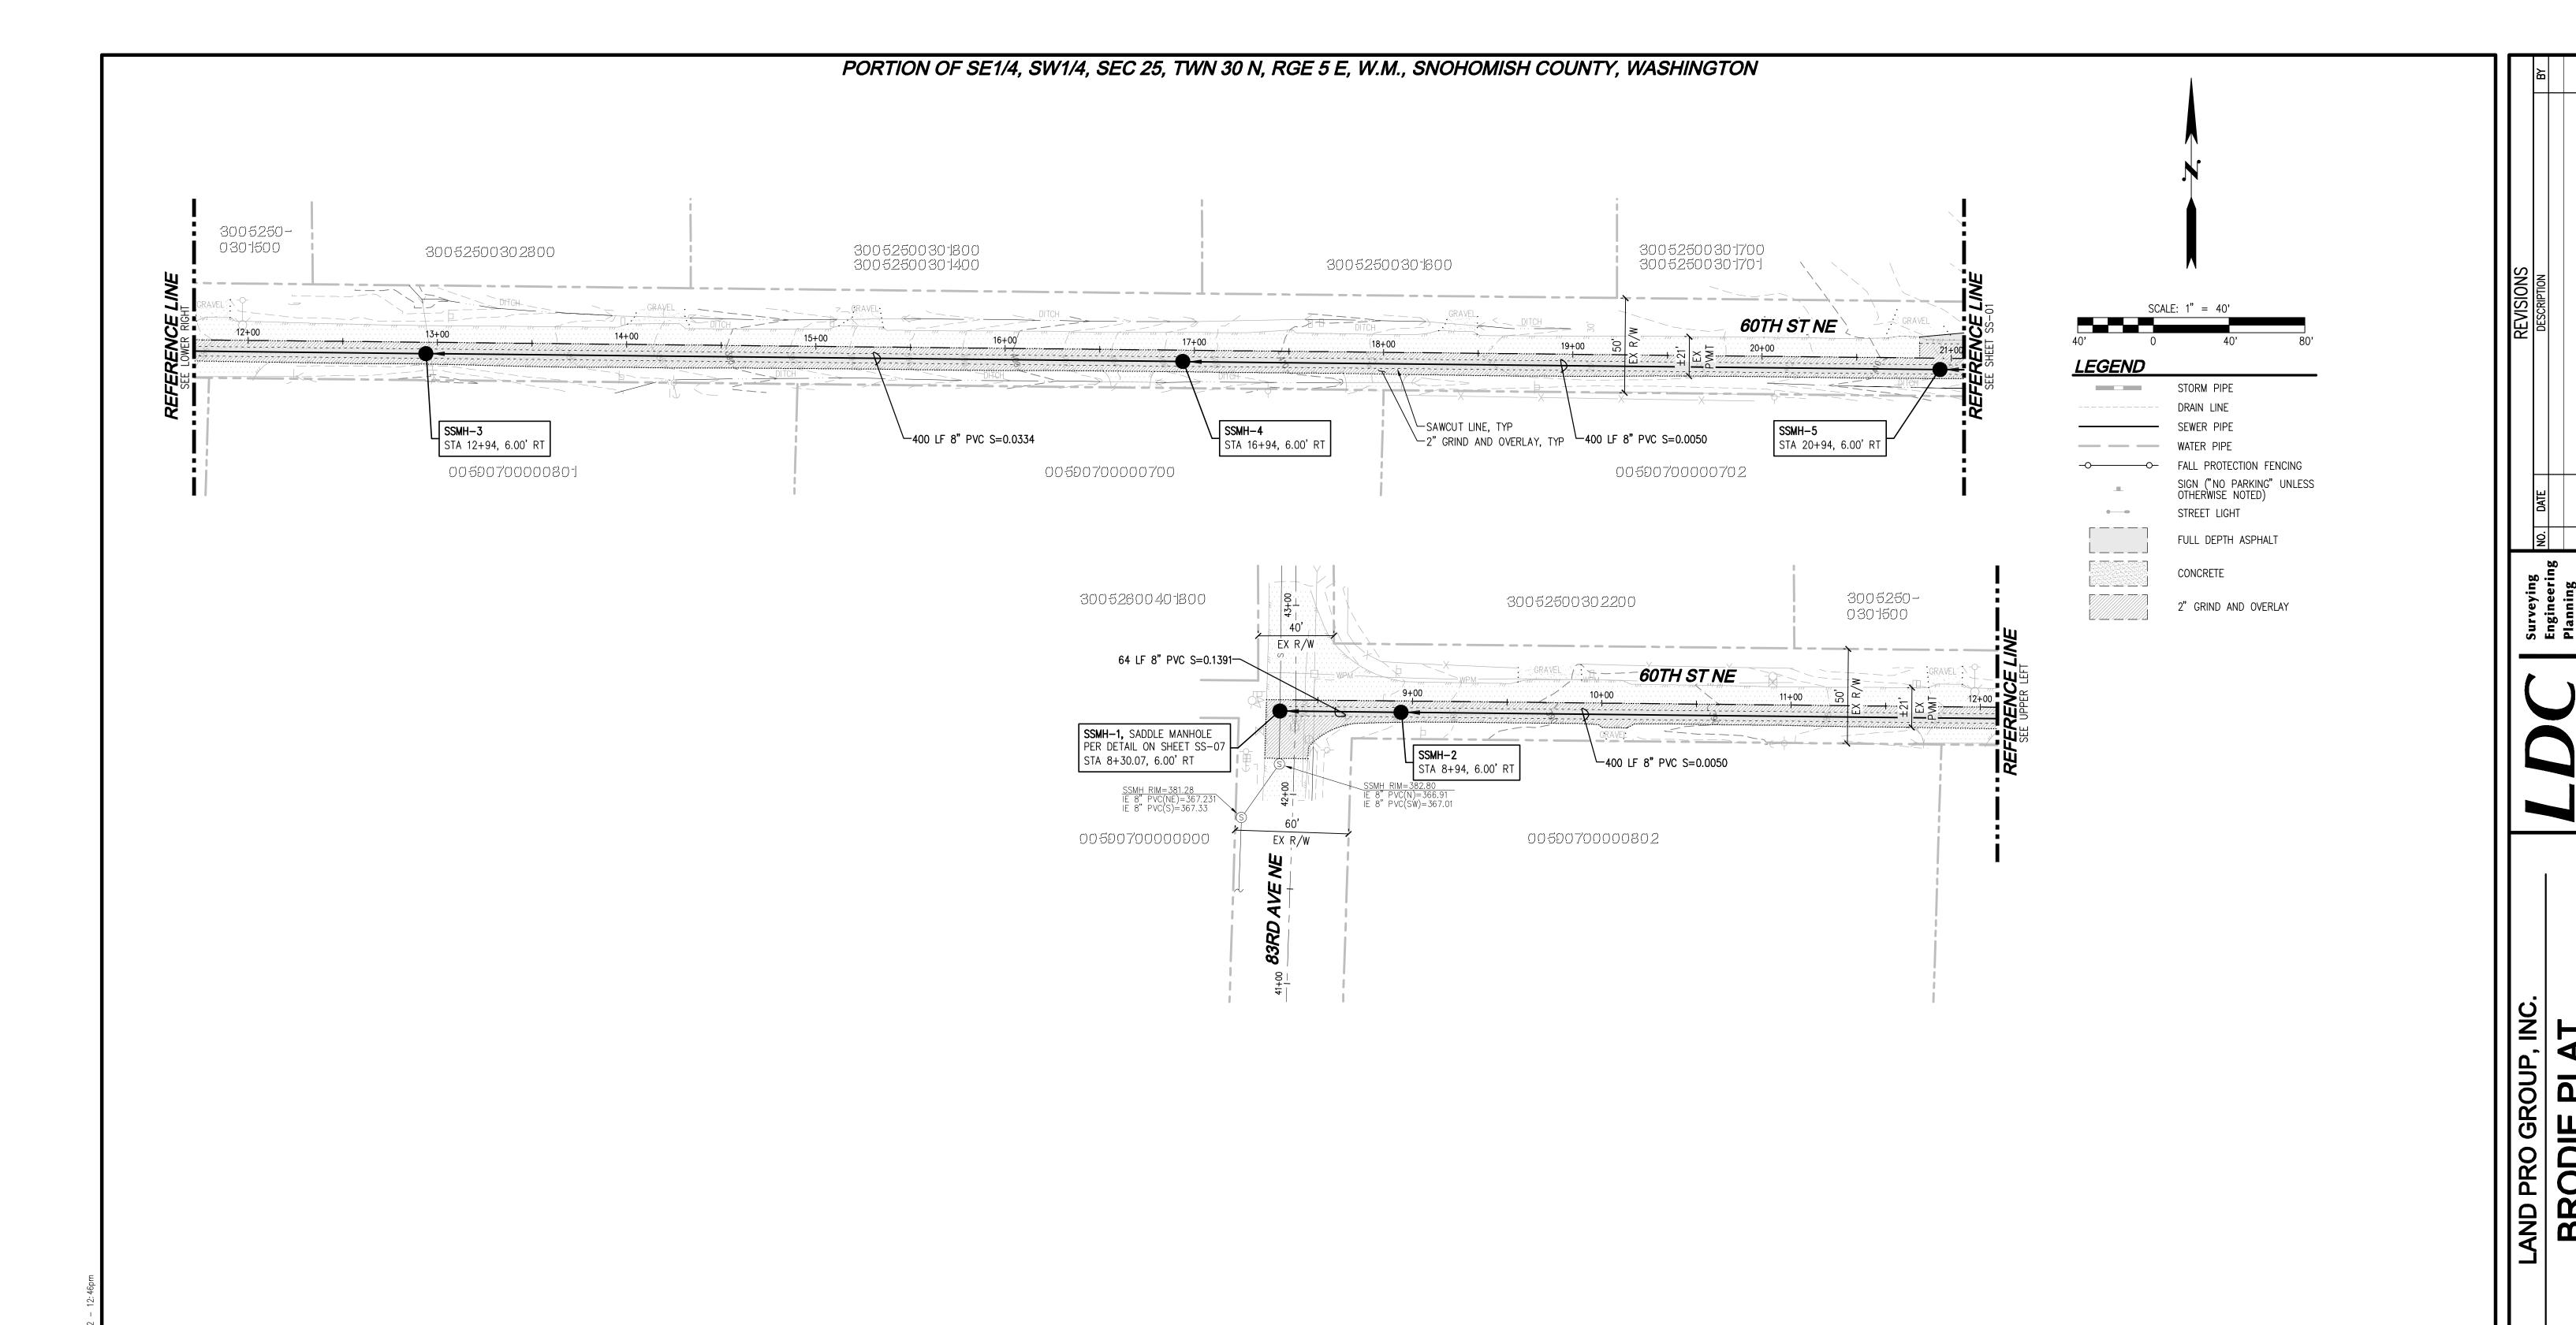
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JOB NUMBER

JOB NUMBER: C22-17
DRAWING NAME: C22177C-SSDESIGNER: TF
DRAFTING BY: DF
DATE: 11-15-2
SCALE: 1"=4
JURISDICTION: MARYSVILI

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SHEET **30** OF **39**


UTILITY NOTE

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DISCLAIMER

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Call 2 Business Days Before You Dig 811 or 1-800-424-5555 Utilities Underground Location Center



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INVOLVED SHALL BE NOTIFIED WITHIN A
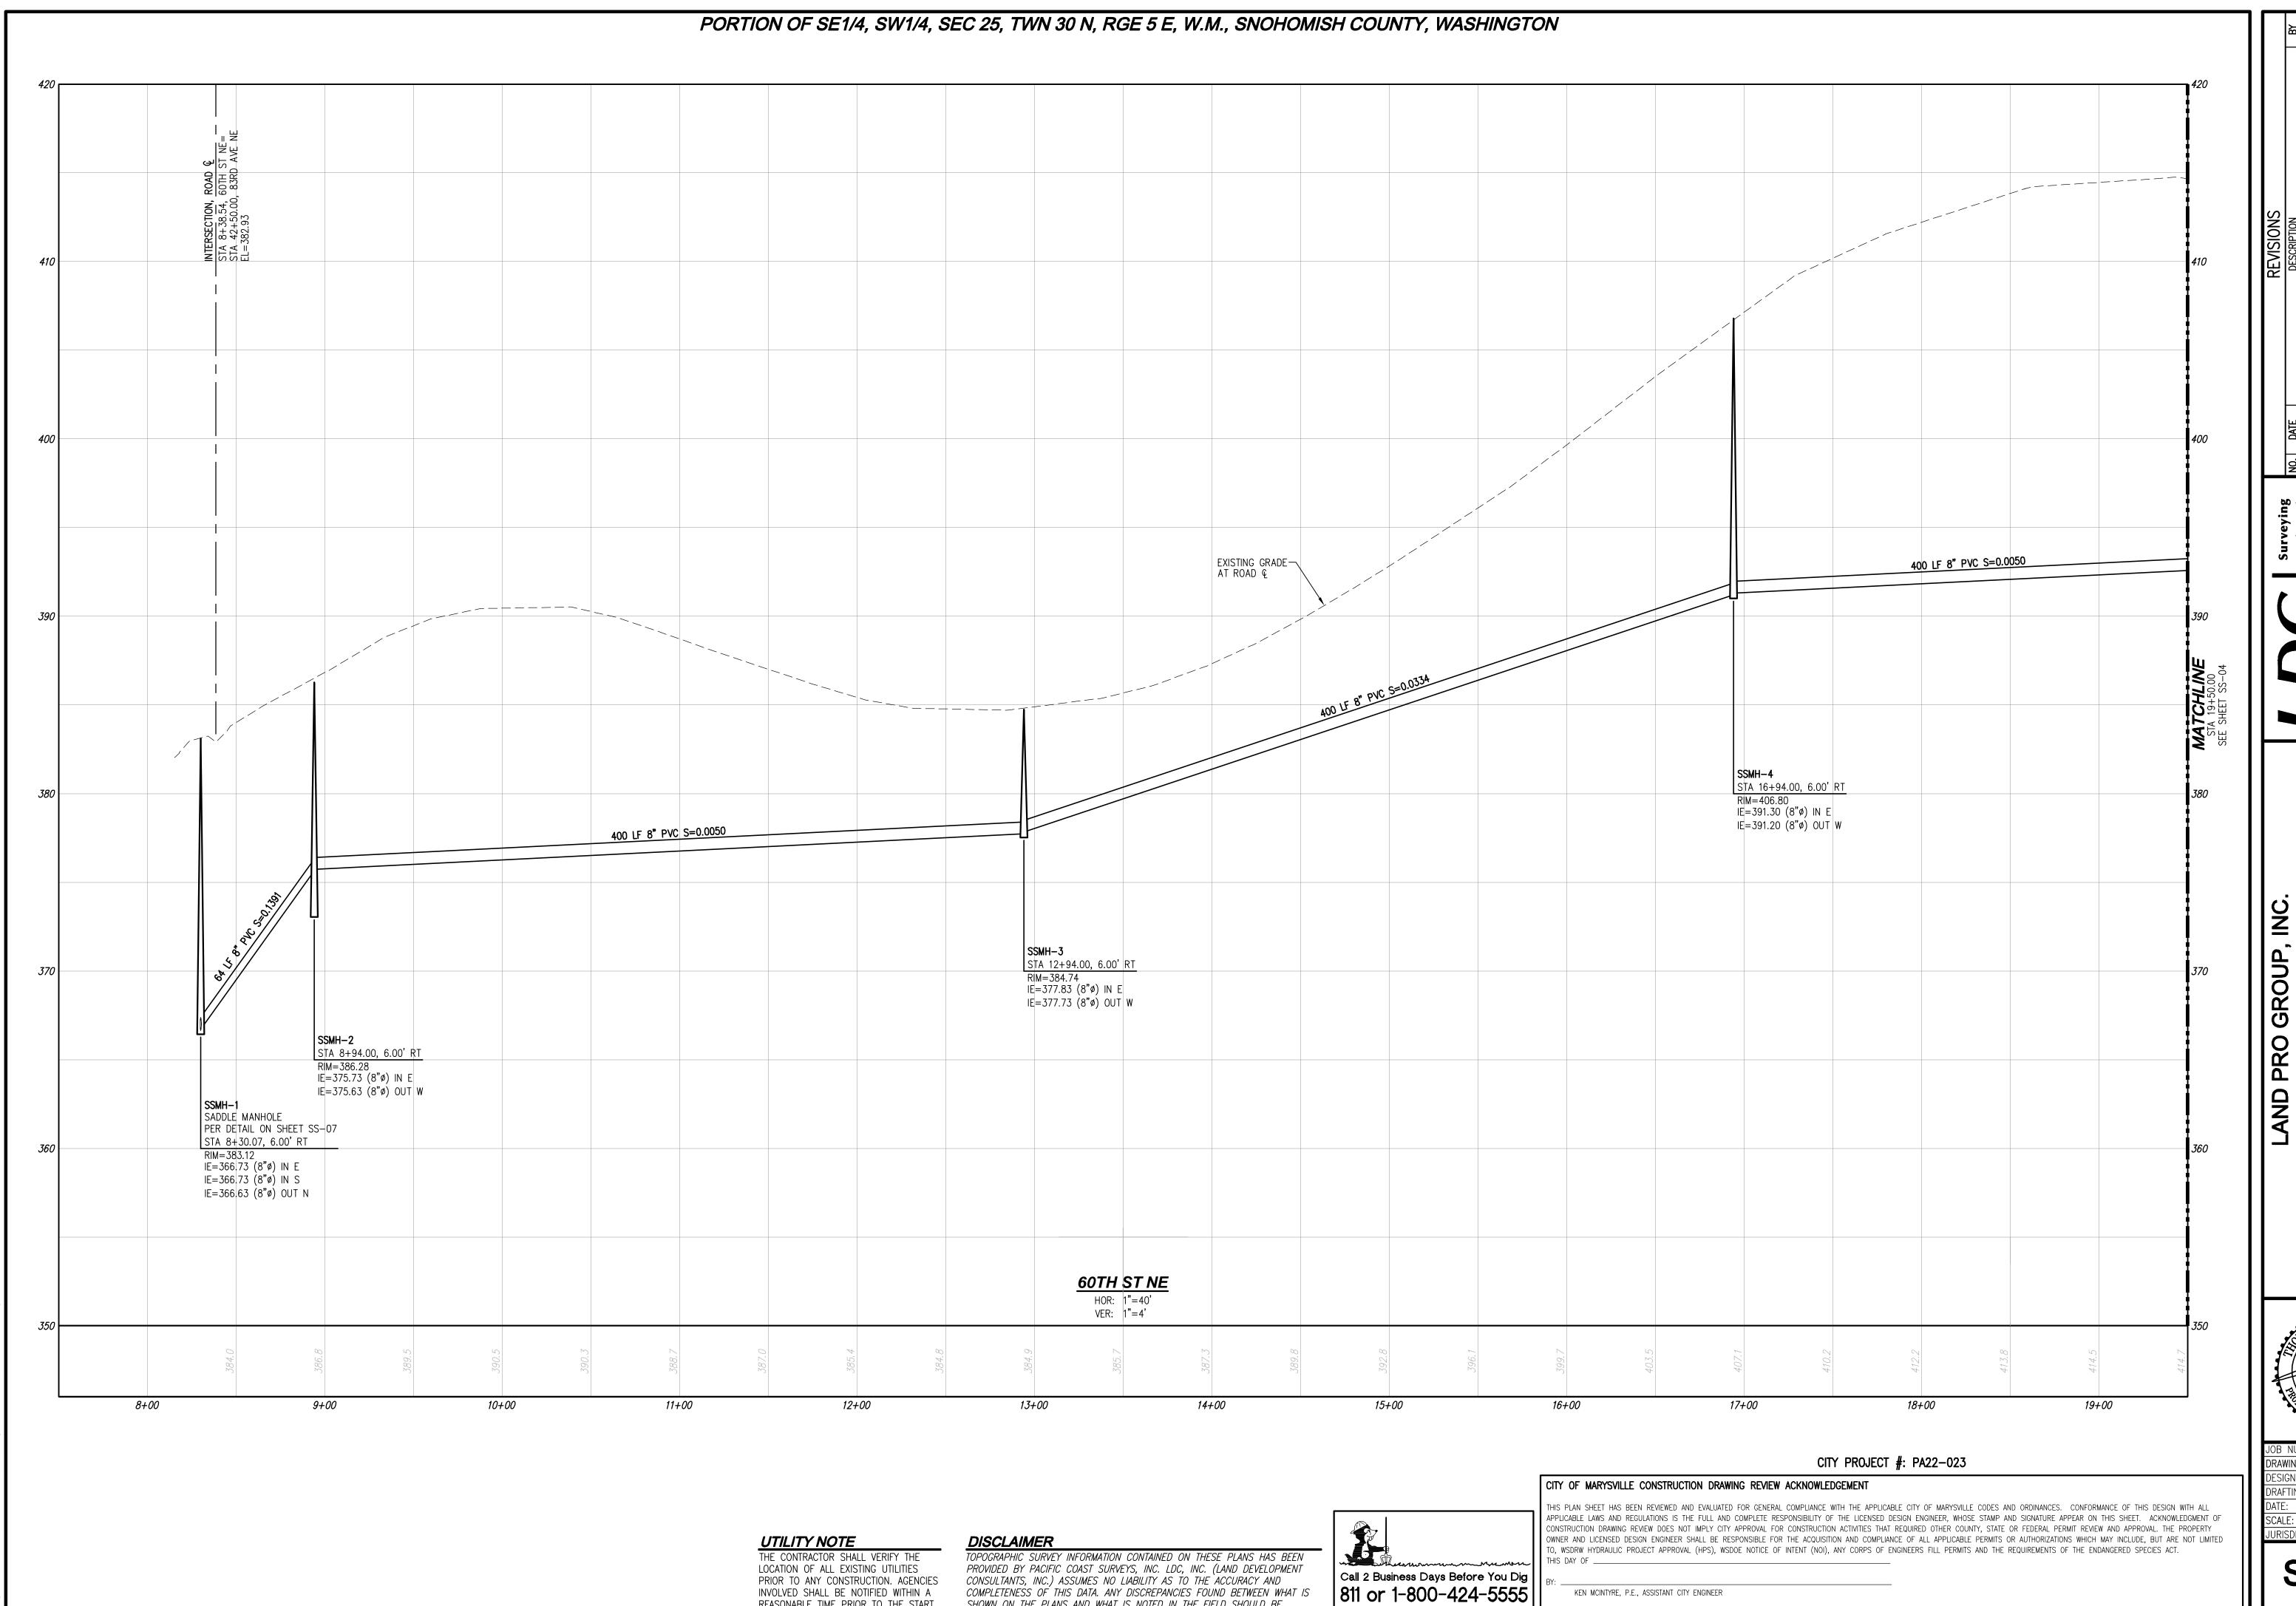
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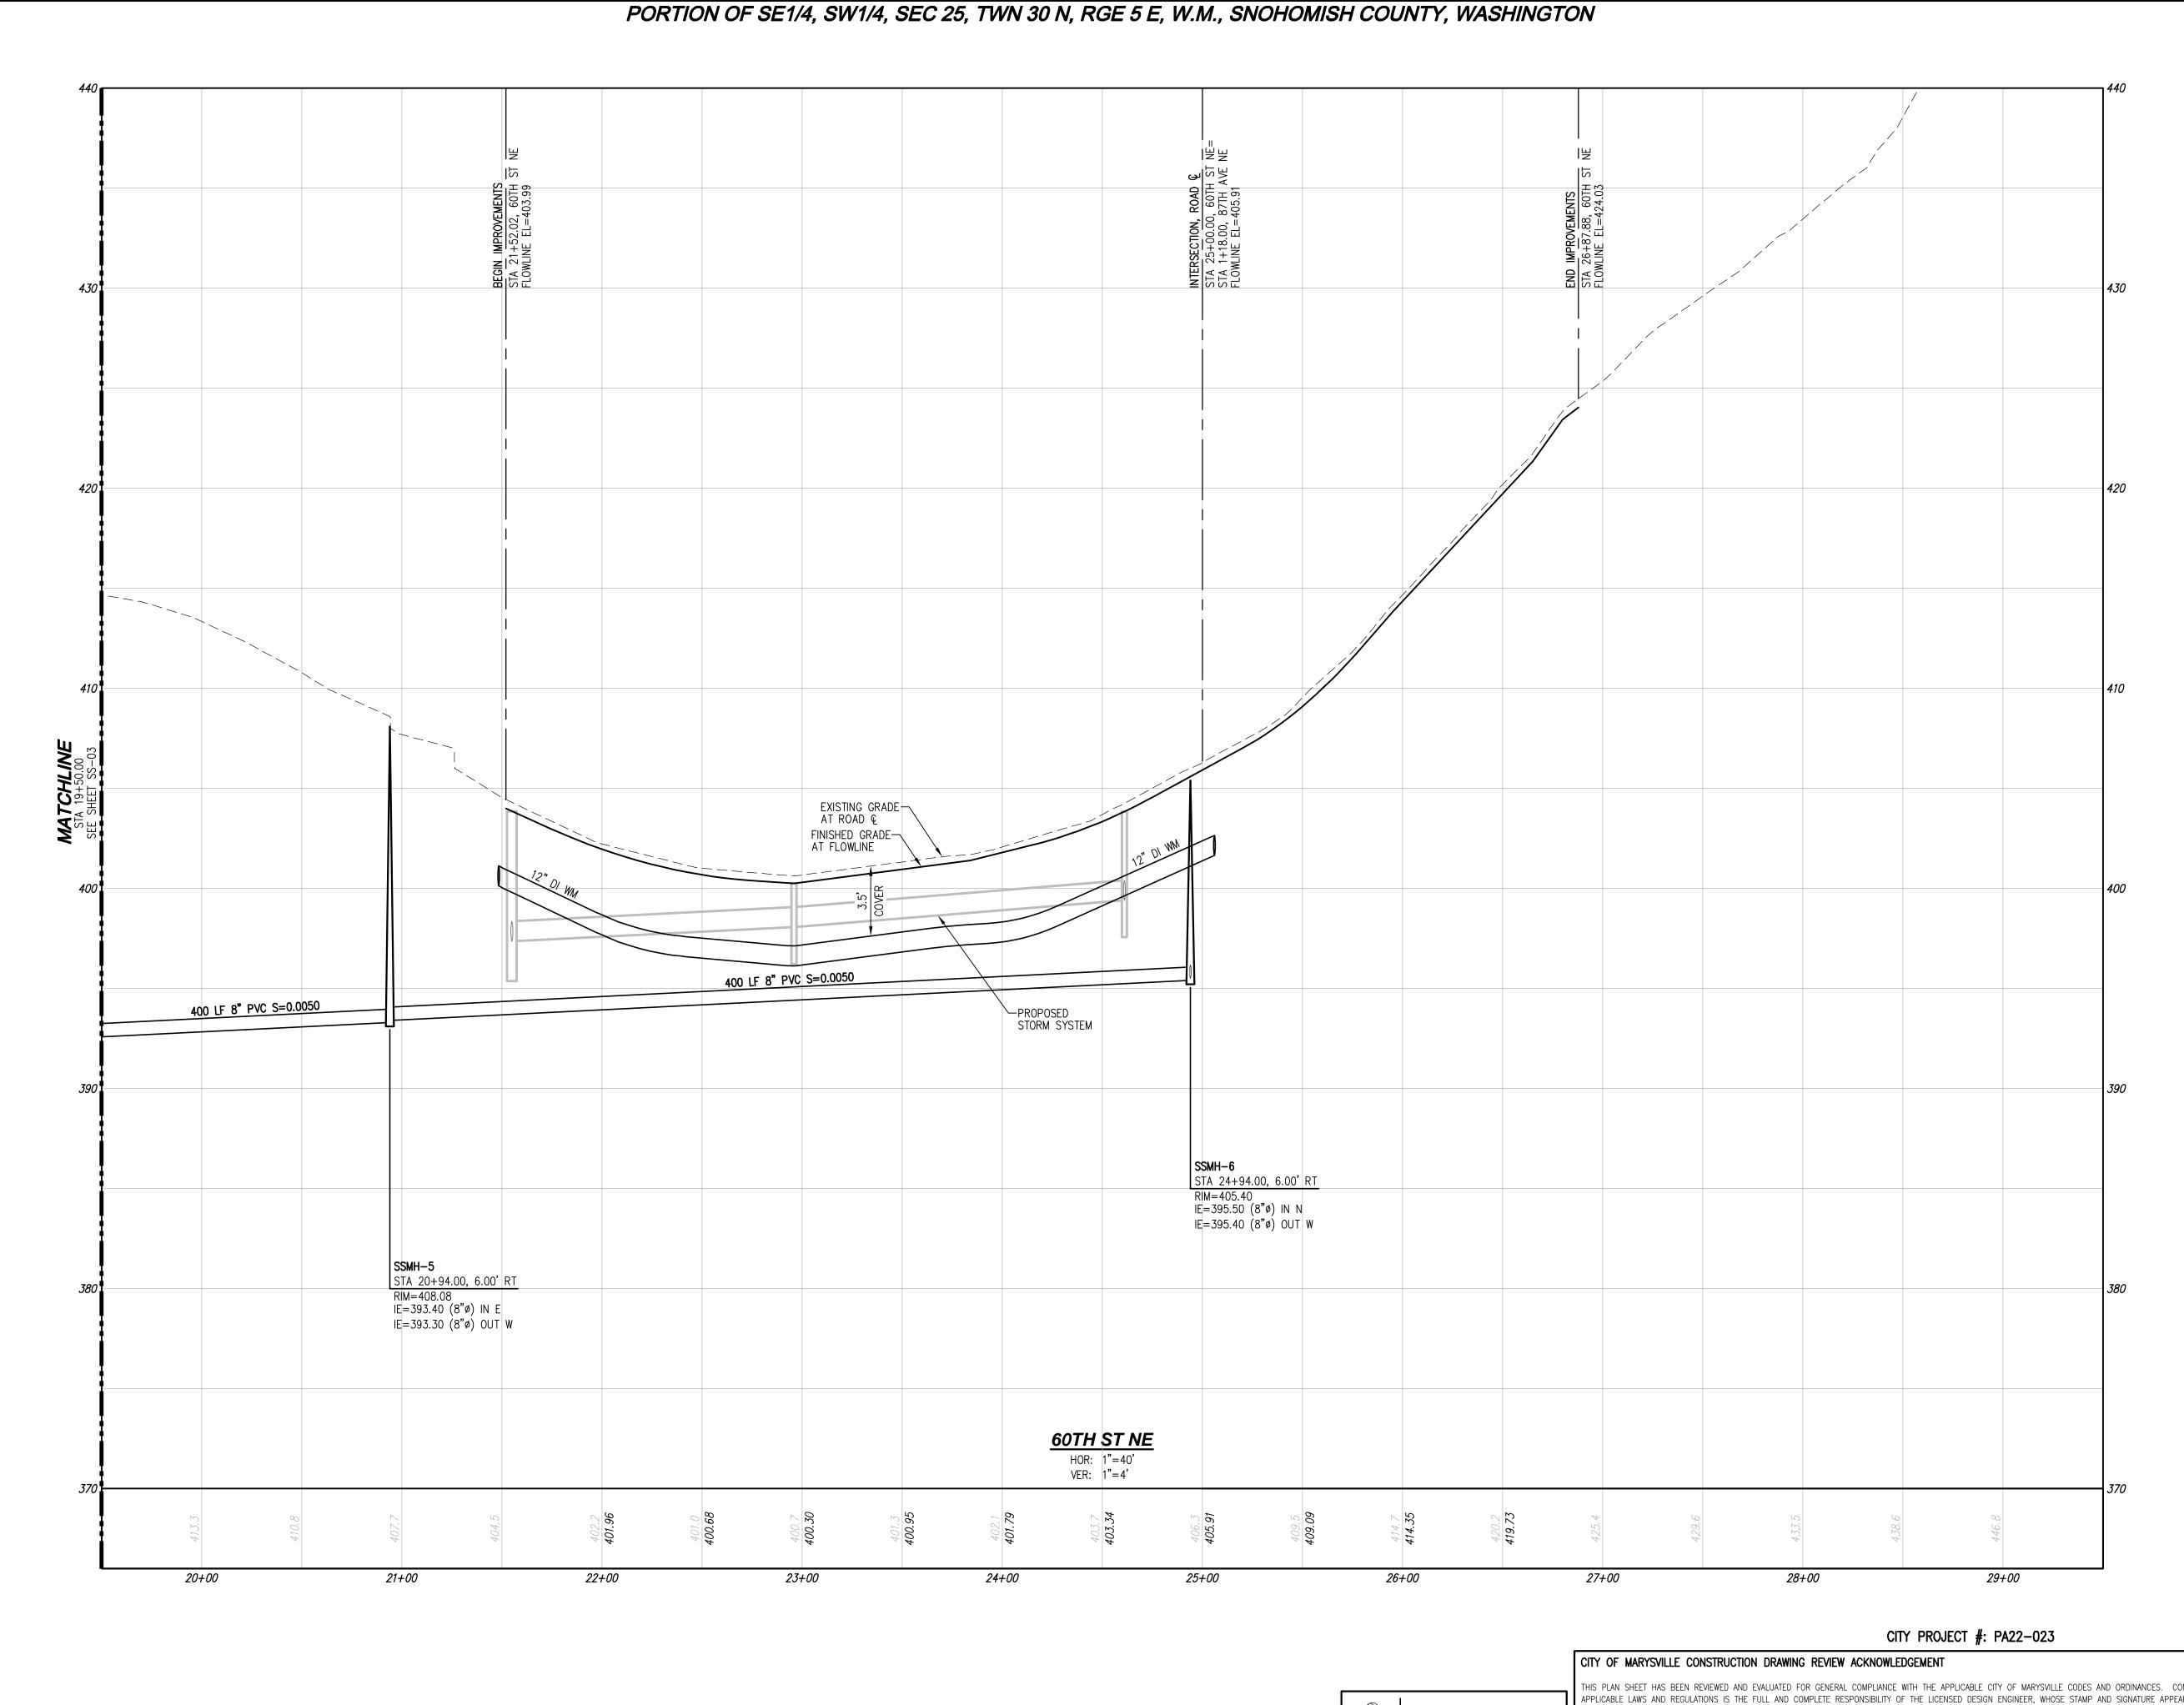
OF CONSTRUCTION.

KEN MCINTYRE, P.E., ASSISTANT CITY ENGINEER

Utilities Underground Location Center

THESE APPROVED CONSTRUCTION PLANS EXPIRE AFTER PERIOD OF 60 MONTHS FROM THE DATE SHOWN ABOVE OR UPON EXPIRATION OF PRELIMINARY PLAT OR SITE PLAN APPROVAL, PER MMC 15.09.080.

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UTILITY NOTE

OF CONSTRUCTION.

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LOCATION OF ALL EXISTING UTILITIES

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CONSULTANTS, INC.) ASSUMES NO LIABILITY AS TO THE ACCURACY AND

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KEN MCINTYRE, P.E., ASSISTANT CITY ENGINEER

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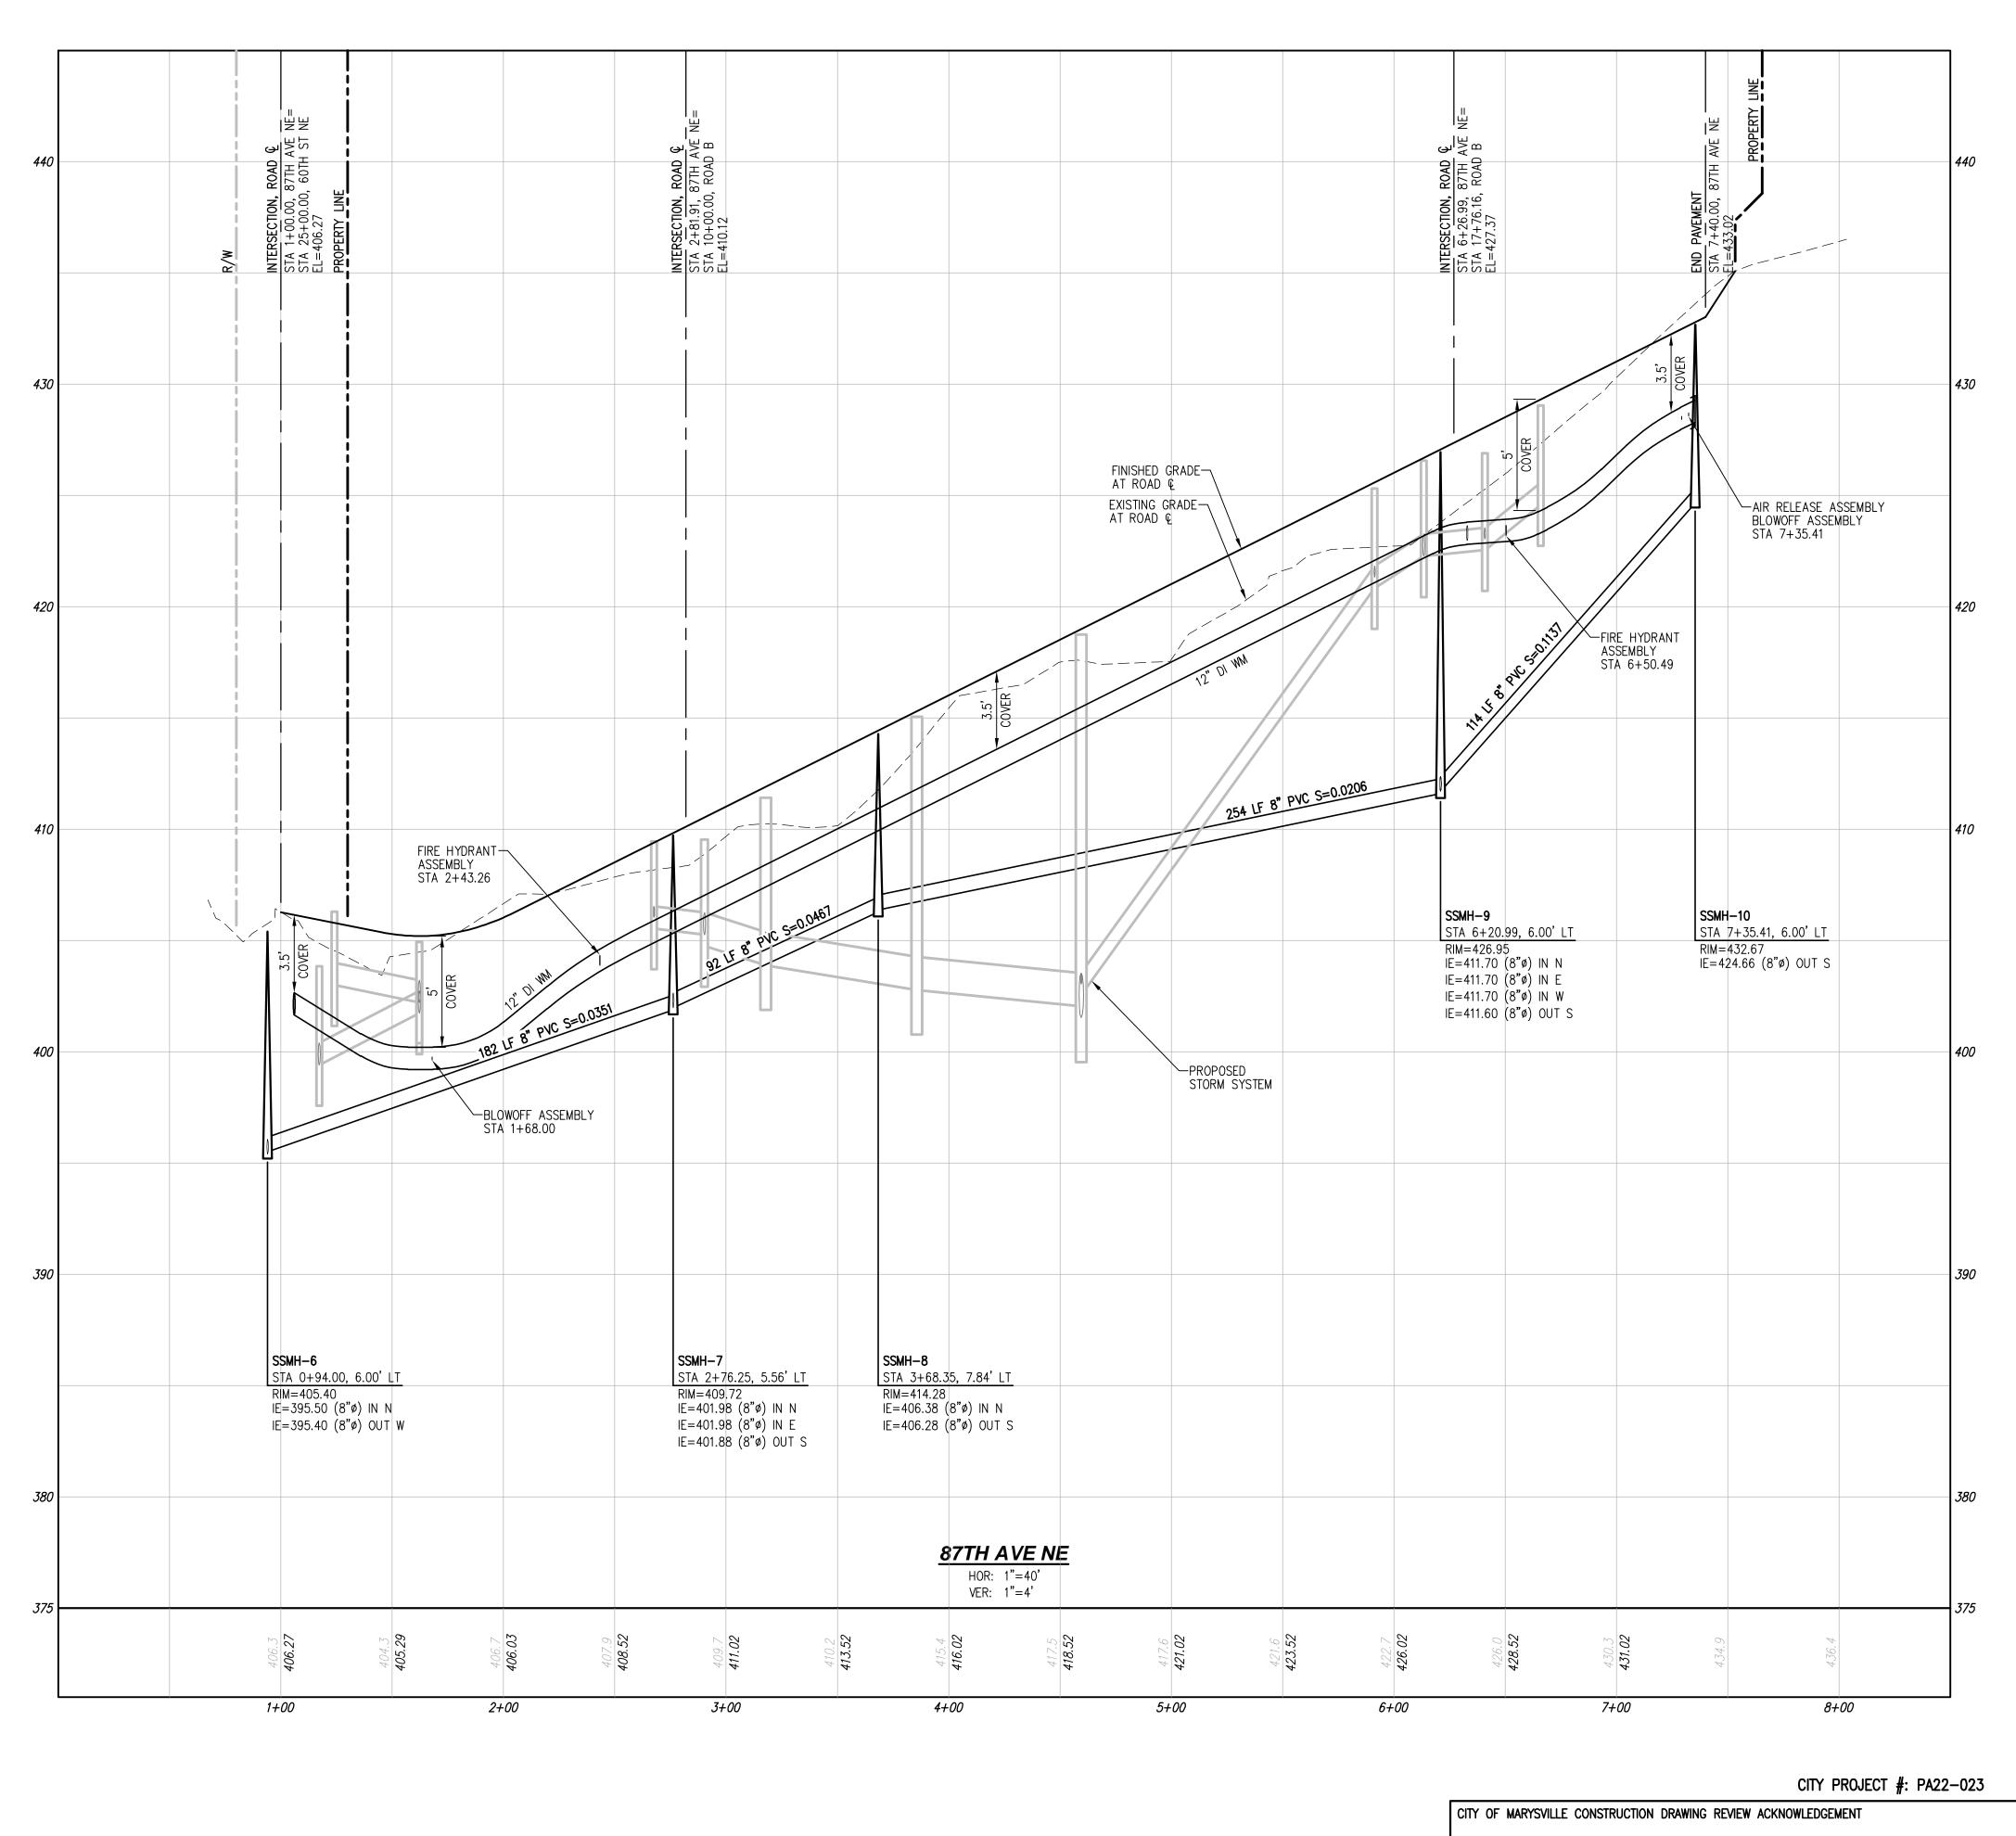
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SHEET **32** OF **39**



UTILITY NOTE THE CONTRACTOR SHALL VERIFY THE LOCATION OF ALL EXISTING UTILITIES PRIOR TO ANY CONSTRUCTION. AGENCIES INVOLVED SHALL BE NOTIFIED WITHIN A REASONABLE TIME PRIOR TO THE START OF CONSTRUCTION.

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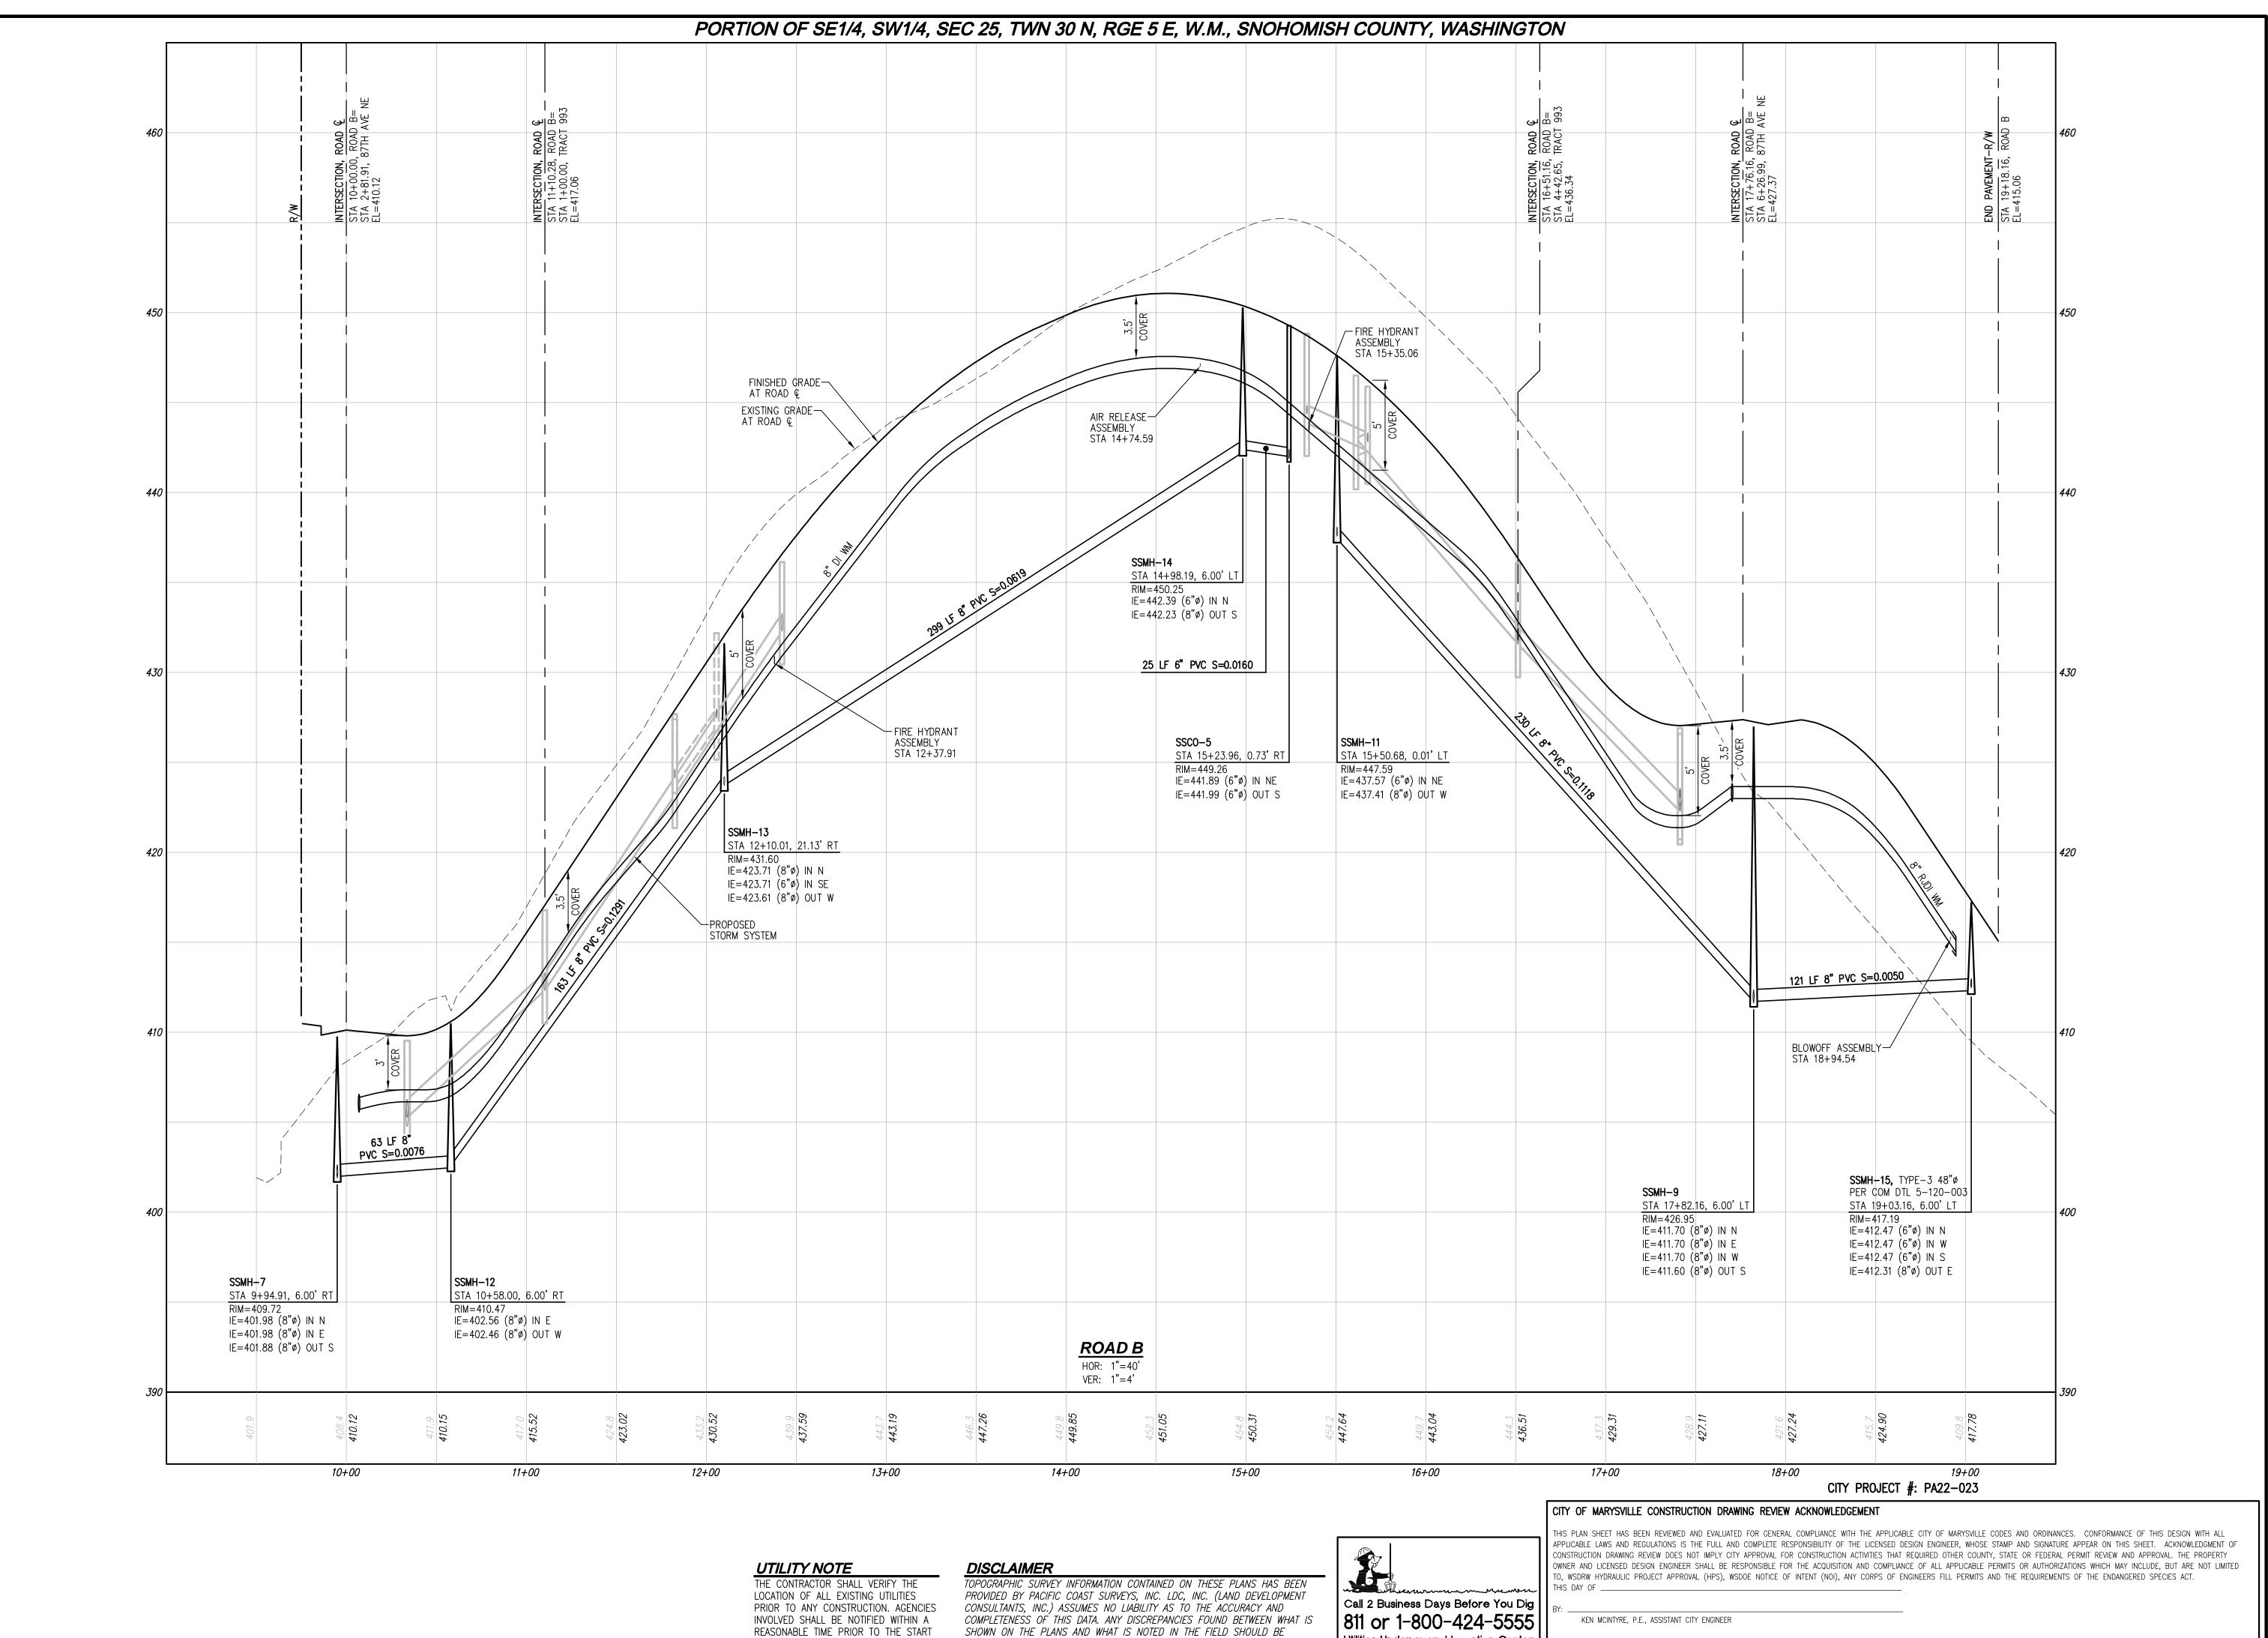
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LAND PRO GROUP, BRODIE

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	JOB NUMBER:	C22-17
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OF CONSTRUCTION.

Utilities Underground Location Center


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DRAWING NAME: C22177C-SS DESIGNER: DRAFTING BY: 11 - 15 - 2

JURISDICTION: MARYSVIL

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CITY PROJECT #: PA22-023

CITY OF MARYSVILLE CONSTRUCTION DRAWING REVIEW ACKNOWLEDGEMENT

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DRAWING NAME: C22177C-SS DESIGNER:

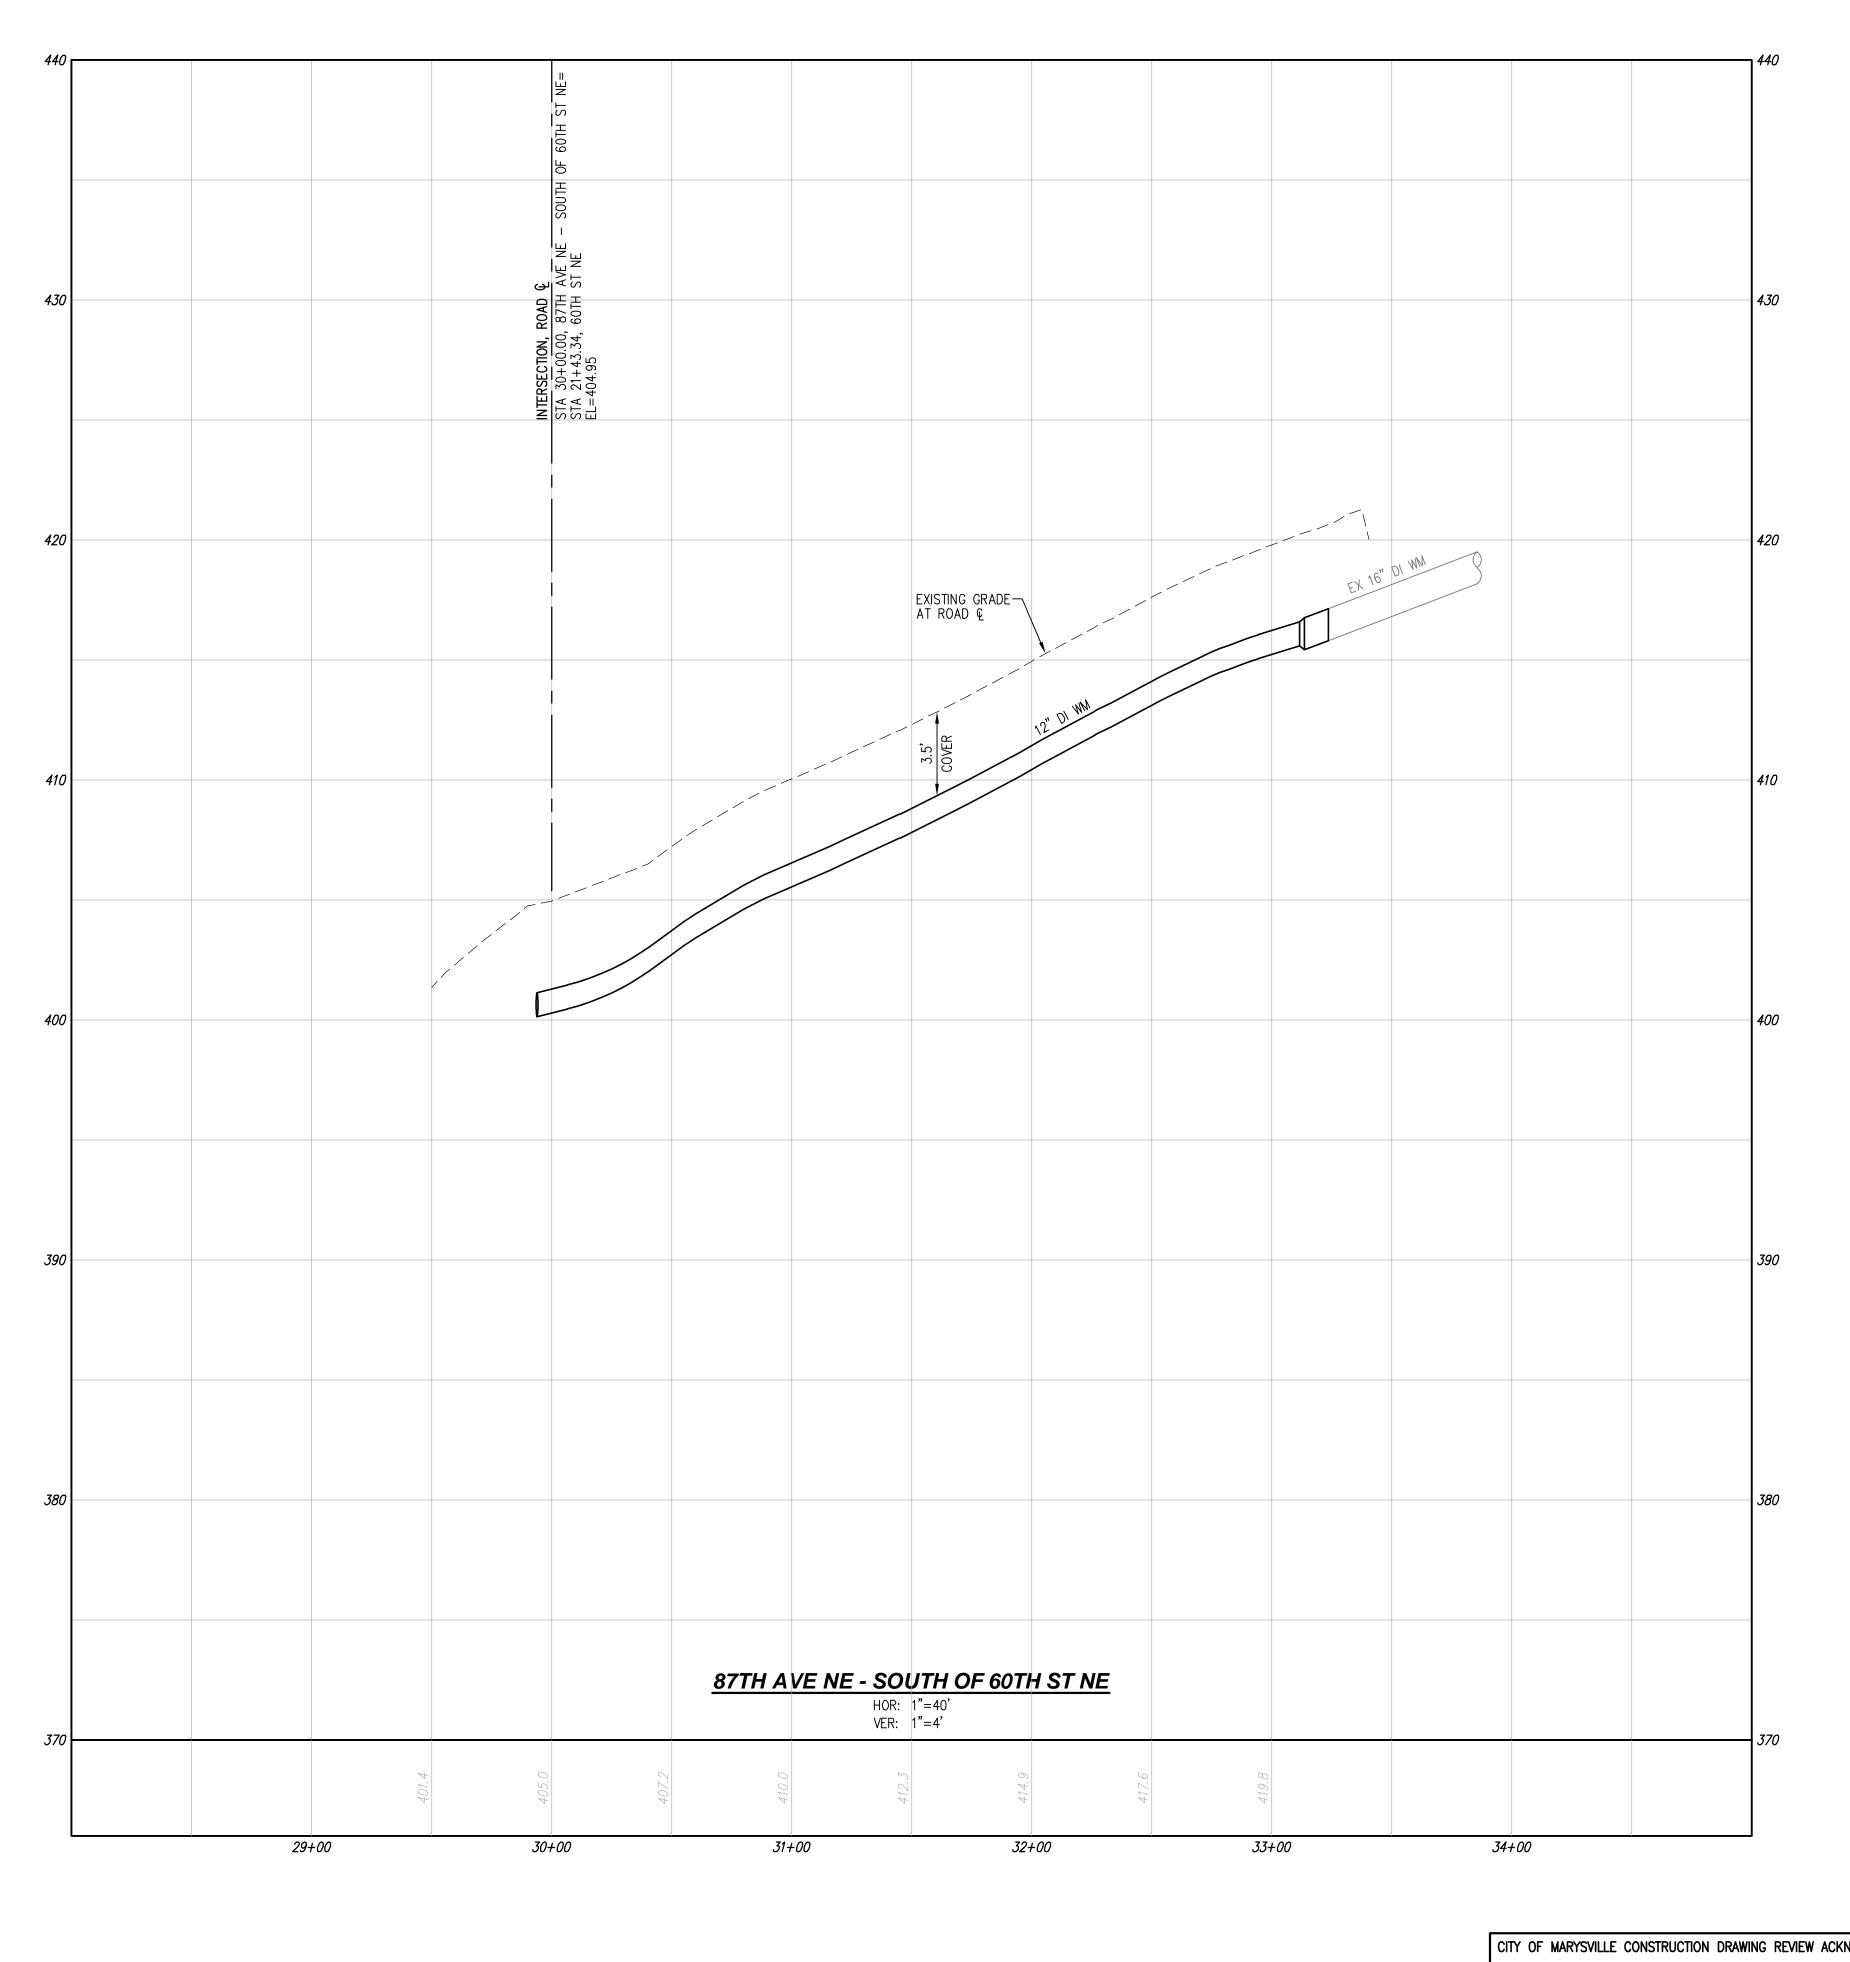LAND PRO GROUP,

DRAFTING BY: JURISDICTION: MARYSVILL

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SANITARY SEWER NOTES

- 1. ALL WORKMANSHIP AND MATERIALS SHALL BE IN ACCORDANCE WITH CITY OF MARYSVILLE STANDARDS AND THE MOST RECENT COPY OF THE STATE OF WASHINGTON STANDARD SPECIFICATIONS FOR ROAD, BRIDGE, AND MUNICIPAL CONSTRUCTION (WSDOT).
- 2. CITY OF MARYSVILLE HORIZONTAL DATUM SHALL BE NAD 83, AND THE VERTICAL DATUM SHALL BE NAVD 88, IN WASHINGTON STATE PLANE COORDINATES (FEET), WASHINGTON NORTH ZONE 4601. A LIST OF BENCHMARKS IS AVAILABLE THROUGH THE PUBLIC WORKS DEPARTMENT.
- 3. ALL APPROVALS AND PERMITS REQUIRED BY THE CITY OF MARYSVILLE SHALL BE OBTAINED BY THE CONTRACTOR PRIOR TO THE START OF CONSTRUCTION.
- 4. IF CONSTRUCTION IS TO TAKE PLACE IN THE COUNTY RIGHT-OF-WAY, THE CONTRACTOR SHALL CONTACT THE CITY PUBLIC WORKS DEPARTMENT TO OBTAIN ALL THE REQUIRED APPROVALS AND PERMITS.
- 5. A PRECONSTRUCTION MEETING SHALL BE HELD WITH THE CITY OF MARYSVILLE DEPARTMENT OF PUBLIC WORKS / COMMUNITY DEVELOPMENT DEPARTMENT PRIOR TO THE START OF CONSTRUCTION.


 6. THE CITY OF MARYSVILLE COMMUNITY DEVELOPMENT DEPARTMENT SHALL BE NOTIFIED A MINIMUM OF
- 6. THE CITY OF MARYSVILLE COMMUNITY DEVELOPMENT DEPARTMENT SHALL BE NOTIFIED A MINIMUM OF 48 HOURS IN ADVANCE OF A TAP OR CONNECTION TO AN EXISTING SANITARY SEWER MAIN. THE INSPECTOR SHALL BE PRESENT AT THE TIME OF THE TAP OR CONNECTION.
- 7. THE CONTRACTOR SHALL BE FULLY RESPONSIBLE FOR THE LOCATION AND PROTECTION OF ALL EXISTING UTILITIES. THE CONTRACTOR SHALL VERIFY ALL UTILITY LOCATIONS PRIOR TO CONSTRUCTION BY CALLING THE UNDERGROUND LOCATE LINE AT 1-800-424-5555 A MINIMUM OF 48 HOURS PRIOR TO ANY EXCAVATION.
- 8. GRAVITY SEWER MAIN WITH ≤5' OF COVER SHALL BE D.I.P. CLASS 52; 5'-18' OF COVER SHALL BE PVC, ASTM D 3034 SDR 35, OR ASTM F 789 WITH JOINTS AND RUBBER GASKETS CONFORMING TO ASTM D 3212 AND ASTM F 477; >18' COVER SHALL BE D.I.P. CLASS 52, OR C-900.
- 9. PRECAST MANHOLES SHALL MEET THE REQUIREMENTS OF ASTM C 478. MANHOLES SHALL BE TYPE 1–48" MANHOLE UNLESS OTHERWISE SPECIFIED ON THE PLANS. JOINTS SHALL BE RUBBER GASKETED CONFORMING TO ASTM C 443 AND SHALL BE GROUTED FROM THE INSIDE. LIFT HOLES SHALL BE GROUTED FROM THE OUTSIDE AND INSIDE OF THE MANHOLE.
- 10. SIDE SEWER SERVICES SHALL BE PVC, ASTM D 3034 SDR 35 WITH FLEXIBLE GASKETED JOINTS. SIDE SEWER CONNECTIONS SHALL BE MADE BY A TAP TO AN EXISTING MAIN OR A TEE FROM A NEW MAIN CONNECTED ABOVE THE SPRINGLINE OF THE PIPE.
- 11. ALL SEWER MAINS SHALL BE FIELD STAKED FOR GRADES AND ALIGNMENT PRIOR TO CONSTRUCTION BY A LICENSED ENGINEER OR SURVEYING FIRM QUALIFIED TO PERFORM SUCH WORK. PRIOR TO CONSTRUCTING ANY SEWER, THE LOT CORNERS SHALL BE STAKED AND SEWER LINE LOCATION ESTABLISHED BY SURVEY, COST OF WHICH SHALL BE BORNE BY THE DEVELOPER.
- 12. ALL PLASTIC PIPE AND SERVICES SHALL BE INSTALLED WITH CONTINUOUS TRACER TAPE INSTALLED 12" TO 18" UNDER THE PROPOSED FINISHED SUBGRADE. THE MARKER SHALL BE PLASTIC NON-BIODEGRADABLE, METAL CORE OR BACKING MARKED SEWER WHICH CAN BE DETECTED BY A STANDARD METAL DETECTOR.
- 13. EACH SIDE SEWER LATERAL SHALL HAVE A 2" X 4" WOOD "MARKER" AT THE TERMINATION OF THE STUB. THE "MARKER" SHALL EXTEND FROM THE TRENCH TO ABOVE FINISHED GRADE. ABOVE THE GROUND SURFACE, IT SHALL BE PAINTED "GREEN" WITH SEWER AND THE DEPTH, IN FEET, STENCILED IN WHITE LETTERS 2" HIGH.
- 14. SIDE SEWERS SHALL BE INSTALLED BY THE DEVELOPER AND COORDINATED FOR CLEARANCE WITH POWER, TELEPHONE, AND OTHER UTILITIES. ALL SIDE SEWERS TO BE INSTALLED 10 FEET INTO LOT SERVED AND STAKED AND MARKED AS SHOWN ON THESE PLANS.
- 15. PIPE BEDDING SHALL BE IN ACCORDANCE WITH WSDOT STANDARD PLAN B-18C CLASS F. PEA GRAVEL IS AN ACCEPTABLE BEDDING MATERIAL. ALL PIPE SHALL BE LAID ON A PROPERLY PREPARED FOUNDATION ACCORDING TO STANDARD SPECIFICATION 7-02.3(1). THIS SHALL INCLUDE NECESSARY LEVELING OF THE TRENCH BOTTOM OR THE TOP OF THE FOUNDATION MATERIALS AS WELL AS PLACEMENT AND COMPACTION OF REQUIRED BEDDING MATERIAL TO UNIFORM GRADE SO THAT THE ENTIRE LENGTH OF THE PIPE WILL BE SUPPORTED AN A UNIFORMLY DENSE UNYIELDING BASE.
- 16. A 6 FOOT SQUARE X 4-INCH THICK CONCRETE PAD SHALL BE INSTALLED AROUND ALL SSMH'S AND A 3 FOOT SQUARE X 4-INCH THICK CONCRETE PAD SHALL BE INSTALLED AROUND ALL CLEANOUTS THAT ARE NOT IN A PAVEMENT AREA.
- 17. TEMPORARY STREET PATCHING SHALL BE ALLOWED FOR AS APPROVED BY THE CITY ENGINEER.
 TEMPORARY STREET PATCHING SHALL BE PROVIDED BY PLACEMENT AND COMPACTION OF ATB OR
 CLASS B ASPHALT CONCRETE. CONTRACTOR SHALL BE RESPONSIBLE FOR MAINTENANCE AS REQUIRED.
- 18. EROSION CONTROL MEASURE SHALL BE TAKEN BY THE CONTRACTOR DURING CONSTRUCTION TO PREVENT INFILTRATION AND INFLOW INTO EXISTING AND PROPOSED SANITARY SEWER FACILITIES.
- 19. PROVIDE TRAFFIC CONTROL PLAN(S) IN ACCORDANCE WITH THE MANUAL ON UNIFORM TRAFFIC CONTROL DEVICES (MUTCD) AS REQUIRED.20. IT SHALL BE THE RESPONSIBILITY OF THE CONTRACTOR TO HAVE A COPY OF THESE APPROVED
- PLANS ON CONSTRUCTION SITE AT ALL TIMES.


 21. ANY CHANGES TO THE DESIGN SHALL FIRST BE REVIEWED AND APPROVED BY THE PROJECT ENGINEER
- AND THE CITY OF MARYSVILLE.


 22. ALL LINES SHALL BE CLEANED AND PRESSURE TESTED PRIOR TO PAVING IN CONFORMANCE WITH THE ABOVE REFERENCED SPECIFICATIONS. (SEE NOTE 1.) TESTING OF THE SANITARY SEWER MAIN SHALL INCLUDE TV—ING OF THE MAIN BY THE CONTRACTOR. IMMEDIATELY PRIOR TO TV—ING, ENOUGH WATER SHALL BE RUN DOWN THE LINE SO IT COMES OUT THE LOWER MANHOLE. A COPY OF THE VIDEO TAPE SHALL BE SUBMITTED TO THE CITY OF MARYSVILLE. ACCEPTANCE OF THE LINE WILL BE MADE AFTER THE TAPE HAS BEEN REVIEWED AND APPROVED BY PUBLIC WORKS. A WATER TEST OF ALL MANHOLES IN ACCORDANCE WITH MARYSVILLE STANDARD MAY ALSO BE REQUIRED. TESTING SHALL
- SUBGRADE IS COMPLETED.


 23. PRIOR TO BACKFILL ALL MAINS AND APPURTENANCES SHALL BE INSPECTED AND APPROVED BY THE CITY OF MARYSVILLE DEPARTMENT OF PUBLIC WORKS. APPROVAL SHALL NOT RELIEVE THE CONTRACTOR FOR CORRECTION OF ANY DEFICIENCIES AND/OR FAILURES AS DETERMINED BY SUBSEQUENT TESTING AND INSPECTIONS. IT SHALL BE THE CONTRACTOR'S RESPONSIBILITY TO NOTIFY THE CITY OF MARYSVILLE FOR THE REQUIRED INSPECTIONS.


TAKE PLACE AFTER ALL UNDERGROUND UTILITIES ARE INSTALLED AND COMPACTION OF THE ROADWAY

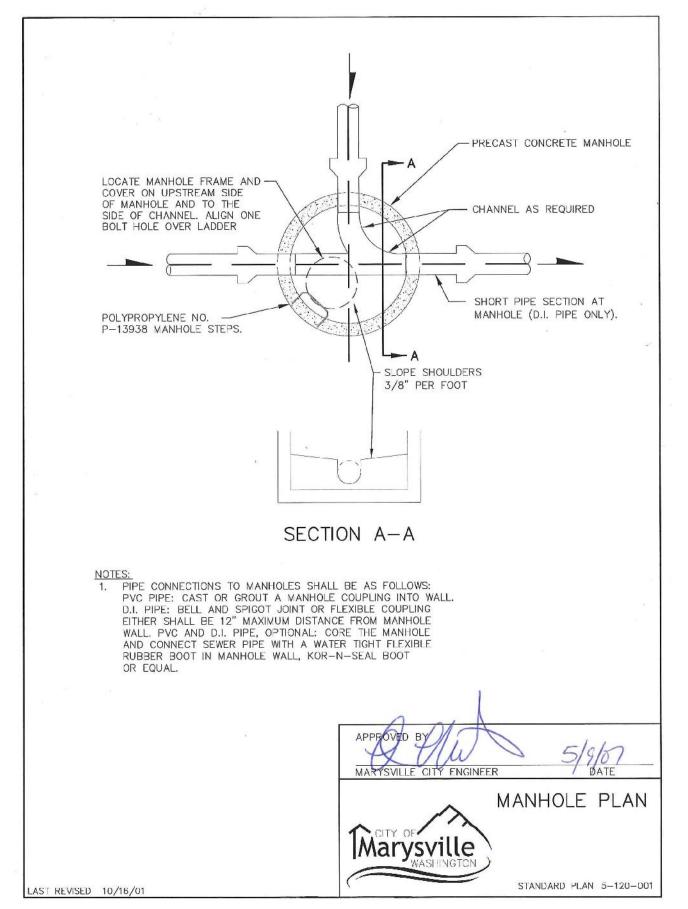


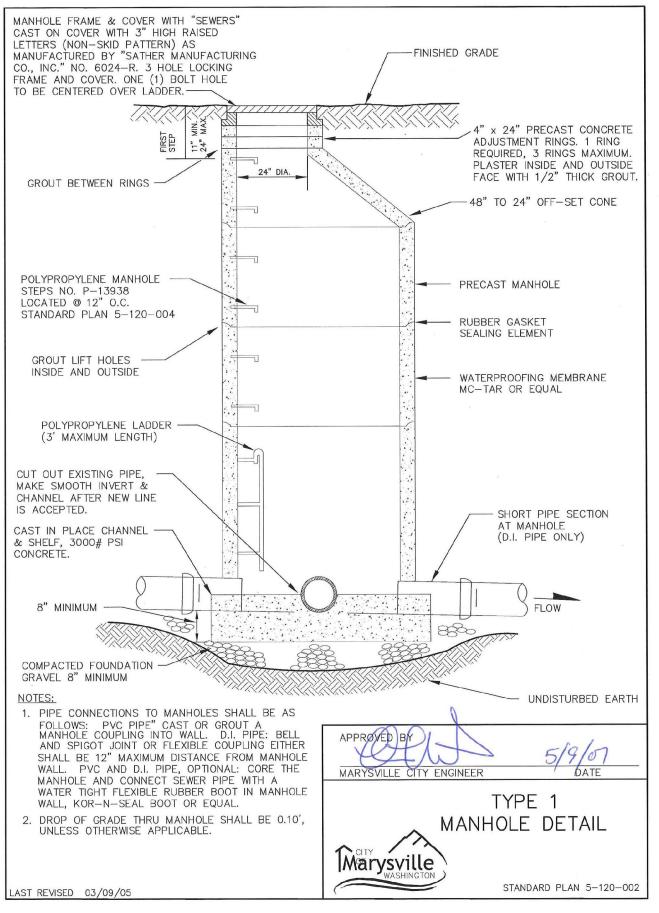

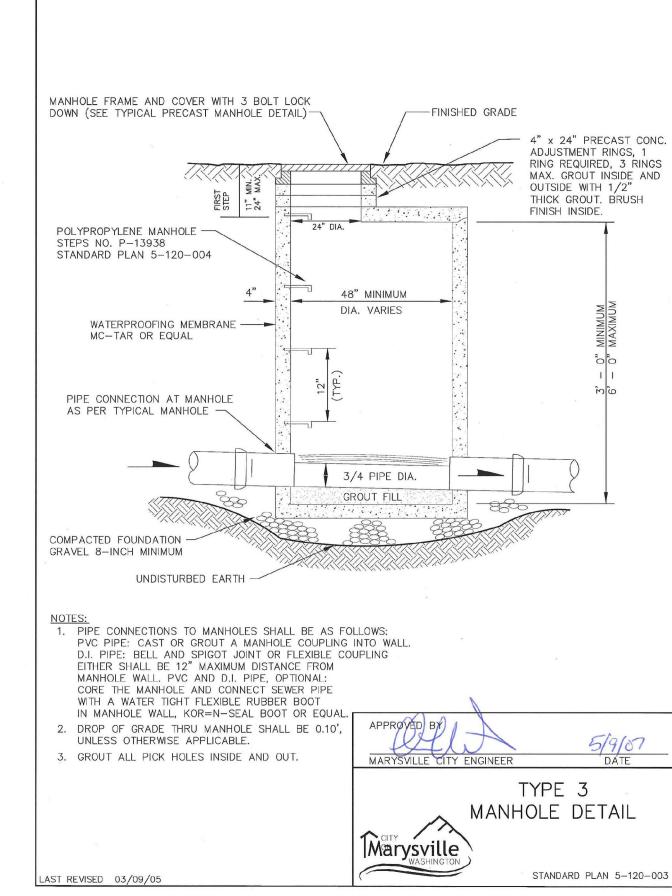

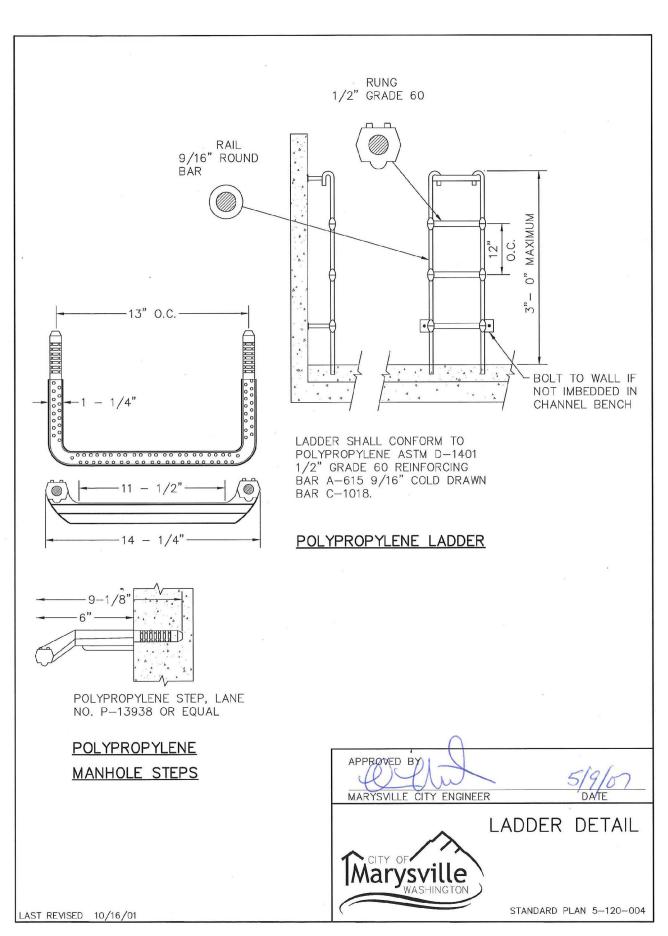

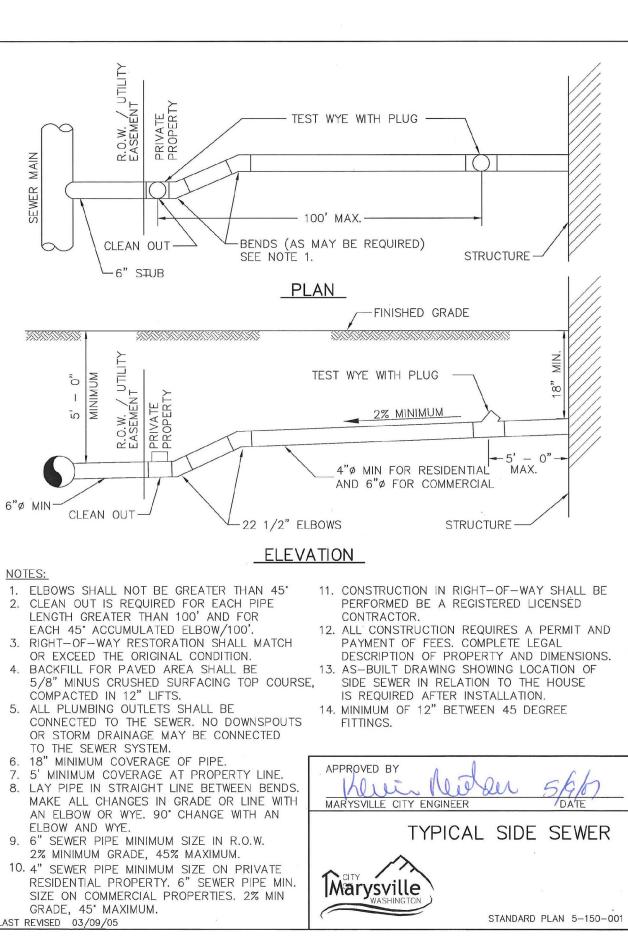

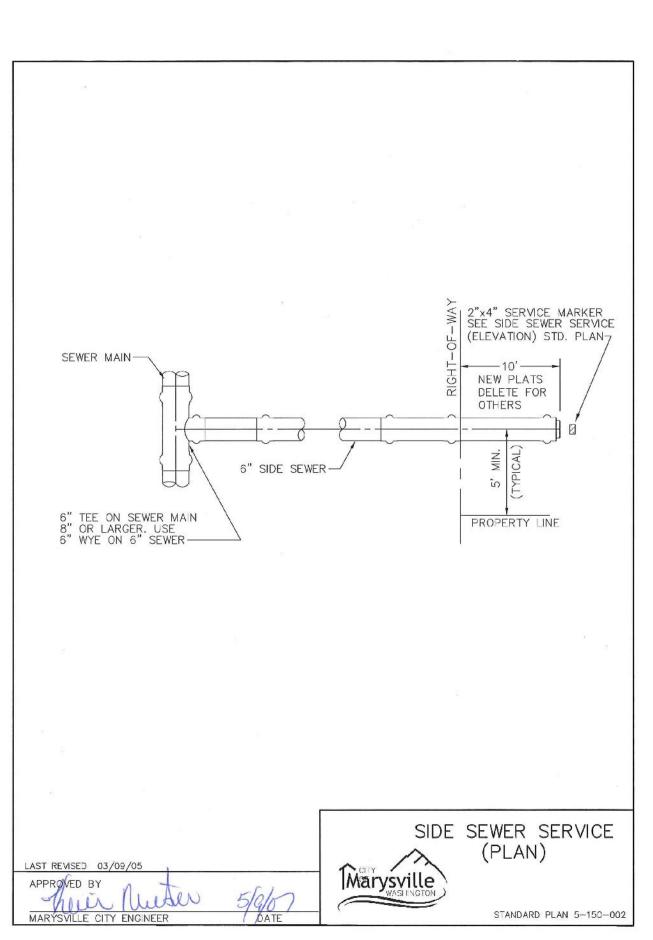

CITY PROJECT #: PA22-023

CITY OF MARYSVILLE CONSTRUCTION DRAWING REVIEW ACKNOWLEDGEMENT

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THIS DAY OF ________

KEN MCINTYRE, P.E., ASSISTANT CITY ENGINEER


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Surveying Fagineering Planning Woodinville Olympia Dodinville, WA 98072 Aww.LDCcop.com F 425,482,2893

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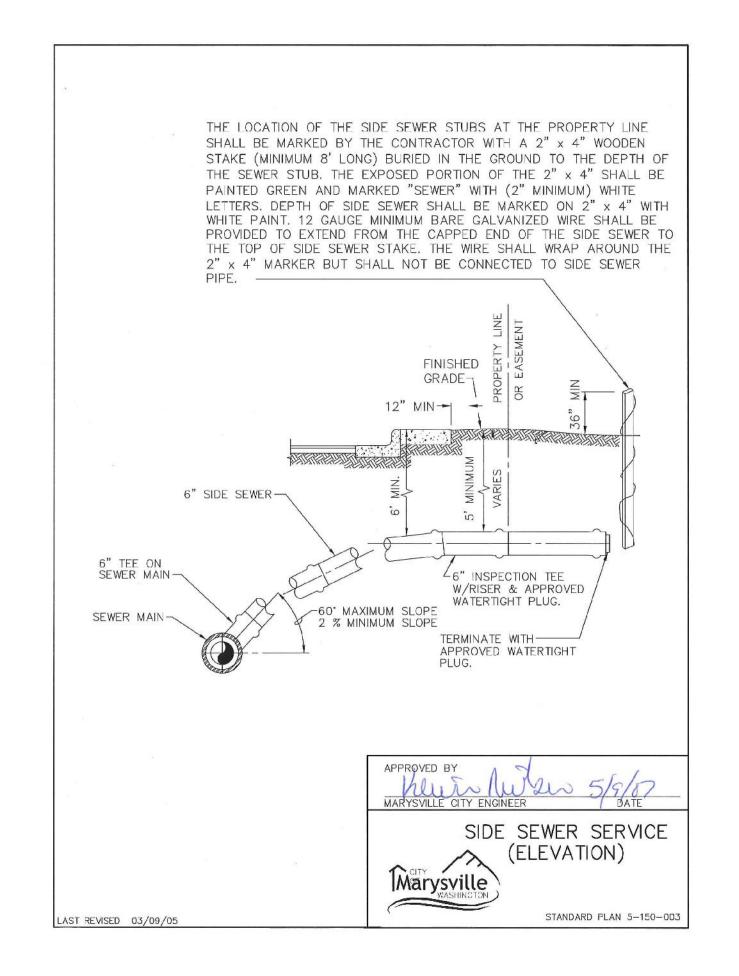
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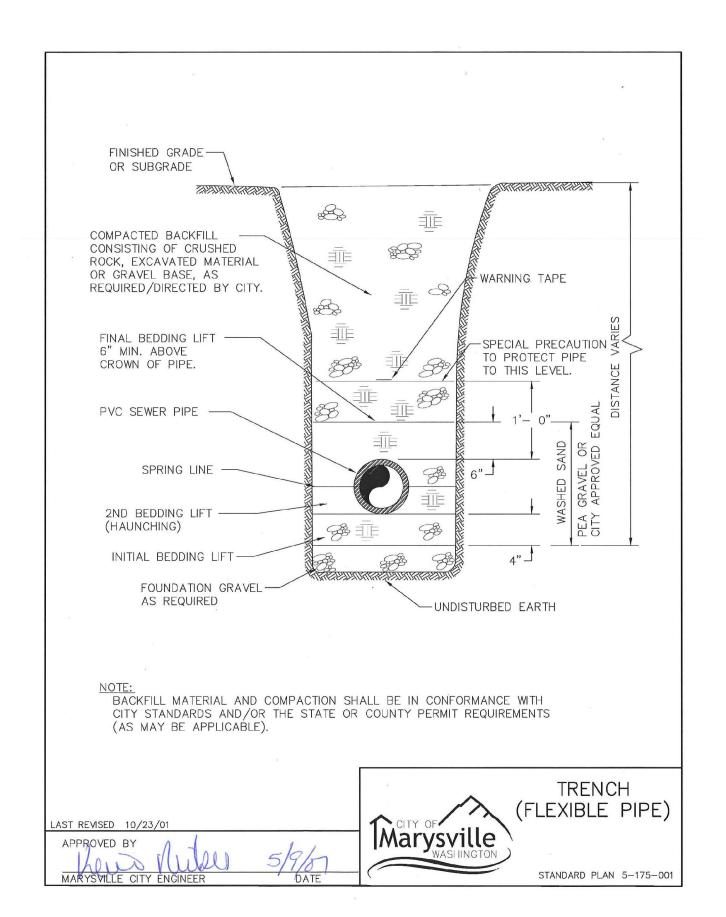
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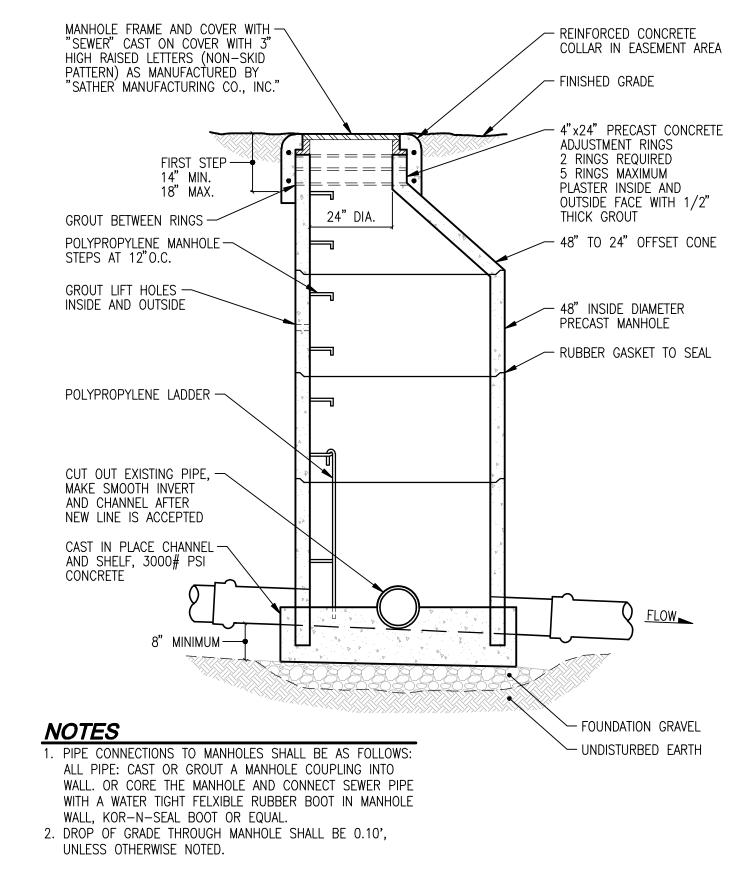


JOB NUMBER:	C22-17
DRAWING NAME:	C22177C-SS-D
DESIGNER:	TP.
DRAFTING BY:	DP
DATE:	11-15-2
SCALE:	AS NOTE
JURISDICTION:	MARYSVILL

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	DRAWING NAME:	C22177C-SS-DT
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	DRAFTING BY:	DPN
	DATE:	11-15-22
	SCALE:	AS NOTED

JURISDICTION: MARYSVILI

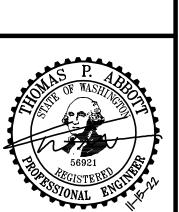
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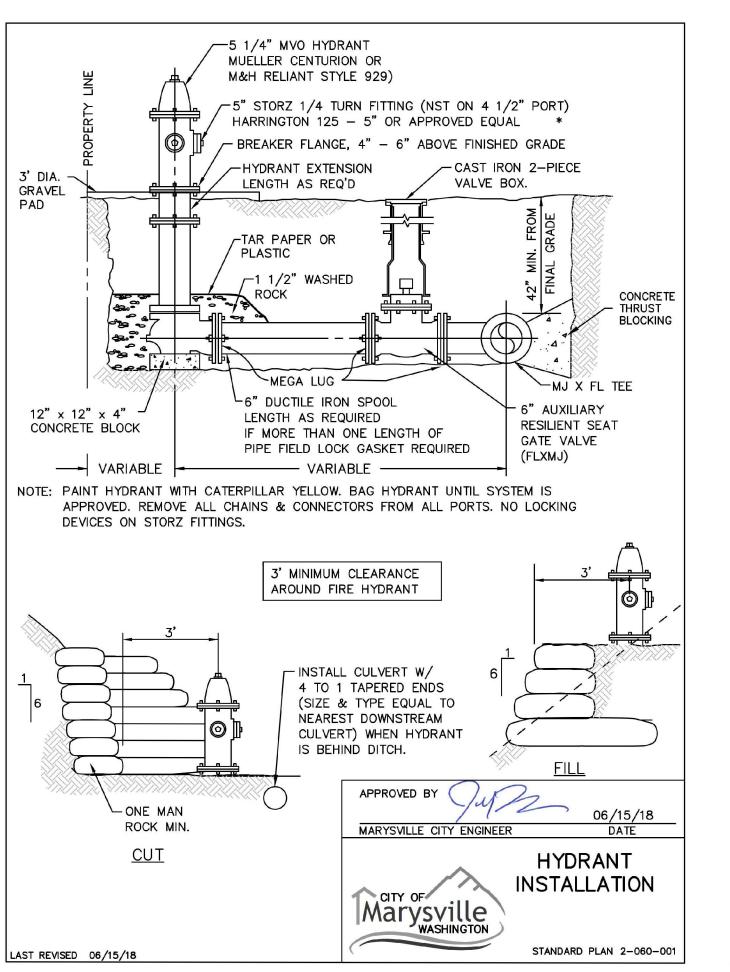
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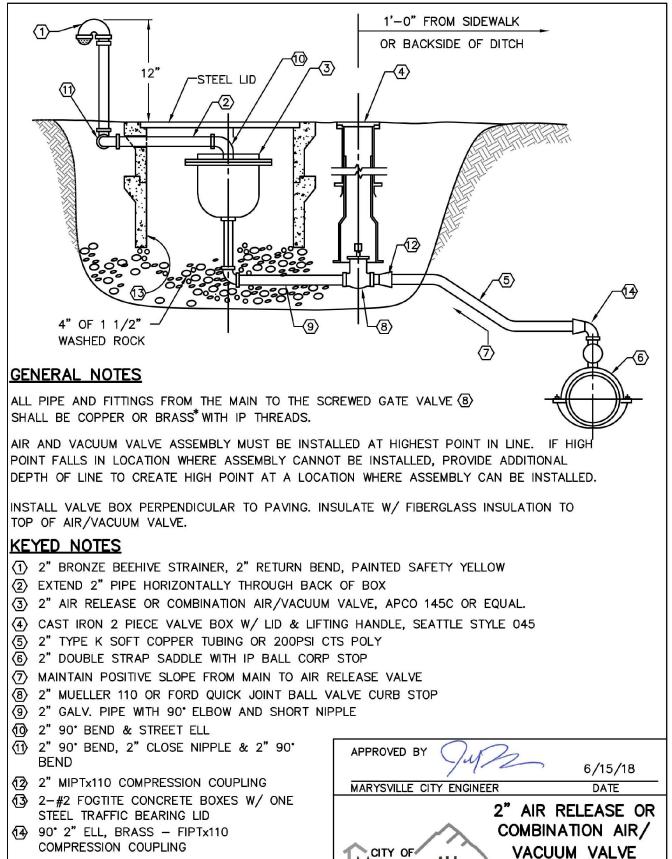
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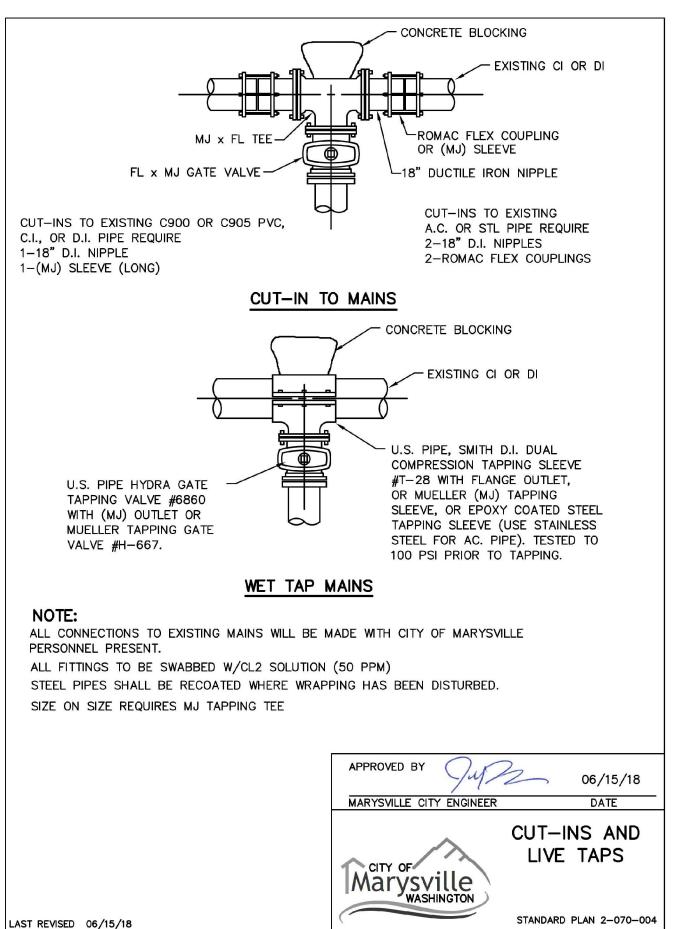








Marysville

LAST REVISED 06/15/18

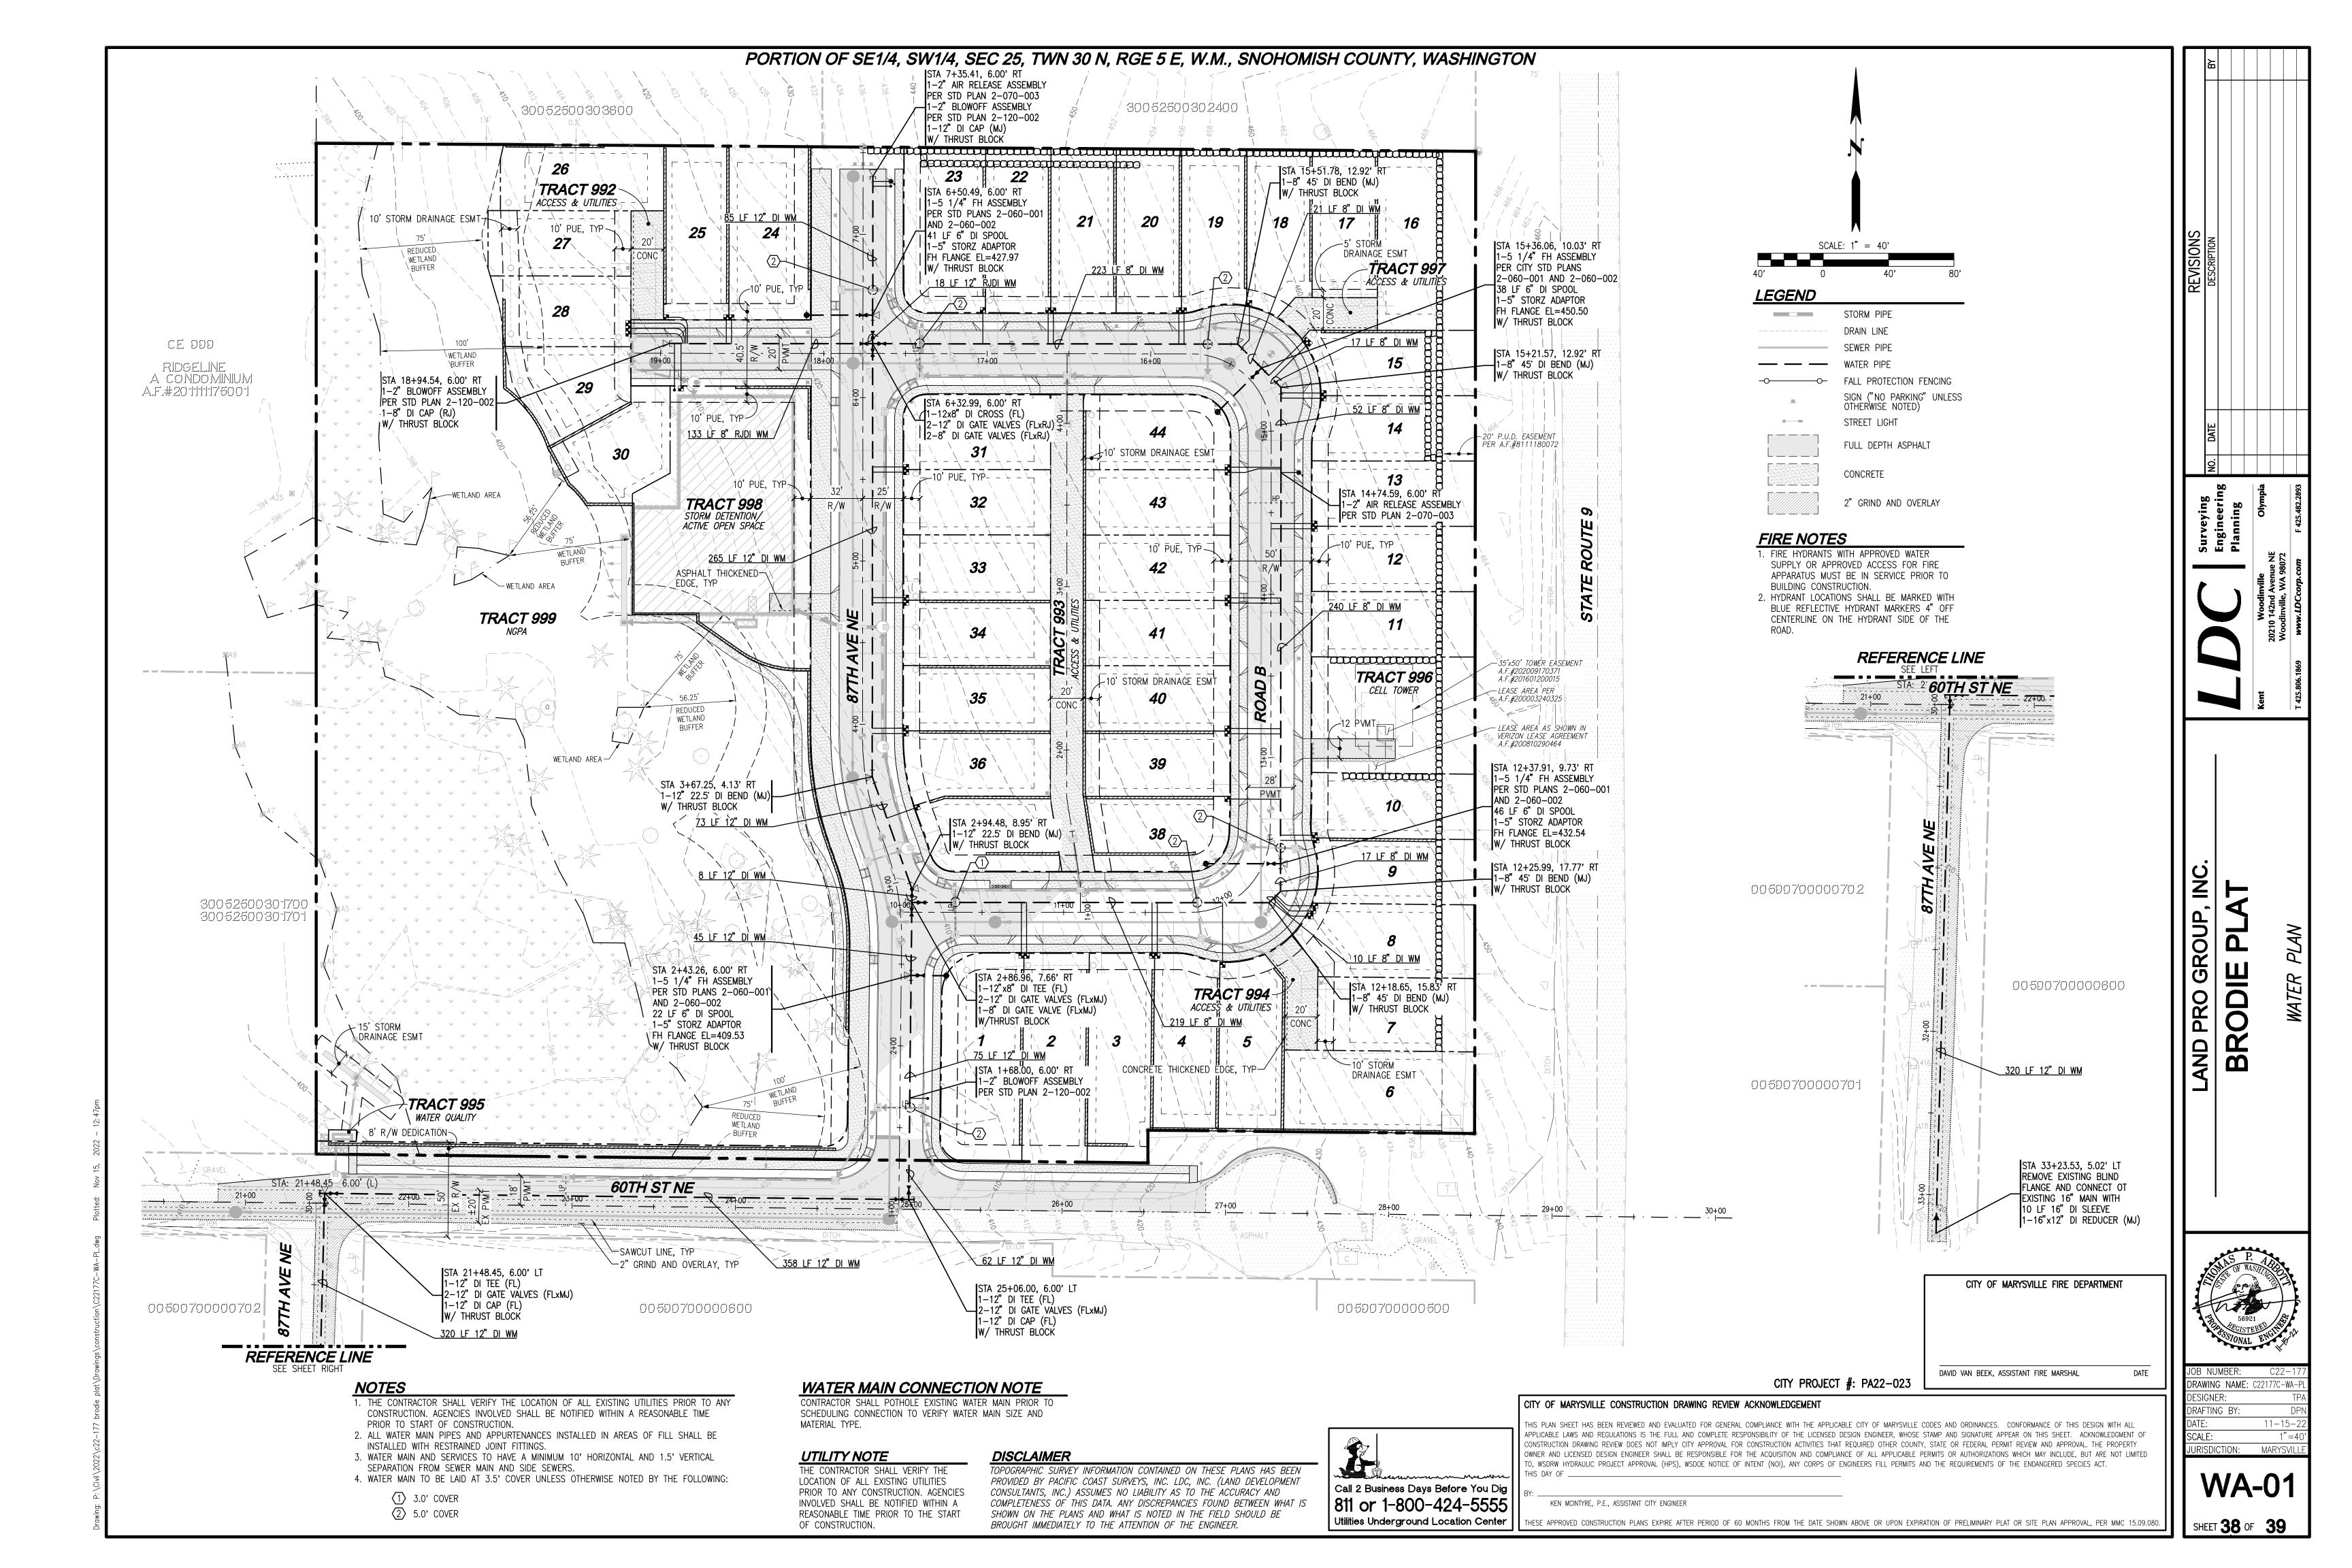

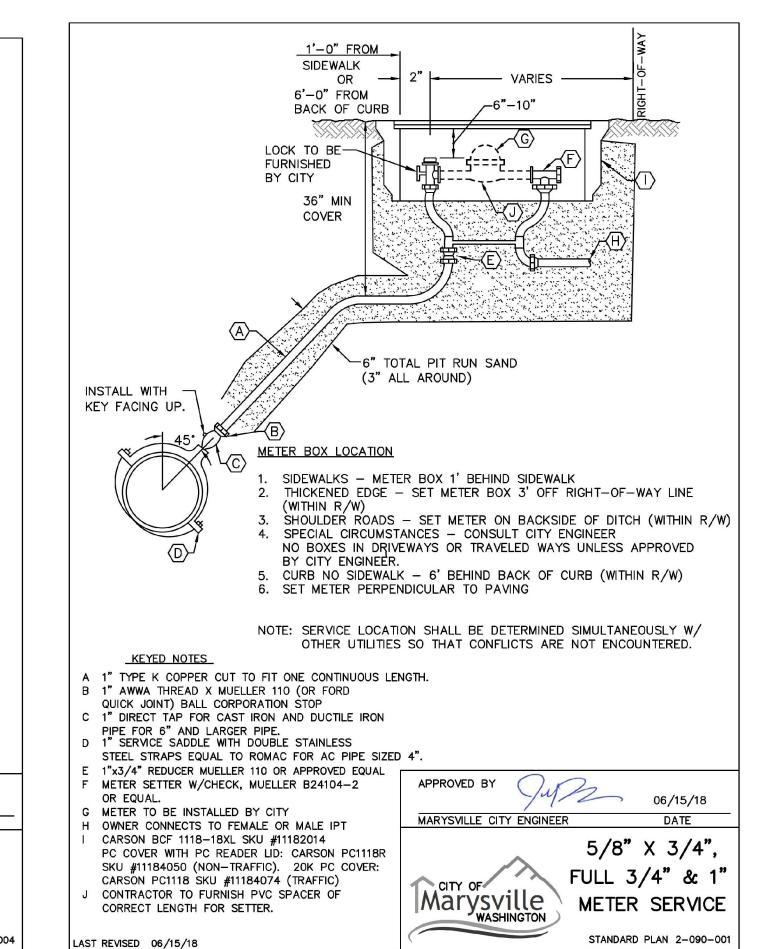

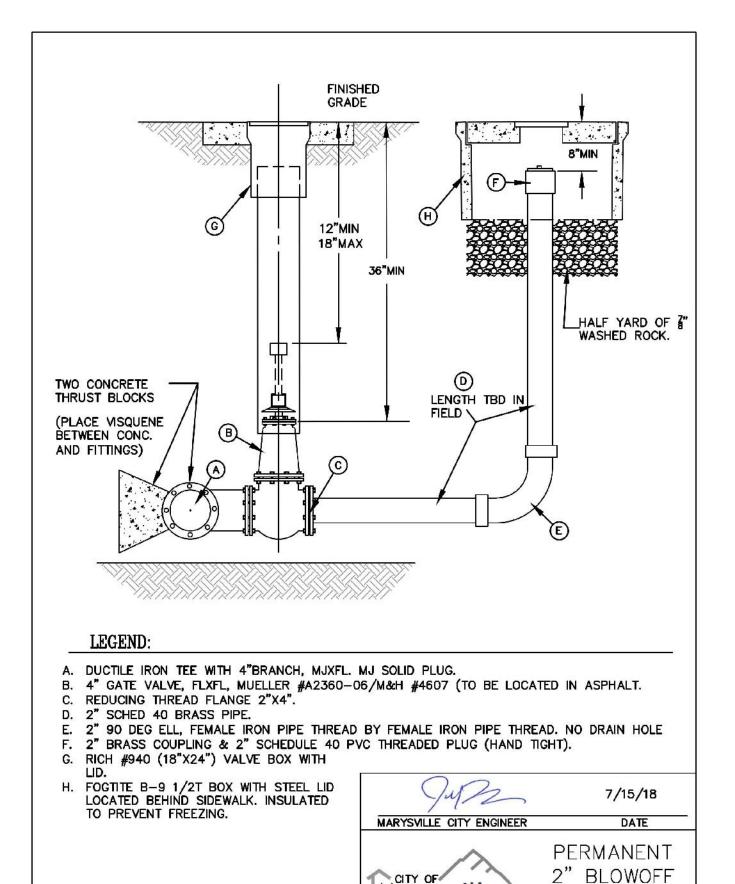



Marysville

LAST REVISED 6/1/18


ASSEMBLY

STANDARD PLAN 2-120-002

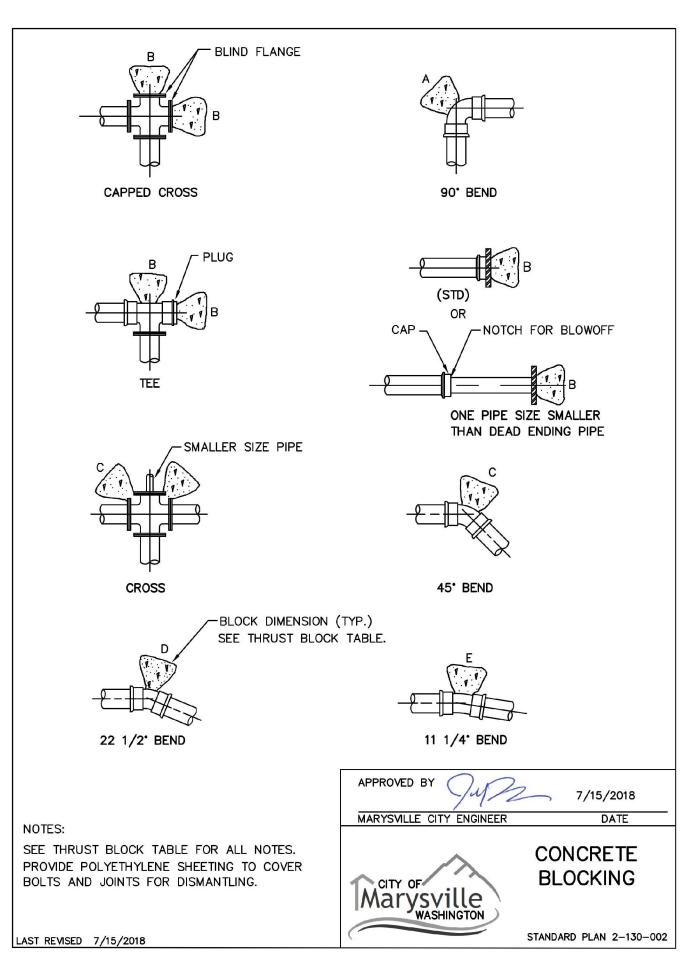

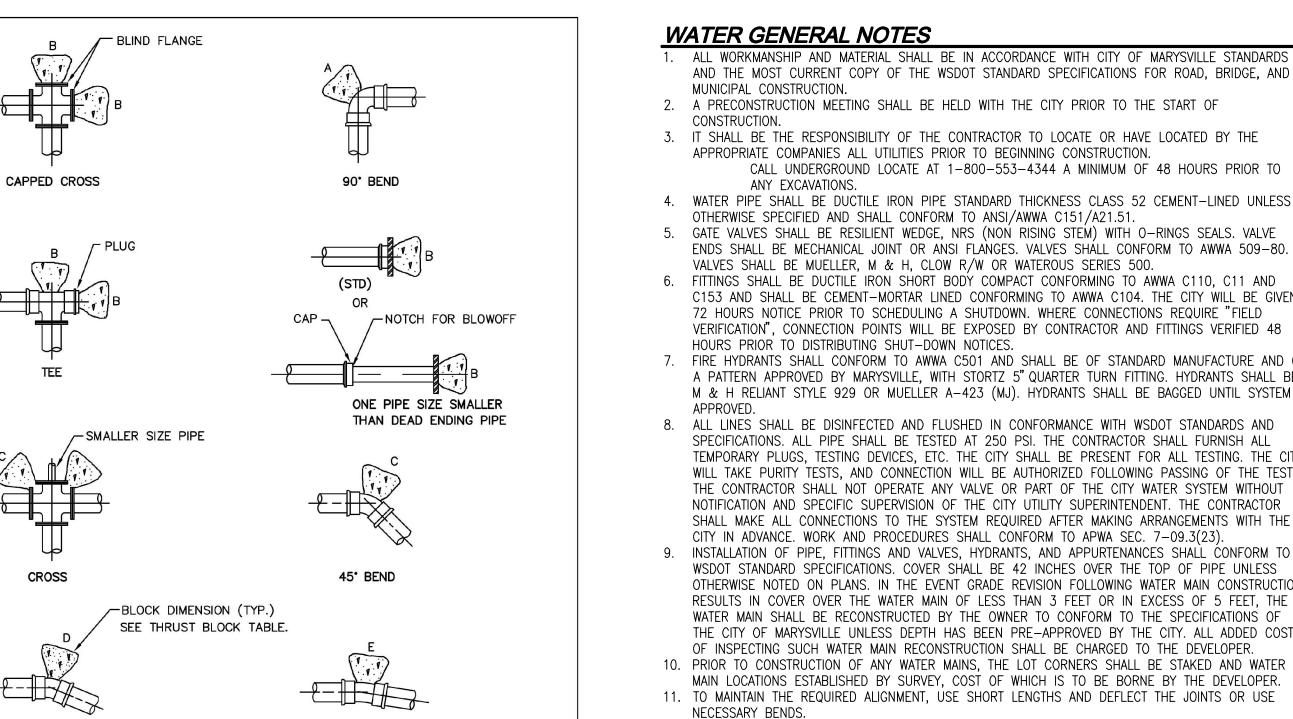

STANDARD PLAN 2-070-003

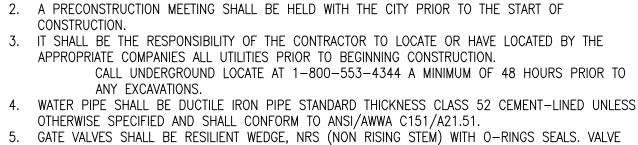


- 5. GATE VALVES SHALL BE RESILIENT WEDGE, NRS (NON RISING STEM) WITH O-RINGS SEALS. VALVE ENDS SHALL BE MECHANICAL JOINT OR ANSI FLANGES. VALVES SHALL CONFORM TO AWWA 509-80.
- 6. FITTINGS SHALL BE DUCTILE IRON SHORT BODY COMPACT CONFORMING TO AWWA C110, C11 AND C153 AND SHALL BE CEMENT-MORTAR LINED CONFORMING TO AWWA C104. THE CITY WILL BE GIVEN 72 HOURS NOTICE PRIOR TO SCHEDULING A SHUTDOWN. WHERE CONNECTIONS REQUIRE "FIELD VERIFICATION", CONNECTION POINTS WILL BE EXPOSED BY CONTRACTOR AND FITTINGS VERIFIED 48
- 7. FIRE HYDRANTS SHALL CONFORM TO AWWA C501 AND SHALL BE OF STANDARD MANUFACTURE AND OF A PATTERN APPROVED BY MARYSVILLE, WITH STORTZ 5" QUARTER TURN FITTING. HYDRANTS SHALL BE M & H RELIANT STYLE 929 OR MUELLER A-423 (MJ). HYDRANTS SHALL BE BAGGED UNTIL SYSTEM IS
- 8. ALL LINES SHALL BE DISINFECTED AND FLUSHED IN CONFORMANCE WITH WSDOT STANDARDS AND SPECIFICATIONS. ALL PIPE SHALL BE TESTED AT 250 PSI. THE CONTRACTOR SHALL FURNISH ALL TEMPORARY PLUGS, TESTING DEVICES, ETC. THE CITY SHALL BE PRESENT FOR ALL TESTING. THE CITY WILL TAKE PURITY TESTS, AND CONNECTION WILL BE AUTHORIZED FOLLOWING PASSING OF THE TESTS. THE CONTRACTOR SHALL NOT OPERATE ANY VALVE OR PART OF THE CITY WATER SYSTEM WITHOUT NOTIFICATION AND SPECIFIC SUPERVISION OF THE CITY UTILITY SUPERINTENDENT. THE CONTRACTOR SHALL MAKE ALL CONNECTIONS TO THE SYSTEM REQUIRED AFTER MAKING ARRANGEMENTS WITH THE
- 9. INSTALLATION OF PIPE, FITTINGS AND VALVES, HYDRANTS, AND APPURTENANCES SHALL CONFORM TO WSDOT STANDARD SPECIFICATIONS. COVER SHALL BE 42 INCHES OVER THE TOP OF PIPE UNLESS OTHERWISE NOTED ON PLANS. IN THE EVENT GRADE REVISION FOLLOWING WATER MAIN CONSTRUCTION RESULTS IN COVER OVER THE WATER MAIN OF LESS THAN 3 FEET OR IN EXCESS OF 5 FEET, THE WATER MAIN SHALL BE RECONSTRUCTED BY THE OWNER TO CONFORM TO THE SPECIFICATIONS OF THE CITY OF MARYSVILLE UNLESS DEPTH HAS BEEN PRE-APPROVED BY THE CITY. ALL ADDED COSTS
- 10. PRIOR TO CONSTRUCTION OF ANY WATER MAINS, THE LOT CORNERS SHALL BE STAKED AND WATER MAIN LOCATIONS ESTABLISHED BY SURVEY, COST OF WHICH IS TO BE BORNE BY THE DEVELOPER.
- 12. BEDDING MATERIAL MEETING THE REQUIREMENTS FOR RIGID PIPE SHALL BE PLACED TO A DEPTH OF 6" UNDER AND AROUND THE PIPE AND TO A DEPTH OF AT LEAST 12 INCHES OVER THE TOP OF THE THE BEDDING MATERIALS HALL BE RAMMED AND TAMPED AROUND THE PIPE BY THE USE OF SHOVELS OR OTHER APPROVED HAND-HELD TOOLS SO AS TO PROVIDE FIRM AND UNIFORM SUPPORT OVER THE FULL LENGTH OF ALL PIPE, VALVES, AND FITTINGS. CARE SHALL BE TAKEN TO PREVENT ANY DAMAGE TO THE PIPE OR ITS PROTECTIVE COATING.
- 13. SEPARATION OF WATER AND SEWER MAINS SHALL CONFORM TO W.D.O.E. STANDARDS OR SPECIAL CONSTRUCTION REQUIREMENTS.
- 14. SERVICES, BLOW-OFFS, AND MISCELLANEOUS DETAILS SHALL BE SHOWN ON THE DRAWINGS OR STANDARD PLANS.


CITY	PROJECT	#:	PA22-023

	CITY OF MARYSVILLE CONSTRUCTION DRAWING REVIEW ACKNOWLEDGEMENT
CITY OF MARYSVILLE FIRE DEPARTMENT	THIS PLAN SHEET HAS BEEN REVIEWED AND EVALUATED FOR GENERAL COMPLIANCE WITH THE APPLICABLE CITY OF MARYSVILLE CODES AND ORDINANCES. CONFORMANCE OF THIS DESIGN WITH ALL APPLICABLE LAWS AND REGULATIONS IS THE FULL AND COMPLETE RESPONSIBILITY OF THE LICENSED DESIGN ENGINEER, WHOSE STAMP AND SIGNATURE APPEAR ON THIS SHEET. ACKNOWLEDGMENT OF CONSTRUCTION DRAWING REVIEW DOES NOT IMPLY CITY APPROVAL FOR CONSTRUCTION ACTIVITIES THAT REQUIRED OTHER COUNTY, STATE OR FEDERAL PERMIT REVIEW AND APPROVAL. THE PROPERTY OWNER AND LICENSED DESIGN ENGINEER SHALL BE RESPONSIBLE FOR THE ACQUISITION AND COMPLIANCE OF ALL APPLICABLE PERMITS OR AUTHORIZATIONS WHICH MAY INCLUDE, BUT ARE NOT LIMITED TO, WSDRW HYDRAULIC PROJECT APPROVAL (HPS), WSDOE NOTICE OF INTENT (NOI), ANY CORPS OF ENGINEERS FILL PERMITS AND THE REQUIREMENTS OF THE ENDANGERED SPECIES ACT. THIS DAY OF
DAVID VAN BEEK, ASSISTANT FIRE MARSHAL DATE	THESE APPROVED CONSTRUCTION PLANS EXPIRE AFTER PERIOD OF 60 MONTHS FROM THE DATE SHOWN AROVE OR LIDON EXPIRATION OF PRELIMINARY PLAT OR SITE PLAN APPROVAL PER MMC 15.00

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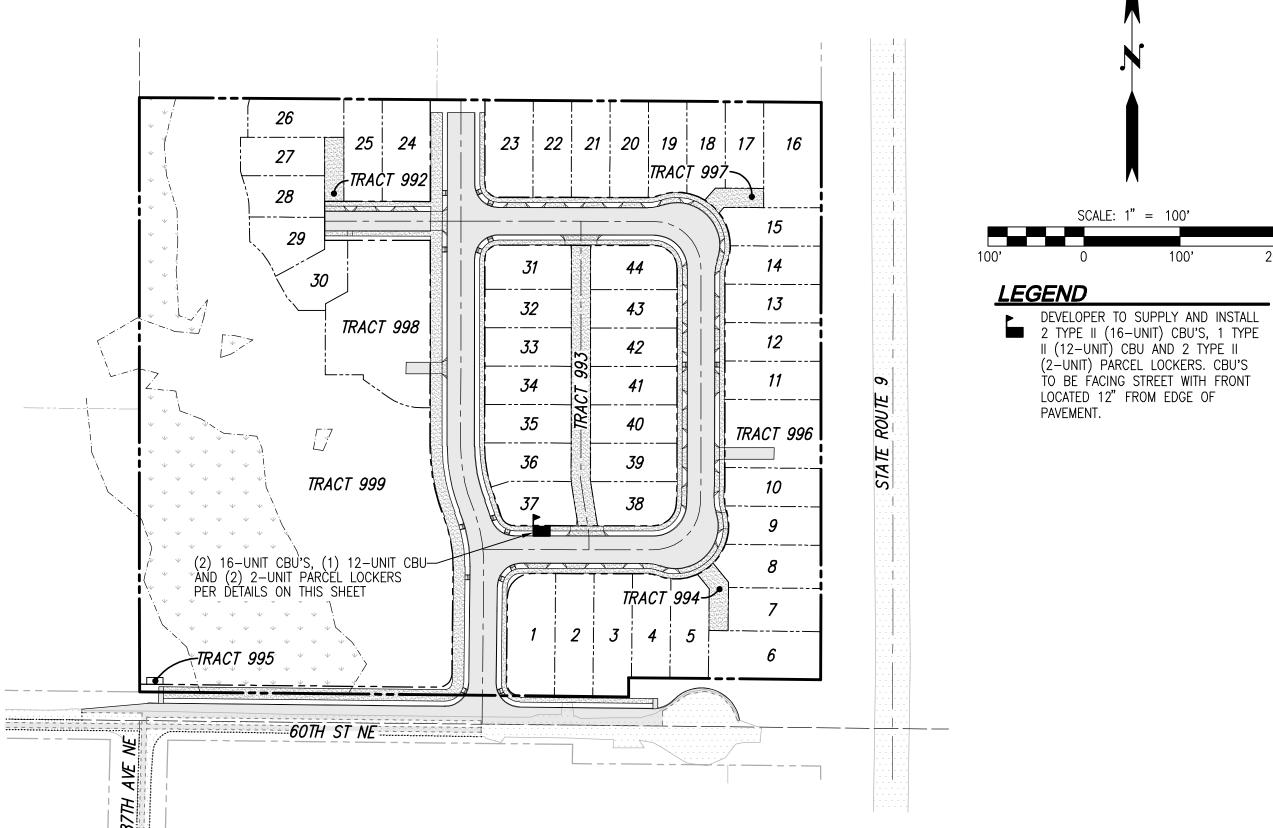


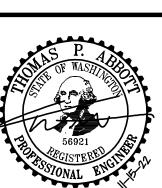
JOB NUMBER:	C22-17
DRAWING NAME:	C22177C-WA-D
DESIGNER:	TP
DRAFTING BY:	DP
DATE:	11-15-2
SCALE:	AS NOTE
JURISDICTION:	MARYSVILL

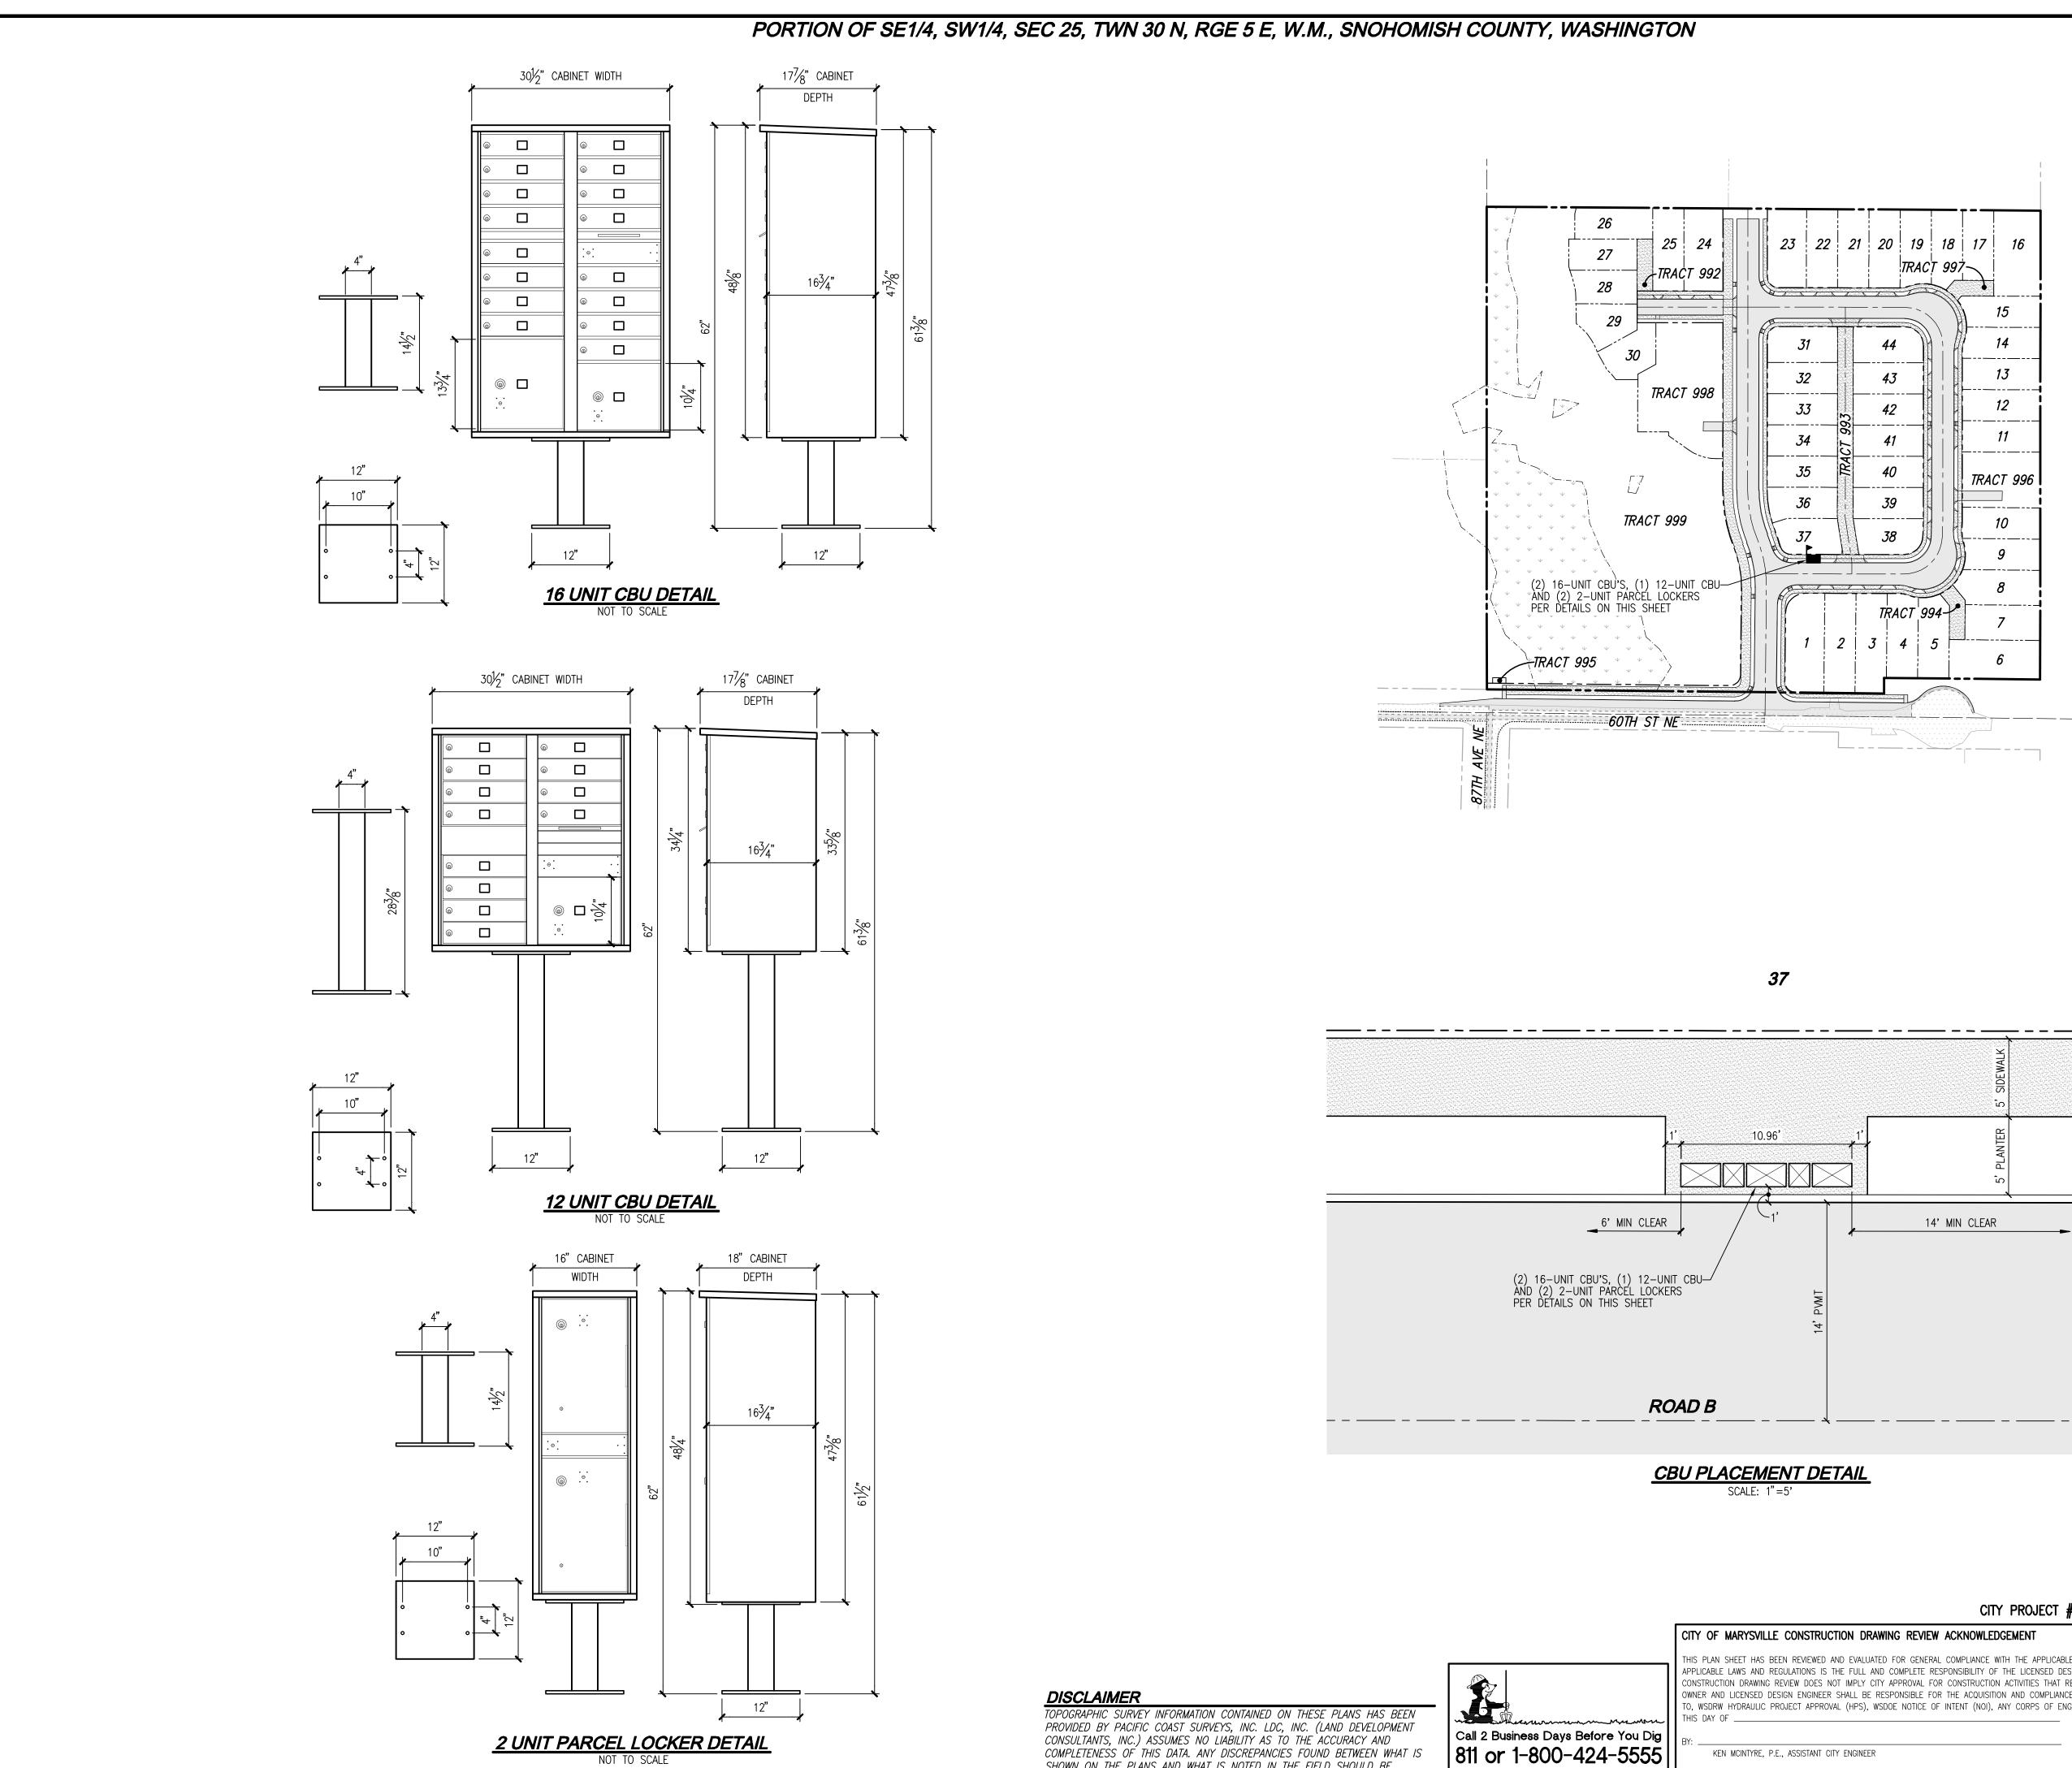

SHOWN ON THE PLANS AND WHAT IS NOTED IN THE FIELD SHOULD BE

BROUGHT IMMEDIATELY TO THE ATTENTION OF THE ENGINEER.



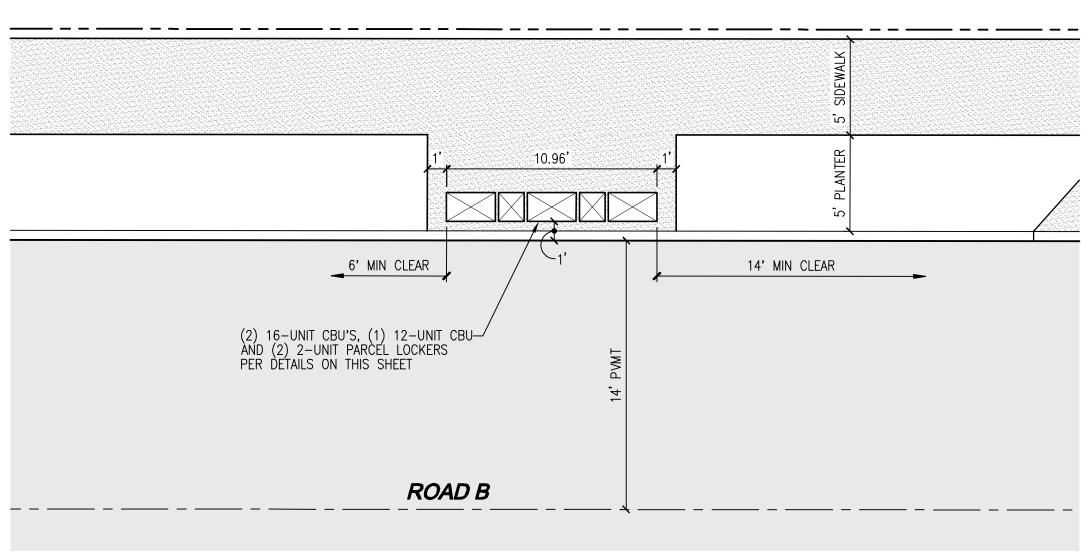

CITY PROJECT #: PA22-023

HIS PLAN SHEET HAS BEEN REVIEWED AND EVALUATED FOR GENERAL COMPLIANCE WITH THE APPLICABLE CITY OF MARYSVILLE CODES AND ORDINANCES. CONFORMANCE OF THIS DESIGN WITH ALL CONSTRUCTION DRAWING REVIEW DOES NOT IMPLY CITY APPROVAL FOR CONSTRUCTION ACTIVITIES THAT REQUIRED OTHER COUNTY, STATE OR FEDERAL PERMIT REVIEW AND APPROVAL. THE PROPERTY OWNER AND LICENSED DESIGN ENGINEER SHALL BE RESPONSIBLE FOR THE ACQUISITION AND COMPLIANCE OF ALL APPLICABLE PERMITS OR AUTHORIZATIONS WHICH MAY INCLUDE, BUT ARE NOT LIMITED TO, WSDRW HYDRAULIC PROJECT APPROVAL (HPS), WSDOE NOTICE OF INTENT (NOI), ANY CORPS OF ENGINEERS FILL PERMITS AND THE REQUIREMENTS OF THE ENDANGERED SPECIES ACT.

KEN MCINTYRE, P.E., ASSISTANT CITY ENGINEER

Utilities Underground Location Center

THESE APPROVED CONSTRUCTION PLANS EXPIRE AFTER PERIOD OF 60 MONTHS FROM THE DATE SHOWN ABOVE OR UPON EXPIRATION OF PRELIMINARY PLAT OR SITE PLAN APPROVAL, PER MMC 15.09.080.

LAND PRO GROUP,

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DRAWING NAME:	C22177C-MB-PL
DESIGNER:	TPA
DRAFTING BY:	DPN
DATE:	11-15-22
SCALE:	1"=100'
JURISDICTION:	MARYSVILLE

MB-01