
GENERAL NOTES

1. CONTRACTOR SHALL PROVIDE AND COORDINATE PLACEMENT, SIZE AND LOCATION OF ALL UNDERGROUND SLEEYE.

- 2. ALL DIMENSIONS TO CURBS ARE TO FACE OF CURB, UNLESS NOTED OTHERWISE.
- 3. ALL DIMENSIONS TO BUILDING ARE PERPENDICULAR TO PROPERTY LINES UNLESS NOTED OTHERWISE.
- 4. YERIFY ALL LOCATIONS OF PROPERTY LINES, UTILITY LINES AND EXISTING STRUCTURES.
- 5. SEE GEOTECH REPORT FOR SUITABILITY OF EXCAVATED MATERIAL FOR FILL.
- 6. REPAIR ANY DAMAGE CAUSED BY CONSTRUCTION ACTIVITIES TO EXISTING SURFACES AND STRUCTURES PROVIDE APPROPRIATE TRANSITIONS BETWEEN NEW CONSTRUCTION AND EXISTING CONDITIONS. EXTEND CONCRETE OR ASPHALT REPLACEMENT TO A UNIFORM TRANSITION OR THE NEAREST EXISTING JOINT.



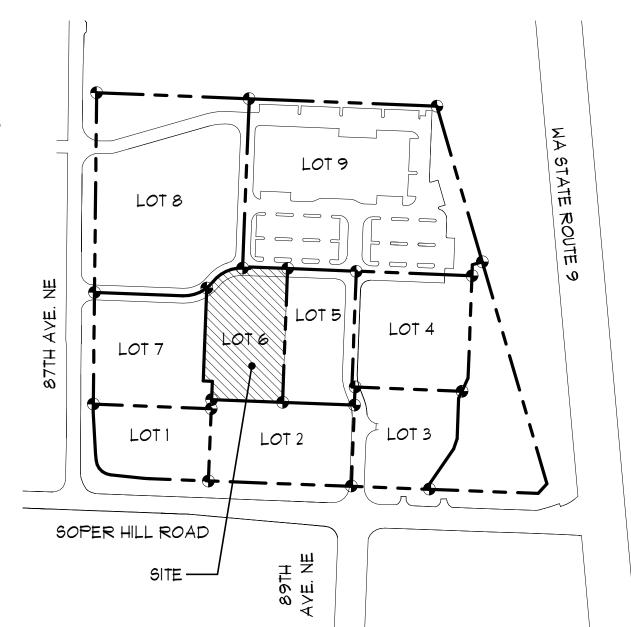

SITE DESIGN CRITERIA

PROJECT ADDRESS: 8833 SOPER HILL RD

> MARYSVILLE, WASHINGTON 9827Ø

DOUGLAS BRAJCICH OWNER:

18216 NE 146TH WAY WOODINVILLE, WASHINGTON

98Ø72

CB-WR

9,989 S.F.

24,443 S.F.

34,432 S.F.

10,213 S.F.

47 SPACES

BASE = 50 SPACES

REDUCTION = 3 SPACES

PARKING BY I SPACE

3 SPACES (5% OF REQ.

PARKING SPACES)

IOTAL REQ. = 47 SPACES

(45 SPACES + 2 ADA SPACES)

SPACES TO REDUCE YEHICLE

18 SPACES (3 REQ. SPACES +

2% OF APPLICABLE SITE & 1%

OF BUILDING FLOOR AREA

39, 532 S.F. x 2% = 791 S.F.

PROVIDE ADDITIONAL 5 BICYCLE

ASSESSOR'S PARCEL NO. 00590700031800

JURISDICTION: CITY OF MARYSVILLE

ZONING:

PROPOSED USE: BUSINESS

MAXIMUM BUILDING HEIGHT:

2Ø' BUILDING HEIGHT:

SETBACKS:

STREET: Ø FEET

Ø FEET INTERIOR:

44,645 SF SITE AREA:

MAXIMUM LOT COVERAGE! ∕ 85%√ 77.1%

IMPERVIOUS SURFACE AREA:

BUILDINGS:

PARKING/PAYED AREA: TOTAL IMPERVIOUS

SURFACE AREA:

LANDSCAPE AREA:

PARKING REQUIRED:

PARKING PROVIDER:

PARKING REDUCTION:

BICYCLE SPACES REQUIRED:

BICYCLE SPACES PROVIDER:

15 ADD. SPACES FOR PARKING (REDUCTION)


OPEN SPACE REQUIRED

APPLICABLE SITE:

BUILDING FLOOR AREA: TOTAL REQUIRED:


OPEN SPACE PROVIDED:


9,989 S.F. x 1% = 100 S.F. 891 S.F. 94Ø S.F.

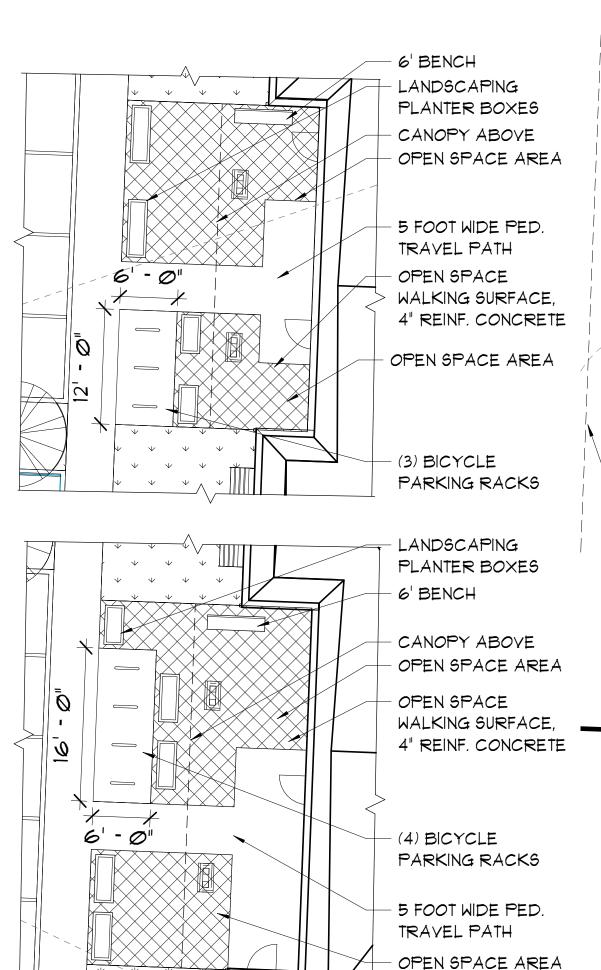





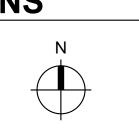

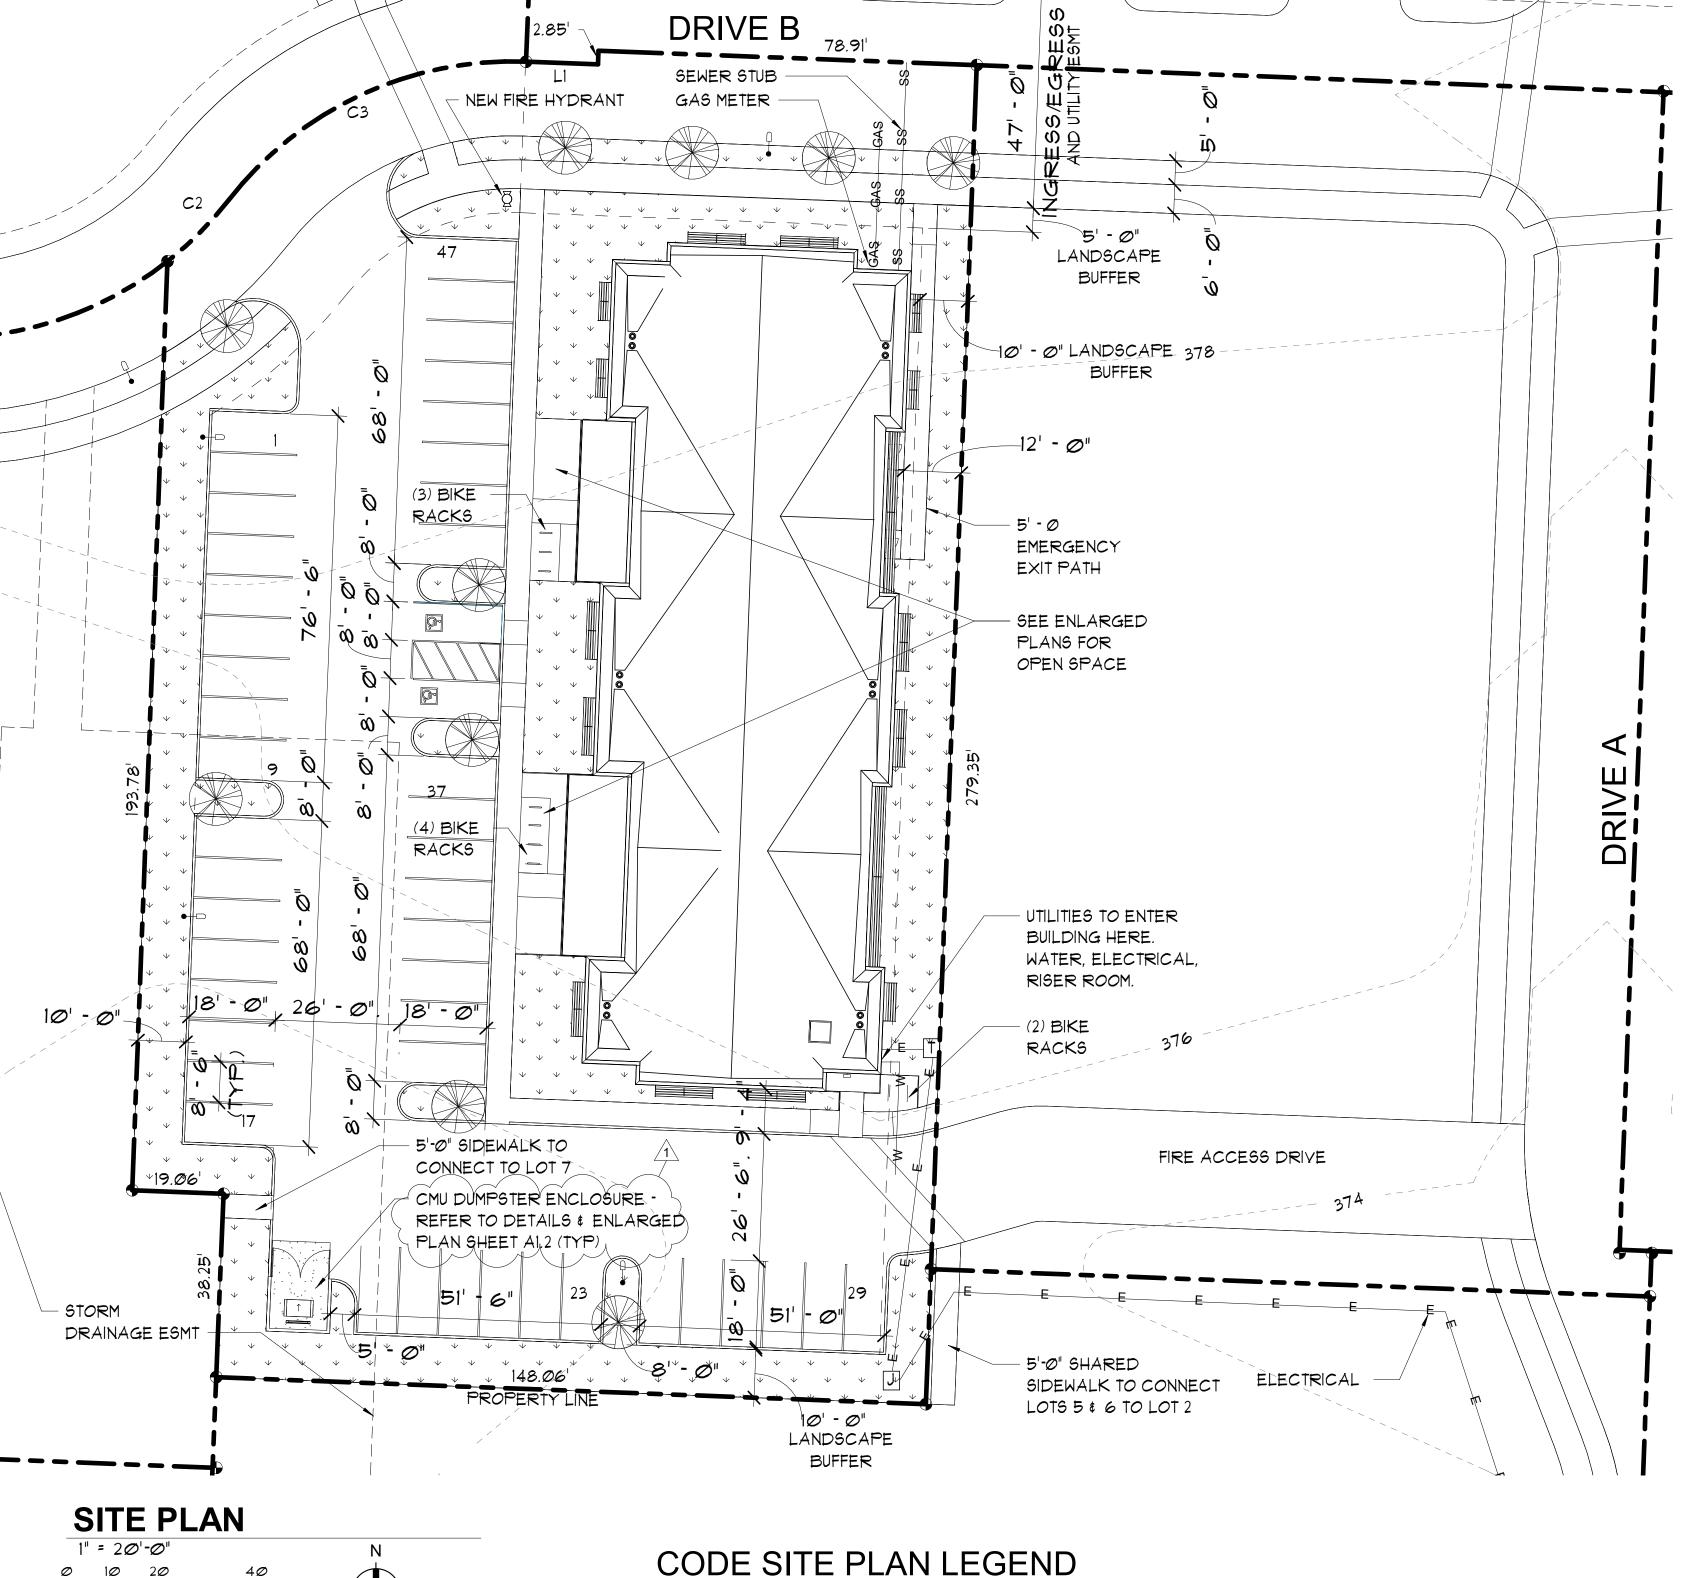

CODE SITE PLAN LEGEND

- - - PROPERTY LINE ---- SETBACK OR EASEMENT CONTOUR - NEW CONTOUR - EXISTING PROJECT LIMITS CONTRACTOR STAGING AREA LANDSCAPED AREA LANDSCAPING BUFFER AREA CONCRETE GRAYEL ASPHALT PAYEMENT

HYDRANT

FIRE DEPARTMENT CONNECTION (FDC)

POST INDICATOR VALVE (PIV)

SINGLE POST MOUNTED LIGHTING FIXTURE DOUBLE POST MOUNTED LIGHTING FIXTURE

WATER METER

T ELECTRICAL TRANSFORMER

MARYSVIL DENTAI

REVISIONS

1 City Comments 2022-08-15

NEAL ASSOCIATES

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P.O. BOX 1945

WENATCHEE, WA 98807


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STATE OF WASHINGTON


REGISTERED

ARCHITECT


2022-07-18 Scale Factor: Drawn: NM/HE 2Ø479

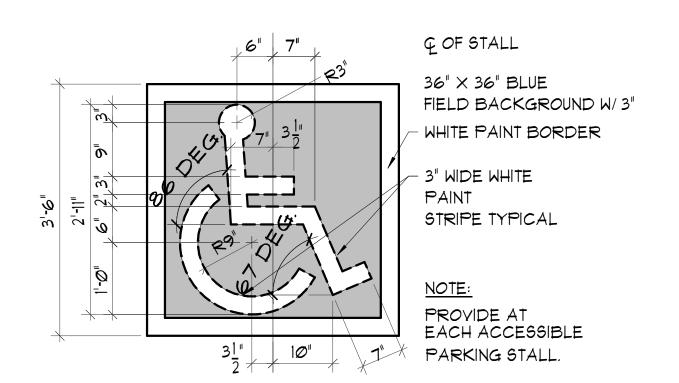


INTERN'L SYMBOL OF ACCESSIBILITY

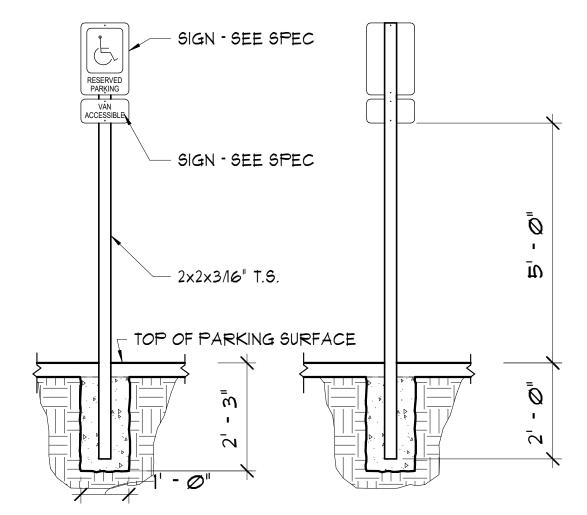


ACCESSIBLE SIGNAGE 1/2" = 1'-Ø"

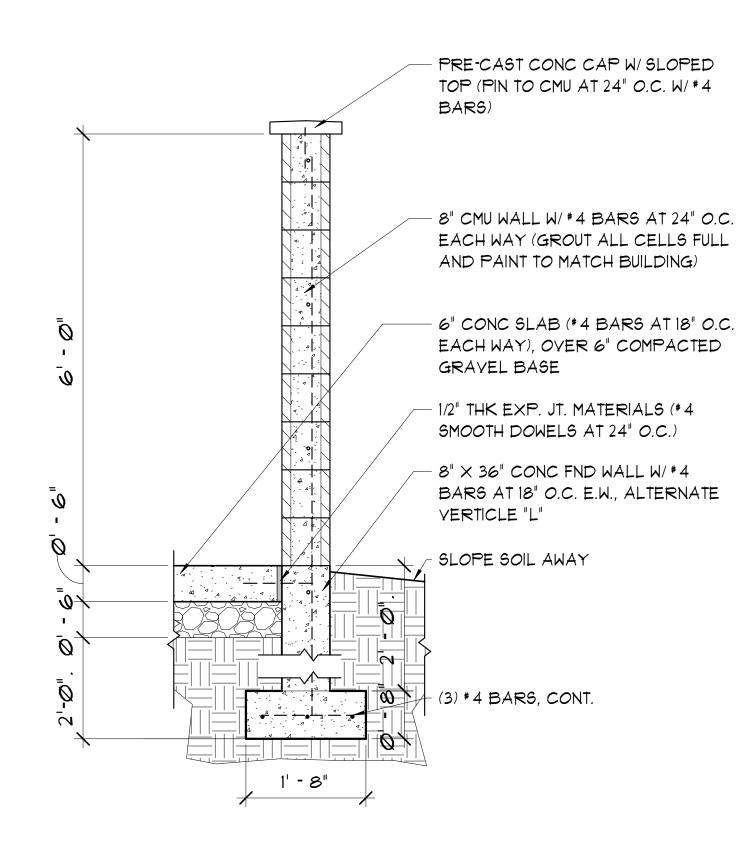

DUMPSTER ENCLOSURE

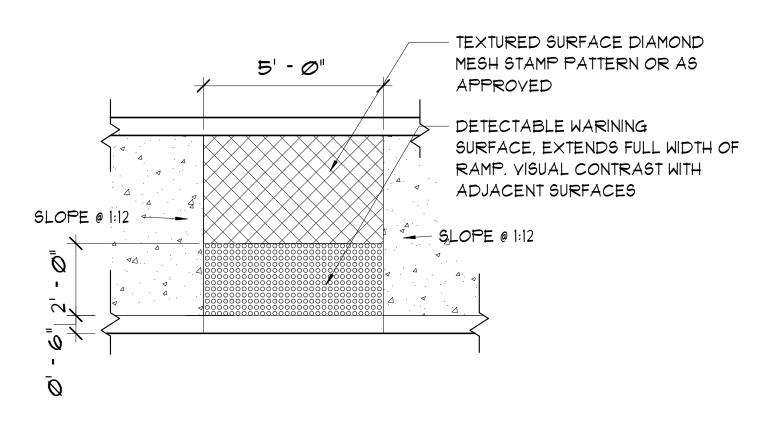



2 CURB RAMP LANDING 3/8" = 1'-Ø"

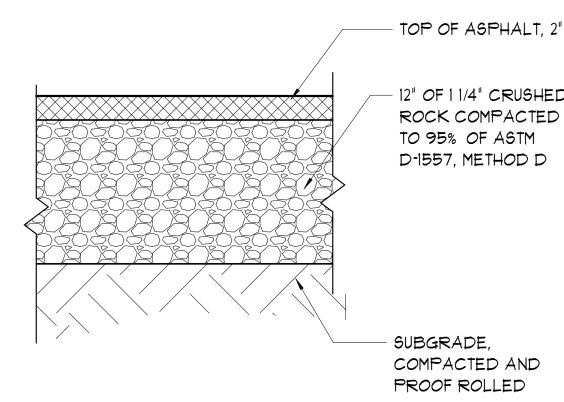

6 ASPHALT DETAIL

1 1/2" = 1'-0"

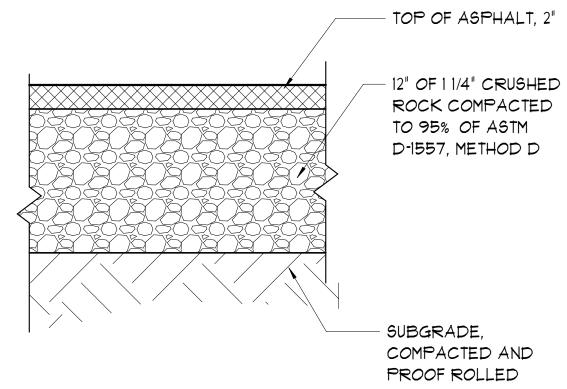

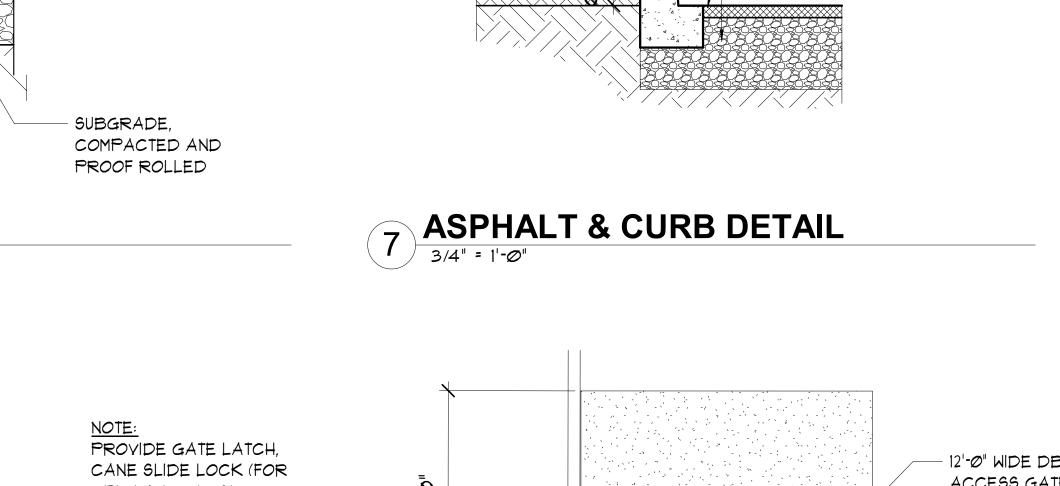

4" CONCRETE WALK W/ BROOM FINISH

SPACING CONTROL JOINTS @ 5'-0" O.C.

FINISH GRADE

BROOM FINISH

PERPENDICULAR

4" CONCRETE WALK, LIGHT

TO DIRECTION OF TRAVEL

TOOL EDGE

1/2" FIBER EXPANSION JOINT,

FULL DEPTH @ 15'-0" O.C. MAX

— 6 x 6 1.4/1.4 W. W. F. -TYPICAL

LANDSCAPE TOP SOIL

PER PLAN


CONCRETE CURB

TOP OF ASPHALT

ASSEMBLY PER 6/A1.2

3A EXTERIOR CONSTRUCTION JOINT

3 WALK ÉDGE & PLANTER LAWN

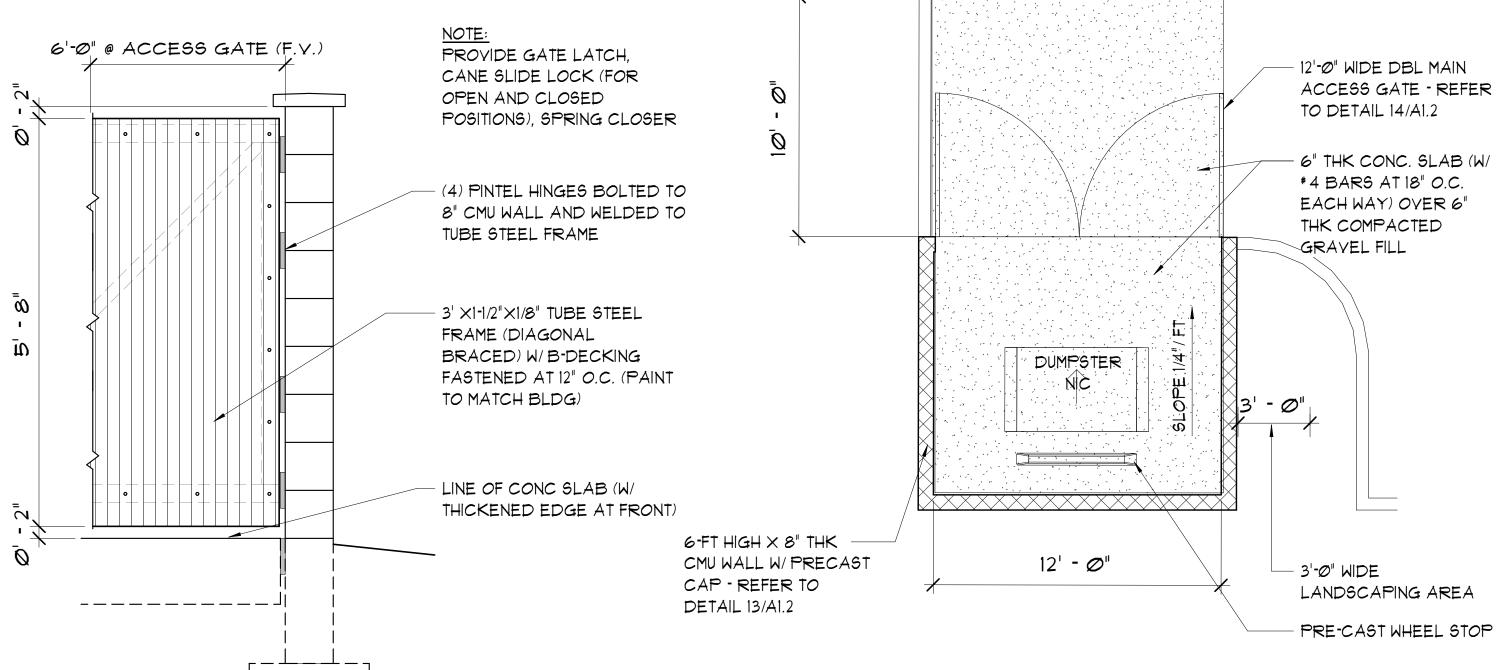

14 DUMPSTER GATE ELEVATION

3/4" = 1'-0"

15 ENLARGED PLAN ENCLOSURE

REVISIONS FIXTURE POLE HANDHOLE BASE COVER 1 • • • • ANCHOR BOLTS - SIZE = #4 CONDUIT 24" BELOW GRADE 5' - Ø" MIN. 24" MIN. CONC. BASE, TOP 1" ABOYE SOIL & SLOPE TO EDGE - #3 TIES @ 12" O.C. (MIN. 3" COVER) (4) *5 REBAR

4 POLE BASE DETAIL - 20'-0" MAX.



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REGISTERED ARCHITECT STATE OF WASHINGTON

Date:	2022-07-18
Scale Factor:	1
Drawn:	NM/HE
File:	20479
Sheet	