# **GEDDES MARINA PHASE 2 REMEDIATION**



## MARYSVILLE, WASHINGTON

## PROJECT CONTACTS

OWNER/APPLICANT

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LOCATION
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SNOHOMISH COUNTY, WASHINGTON

CITY OFFICIALS KAMILLE NORTON JEFFREY D. VAUGHN MARK A. JAMES TOM KING

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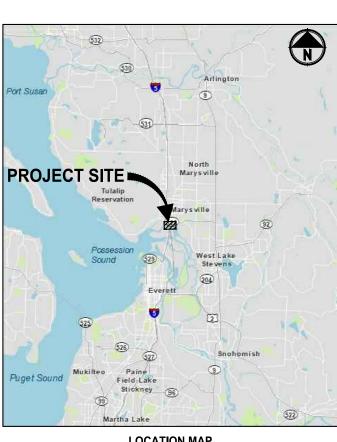
COUNCIL MEMBER
COUNCIL MEMBER
COUNCIL MEMBER
COUNCIL MEMBER

JOHN NEHRING GLORIA HIRASHIMA ESCO BELL, PE JEFF LAYCOCK, PE

CHIEF ADMINISTRATIVE OFFICER
PUBLIC WORKS DIRECTOR
CITY ENGINEER

COUNCIL PRESIDENT

COUNCIL MEMBER



NOT TO SCALE



NOT TO SCALE

### **INDEX TO DRAWINGS**

SHEET NO.	DWG NO.	SHEET TITLE
1	G1	TITLE SHEET, VICINITY MAP, AND SHEET INDEX
2	G2	NOTES, LEGEND AND ABBREVIATIONS
3	G3	PARCEL MAP
4	C1	SITE PLAN
5	C2	GRADING KEY AND ALIGNMENTS
6	C3	GRADING PLAN NORTH
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8	C5	CHANNEL PROFILES
9	C6	SECTIONS AND STORMWATER PROFILE
10	C7	DETAILS
11	LS1	LANDSCAPE RESTORATION PLAN AND DETAILS

PERMIT SUBMITTAL DRAWINGS

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					APPROVED	ı

ONE INCH AT FULL SCALE, IF NOT, SCALE ACCORDINGLY PILE NAME PS2967005-G1-2

JOB No.
553-2967-005

DATE DECEMBER 2021





CITY OF MARYSVILLE
GEDDES MARINA PHASE 2
REMEDIATION
MARYSVILLE, WA

TITLE SHEET, VICINITY MAP, AND SHEET INDEX DRAWING NO. 1 OF 11

G1

## LEGEND: DESCRIPTION HUB & TACK SET MAG NAIL PROPERTY BOUNDARY

STREAM **→** · · · · **→** · · · · **→** · · · · DERBY CREEK BUFFER SAMMAMISH RIVER BUFFER

OHWL -

\_\_\_\_cg\_\_\_cg\_\_\_cg\_\_\_cg\_\_\_

----F----F----F-

----c---c---c-

PROPOSED

**EXISTING** 

⊡

WETLAND SYMBOL 2011/4 2011/4 WETLAND BOUNDARY WETLAND A BUFFER

DITCH TEMPORARY BYPASS PIPE

ORDINARY HIGH WATER LINE

STORM DRAIN MANHOLE UNDERGROUND GRAVITY PIPING

STORM DRAIN

UNDERGROUND FORCE MAIN

CATCH BASIN, TYPE 1 SANITARY SEWER LINE SANITARY SEWER MANHOLE

CONTOURS MAJOR CONTOURS MINOR

HIGH VISIBILITY SILT FENCE HIGH VISIBILITY FENCE

CLEARING AND GRUBBING

FILL LINE CUT LINE

ASPHALT EDGE

CONCRETE LINE EDGE OF GRAVEL

BARBWIRE FENCE CHAIN LINK FENCE

TEMPORARY SAFETY FENCE STRUCTURAL EARTH WALL

COFFER DAM

#### **ABBREVIATIONS:**

EVCE

ΙP

LT

ACP ASPHALT CONCRETE PAVEMENT MATCH EXISTING ME вос BACK OF CURB MIN MINIMUM BOW BOTTOM OF WALL MON MONUMENT BP BEGIN POINT NORTH, NORTHING BVCE BEGIN VERTICAL CURVE ELEVATION N.I.C. NOT IN CONTRACT NOT STEEPER THAN BEGIN VERTICAL CURVE STATION NST BVCS CB CATCH BASIN OP POWER (OVERHEAD) C&G CURB AND GUTTER PC POINT OF CURVE C/L CENTERLINE Ы POINT OF INTERSECTION CONC CONCRETE PT POINT OF TANGENT CONST CONSTRUCTION P/L PROPERTY LINE CMP CORRUGATED METAL PIPE PUD PUBLIC UTILITY DISTRICT CP CONCRETE PIPE PVI POINT OF VERTICAL INTERSECTION

CSTC CRUSHED SURFACING TOP COURSE REBAR & CAP KING COUNTY DIA DIAMETER REINE REINFORCED DI, DIP DUCTILE IRON PIPE ROW or R/W RIGHT-OF-WAY EAST, EASTING RR RAIL ROAD EP END POINT SD STORM DRAIN EOA SDME STORMWATER MANHOLE EDGE OF ASPHALT

**EVCS** END VERTICAL CURB STATION SIM SIMILAR SS SANITARY SEWER EOG EDGE OF GRAVEL ST STEEL EOP EDGE OF PAVEMENT STA EX, EXIST EXISTING STATION FOC FACE OF CURB TEL TELEPHONE

END VERTICAL CURB ELEVATION

FL FLANGE, FLOWLINE TESC TEMPORARY EROSION AND SEDIMENT CONTROL TOW TOP OF WALL G GAS TYP TYPICAL GB GRADE BREAK НМА HOT MIX ASPHALT W WATER INVERT ELEVATION WS WATER SERVICE ΙE

WASHINGTON STATE DEPARTMENT OF TRANSPORTATION WSDOT LF LINEAR FEET WELDED WIRE MESH

RCKC

SHT

SHEET

WWM LOW POINT LEFT

#### **DETAIL AND SECTION DESIGNATION**



12345 STANDARD DETAIL

THE SAME DRAWING/SHEET

- INDICATES DRAWING/SHEET

WHERE SECTION IS SHOWN

INDICATES DETAIL NUMBER -SUBTITLE DETAIL NO SCALE INDICATES DRAWING/SHEET WHERE DETAIL IS REFERRED TO-

INDICATES SECTION LETTER-SUBTITLE SECTION NO SCALE INDICATES DRAWING/SHEET WHERE SECTION IS REFERRED TO

**PERMIT SUBMITTAL DRAWINGS** 











ROJECT NAME CITY OF MARYSVILLE GEDDES MARINA PHASE 2 REMEDIATION MARYSVILLE, WA


**NOTES, LEGEND AND ABBREVIATIONS** 


DRAWING NO. 2 OF 11

G2

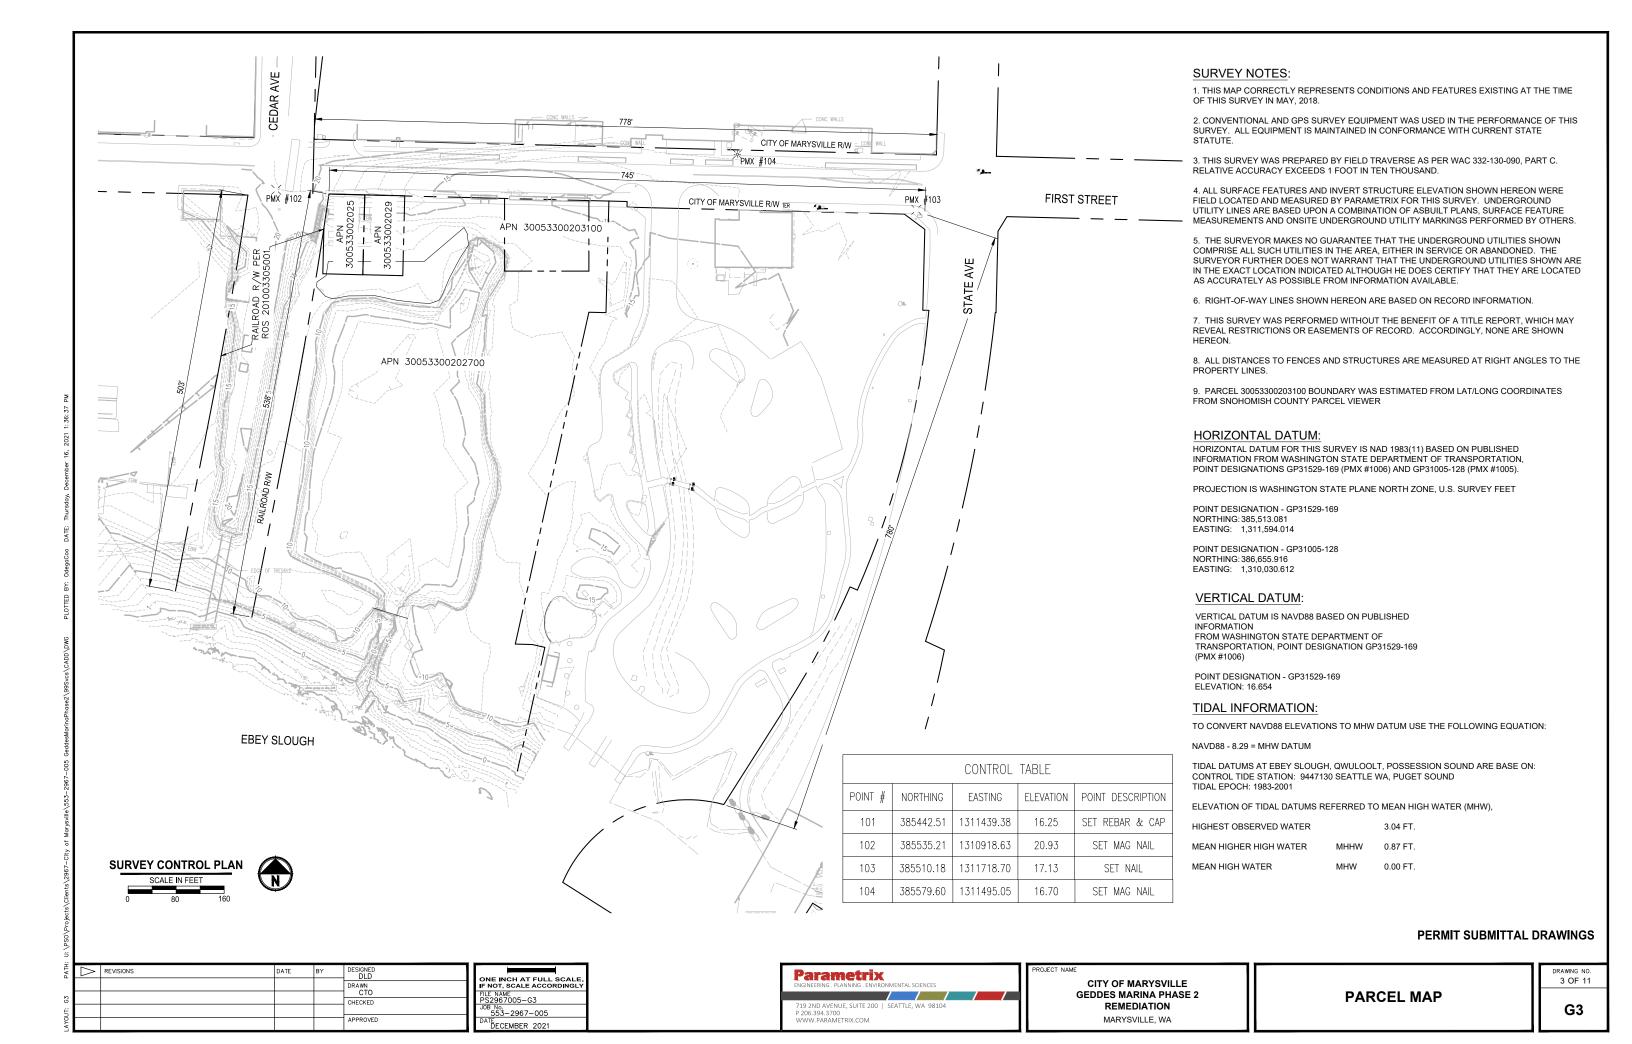

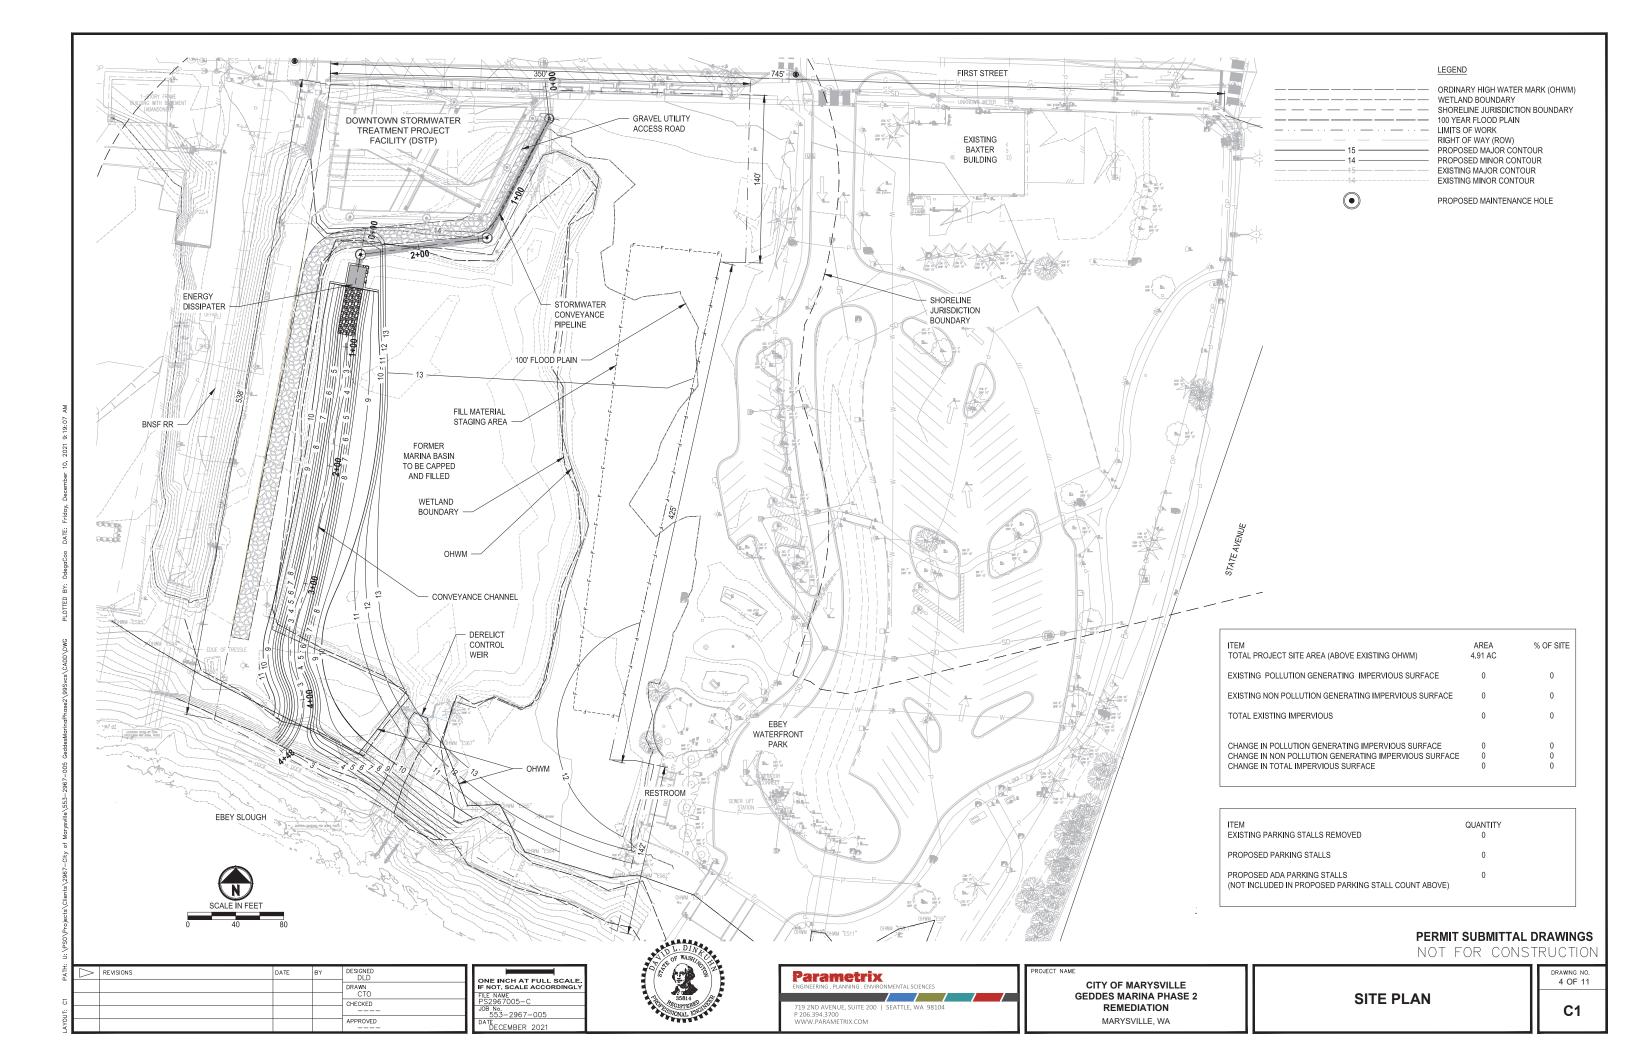

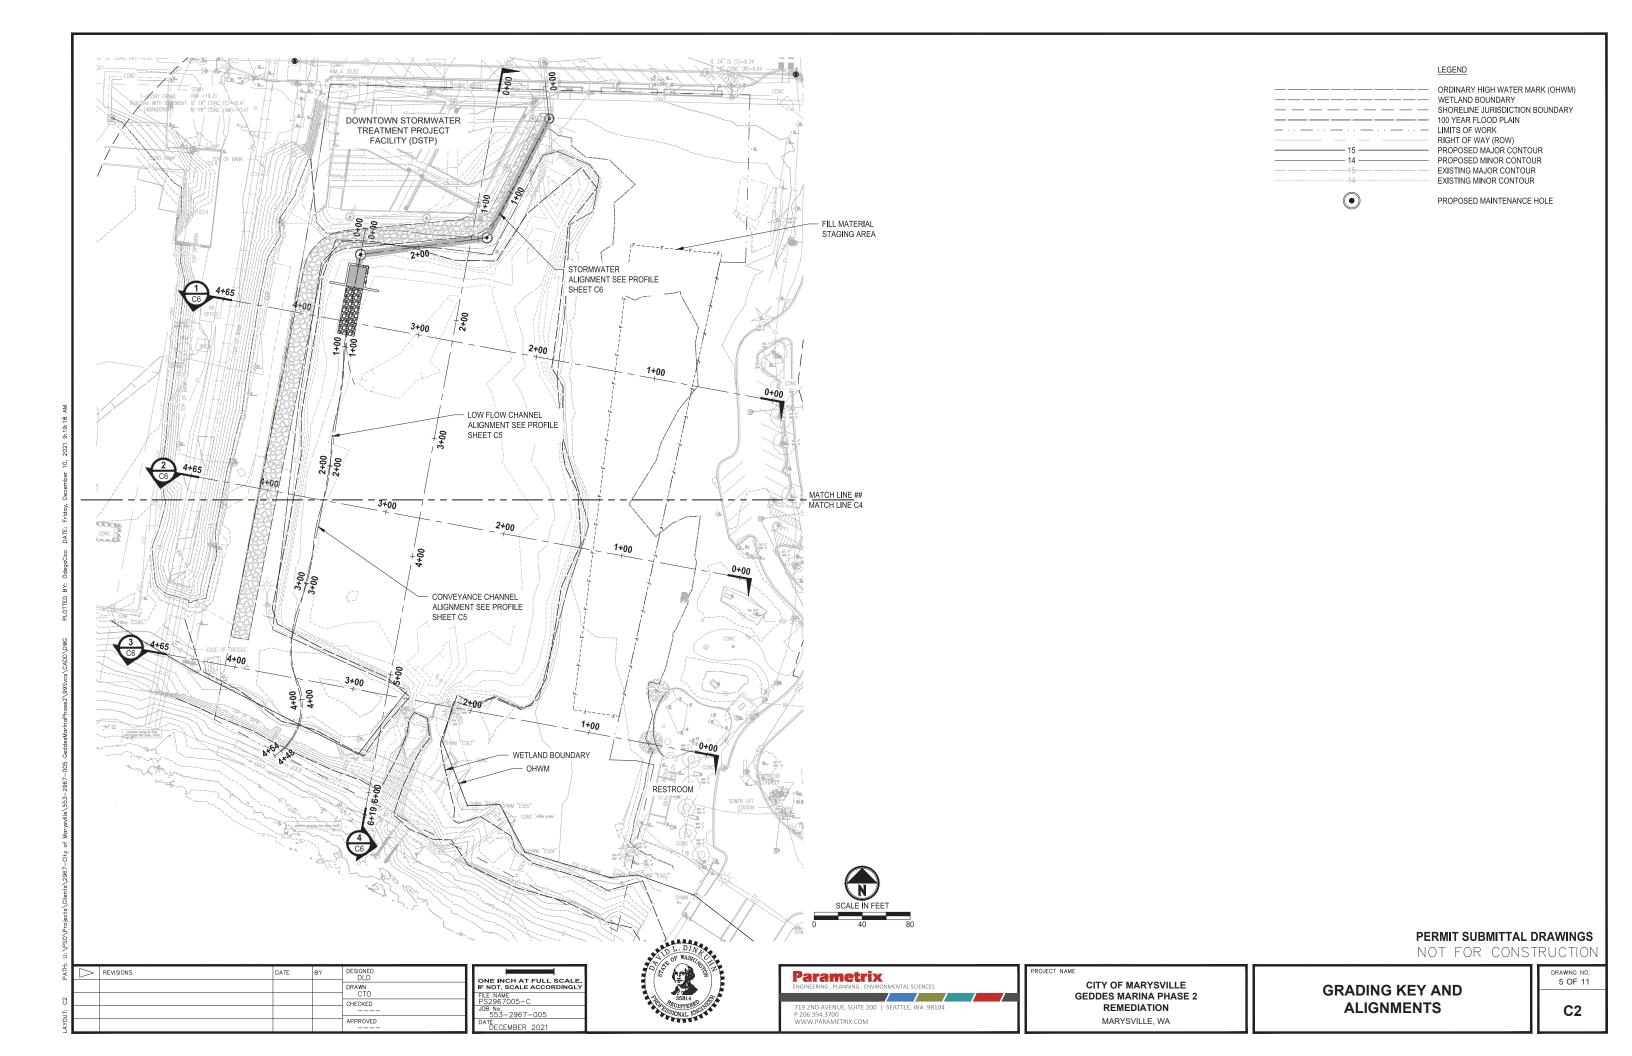

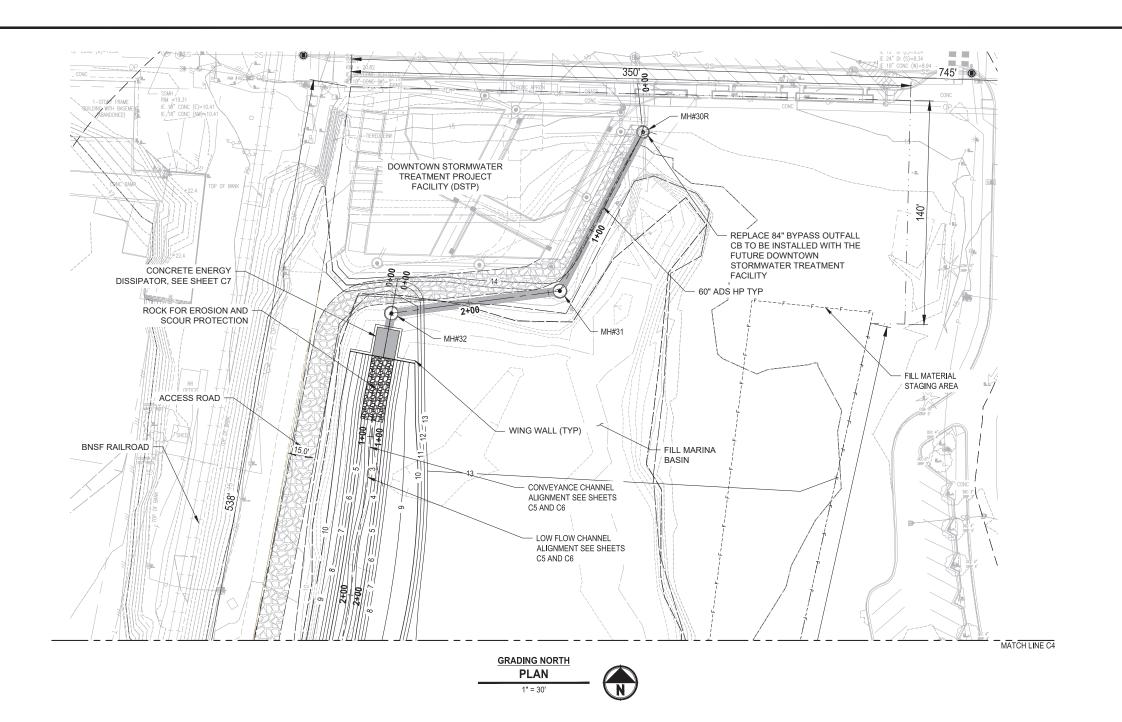

LEGEND

ORDINARY HIGH WATER MARK (OHWM)

WETLAND BOUNDARY

SHORELINE JURISDICTION BOUNDARY

100 YEAR FLOOD PLAIN

LIMITS OF WORK

RIGHT OF WAY (ROW)

15 PROPOSED MAJOR CONTOUR

14 PROPOSED MINOR CONTOUR

15 EXISTING MAJOR CONTOUR

44 EXISTING MAJOR CONTOUR

44 EXISTING MINOR CONTOUR

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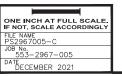
ORDINARY HIGH WATER MARK (OHWM)

PROPOSED MAINTENANCE HOLE

## PERMIT SUBMITTAL DRAWINGS

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REVISIONS DRAWN CTO CHECKED APPROVED





Parametrix engineering . Planning . Environmental sciences	PROJECT NAME
719 2ND AVENUE, SUITE 200   SEATTLE, WA 98104 P 206.394.3700 WWW.PARAMETRIX.COM	G

CITY OF MARYSVILLE **GEDDES MARINA PHASE 2** REMEDIATION MARYSVILLE, WA

**GRADING PLAN NORTH** 

DRAWING	NO.	
6 OF	11	

C3

MATCH LINE ## 2+00 1+00 FILL MARINA BASIN - CONVEYANCE CHANNEL ALIGNMENT SEE SHEETS 12 C5 AND C6 FILL MATERIAL - LOW FLOW CHANNEL ALIGNMENT SEE SHEETS STAGING AREA C5 AND C6 PLAYGROUND F 1+00 OHWM RESTROOM **GRADING SOUTH** PLAN

> PERMIT SUBMITTAL DRAWINGS NOT FOR CONSTRUCTION

LEGEND

ORDINARY HIGH WATER MARK (OHWM)

WETLAND BOUNDARY

SHORELINE JURISDICTION BOUNDARY

100 YEAR FLOOD PLAIN

LIMITS OF WORK

RIGHT OF WAY (ROW)

15 PROPOSED MAJOR CONTOUR

14 PROPOSED MINOR CONTOUR

15 EXISTING MAJOR CONTOUR

14 EXISTING MAJOR CONTOUR

15 EXISTING MINOR CONTOUR

14 EXISTING MINOR CONTOUR

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ORDINARY HIGH WATER MARK (OHWM)

PROPOSED MAINTENANCE HOLE

ONE INCH AT FULL SCALE
IF NOT, SCALE ACCORDINGLY REVISIONS DRAWN CTO CHECKED FILE NAME PS2967005-C JOB No. 553-2967-005 APPROVED



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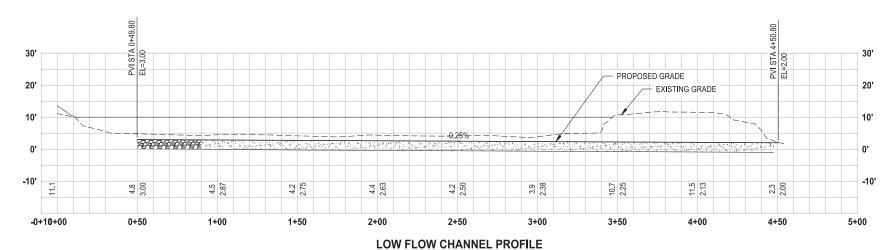
**GRADING PLAN SOUTH** 

DRAWING NO. 7 OF 11

C4

HORIZ: 1" = 30' VERT: 1" = 15'

**CONVEYANCE CHANNEL PROFILE** 



HORIZ: 1" = 30' VERT: 1" = 15'

REVISIONS

DATE
BY
DESIGNED
DLD
DRAWN
CTO
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APPROVED

PS2967-005

DATE DECEMBER 2021





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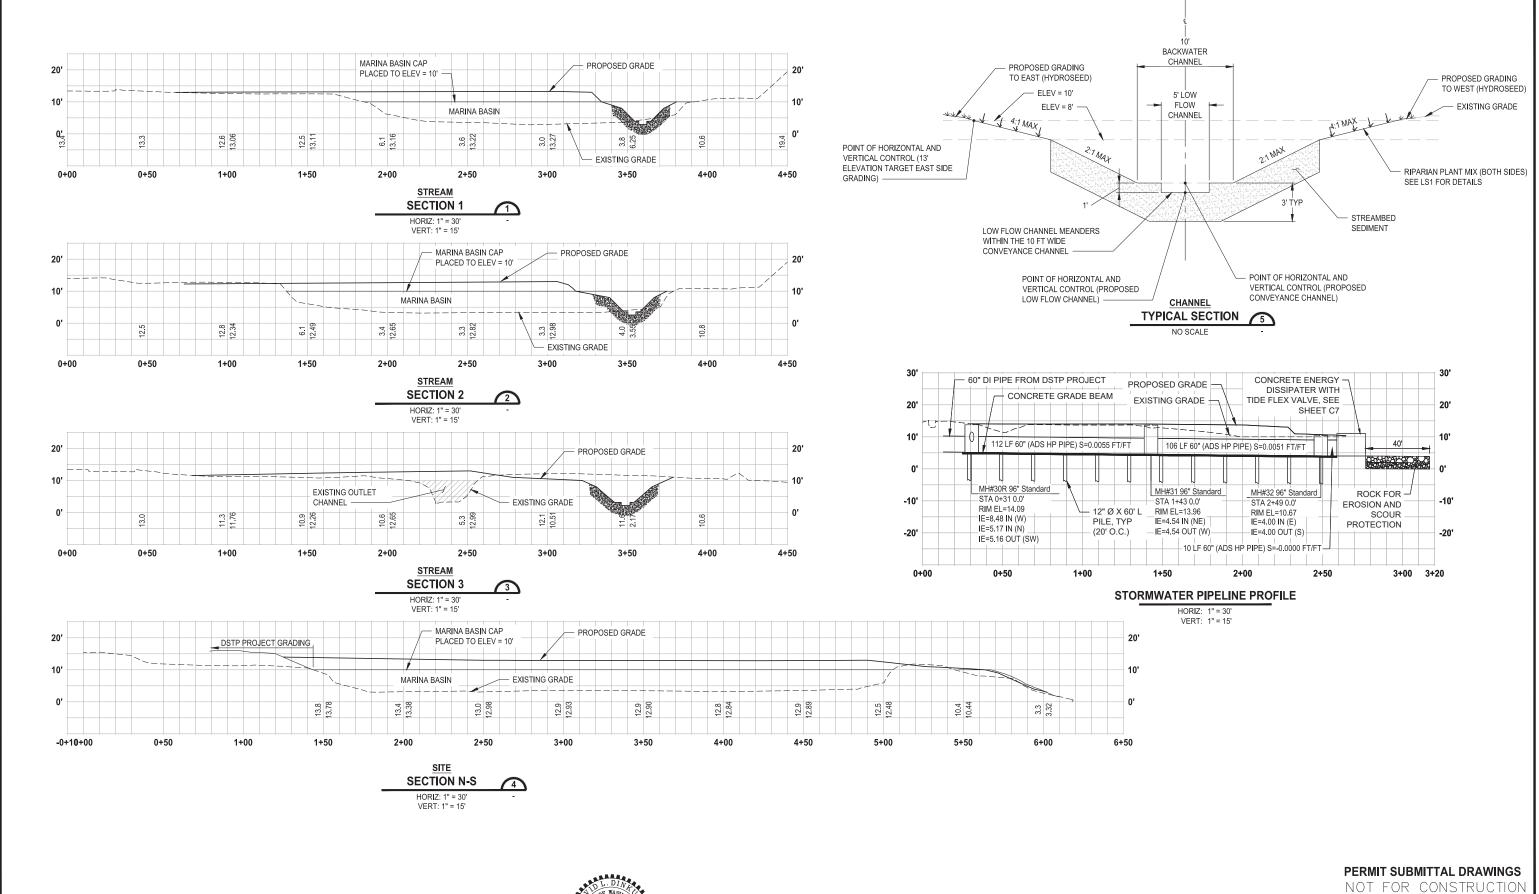
**CHANNEL PROFILES** 

NOT FOR CONSTRUCTION

DRAWING NO.
8 OF 11

PROFILES

PERMIT SUBMITTAL DRAWINGS



**SECTIONS AND** 

9 OF 11 C6

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REVISIONS

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**CITY OF MARYSVILLE GEDDES MARINA PHASE 2** REMEDIATION MARYSVILLE, WA

STORMWATER PROFILE



EXAMPLE CONCRETE ENERGY DISSIPATOR WITH TIDE FLEX VALVE

NO SCALE

REVISIONS

DATE
BY
DESIGNED
DLD

DRAWN
CTO
CHECKED
APPROVED

APPROVED

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**DETAILS** 

DRAWING NO. 10 OF 11

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**C7** 

Projects/Clients\2967—City of Marysville\555—2967—005 GeddesMarinat

C7 PATH: U: \PSO\Projects\

