SUNSET GROVE APTS INFILTRATION TRENCH.-OPEN SPACE, LANDSCAPE, AND IRRIGATION PLAN SEE CIVIL SET **UNIT SIZE** AREA REQUIRED PROPERTY BOUNDARY 1-BEDROOM 100 SF/UNIT 2+ BEDROOMS 150 SF/UNIT **CONCRETE SIDEWALK** 39.56' 2 @ 1-BEDROOM 2x100 = 200 SFPAVERS FLUSH WITH CONCRETE 9x150 = 1,350 SF9 @ 2-BEDROOM SIDEWALK - PLANTED CONTAINER 5 @ 3-BEDROOM 5x150 = 750 SFPERMEABLE PAVERS 2,300 SF REQ'D - STONE CUBE SEATS PICNIC TABLE, IN-GROUND MOUNT. DO-2,300 SF OUTDOOR COMMON AREA PROVIDED - 605 SQ FT RECREATION SPACE NOT LOCATE FOOTING IN INFIL TRENCH PROVIDED - 6' WIDTH PATH FROM BUILDING - PLANTED CONTAINER DRIVEWAY TO PARKING PLANT SCHEDULE INSIDE BLDG - PLANTED CONTAINER PUTTING GREEN-SHORTER TURFGRASS-TALLER TURFGRASS-1,645 SQ FT RECREATION SPACE-PROVIDED PUTTING GREEN-INFILTRATION TRENCH.-SEE CIVIL SET **PUTTING GREEN** PROPERTY BOUNDARY--INFILTRATION TRENCH. PERMEABLE PAVERS, ECO-PRIORA PROPOSED BUILDING. SEE STONE CUBE SEATS SEE CIVIL SET ARCHITECT SET SE-5165 -PROPERTY BOUNDARY • Size: 6' • Finish: Powder Coated • Installation: In-Ground Mount, Surface Mount Category: Benches -EXISTING TREES TO BE RETAINED, TYP. PICNIC TABLE BENCH WITH BACK N89°36[°]107"W 95.00'

PROPERTY BOUNDARY

OPEN SPACE PLAN


SCALE 1" = 10'-0"




	BOTANICAL NAME	COMMON NAME	QIY	SIZE	REMARKS
TREES Cercidiphyllum japonicum		Katsura	3	1-1/2" cal	Full and Matching
©	SHRUBS and GROUND COVER Sarcoccocca hook. humilis Euonymus fort. 'Emerald n Gold' Nandina domestica 'Firepower'	Sweetbox Euonymus Nandina	2 10 18	1-gallon 1-gallon 1-gallon	Full and Matching Full and Matching Full and Matching
	Arctostaphyllos uva-ursi	Kinnikinnik	As req'd	1 gallon	Plant 36" on-center
	Gaultheria shallon	Salal	As req'd	1 gallon	Plant 48" on-center



SKU: SE-5340 Category: Tables

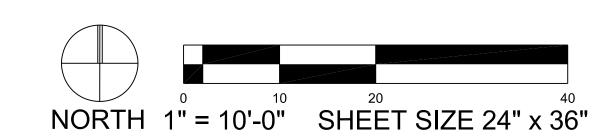

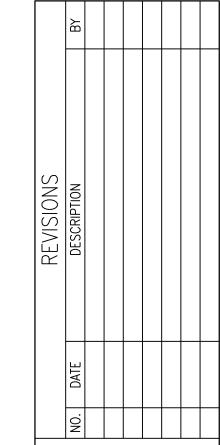



SUNRISE (4726 GROVE

OPEN

PUBLIC

JOB NUMBER: DRAWING NAME: DESIGNER: DRAFTING BY: AS SHOWN

JURISDICTION: MARYSVILLE L-SHEET 1 of 4

SUNSET GROVE APTS

OPEN SPACE, LANDSCAPE, AND IRRIGATION PLAN

LANDSCAPE PLANTING NOTES AND MATERIALS

FURNISH ALL MATERIALS, LABOR, EQUIPMENT AND RELATED ITEMS NECESSARY TO ACCOMPLISH TOPSOIL, TREATMENT AND PREPARATION OF SOIL, FINISH GRADING, PLACEMENT OF SPECIFIED PLANT MATERIALS, FERTILIZER, STAKING, MULCH, CLEAN-UP, DEBRIS REMOVAL, AND 30-DAY MAINTENANCE.

LANDSCAPE CONTRACTOR TO BE SKILLED AND KNOWLEDGEABLE IN THE FIELD OF WORK AND HAVE A MINIMUM OF FIVE (5) YEAR'S EXPERIENCE INSTALLING SIMILAR WORK. CONTRACTOR TO BE LICENSED TO PERFORM THE WORK SPECIFIED WITHIN THE PRESIDING JURISDICTION.

JOB CONDITIONS:

IT IS THE CONTRACTOR'S RESPONSIBILITY TO REVIEW THE SITE AND REPORT ANY DISCREPANCIES TO THE OWNER OR THE OWNER'S REPRESENTATIVES. ALL PLANT MATERIAL AND FINISH GRADES ARE SUBJECT TO APPROVAL BY THE OWNER.

SAVE AND PROTECT ALL EXISTING PLANTINGS SHOWN TO REMAIN. DO NOT PLANT UNTIL OTHER CONSTRUCTION OPERATIONS WHICH CONFLICT HAVE BEEN COMPLETED. IF AN IRRIGATION SYSTEM IS TO BE INSTALLED DO NOT PLANT UNTIL THE SYSTEM HAS BEEN INSTALLED, TESTED AND APPROVED BY THE OWNER. HANDLE PLANTS WITH CARE - DO NOT DAMAGE OR BREAK ROOT SYSTEM, BARK, OR BRANCHES. REPAIR AND/OR REPLACE ITEMS DAMAGED AS A RESULT OF WORK, OR WORK NOT IN COMPLIANCE WITH PLANS AND SPECIFICATIONS, AS DIRECTED BY OWNER AT NO ADDITIONAL COST TO THE OWNER.

REPAIR OF EXISTING PLANTINGS:

DURING THE COURSE OF WORK, REPAIR ALL EXISTING PLANTING AREAS BY PRUNING DEAD GROWTH, RE-ESTABLISHING FINISH GRADE AND RE-MULCHING TO SPECIFIED DEPTH.

GUARANTEE ALL PLANT MATERIAL FOR A PERIOD OF ONE YEAR FROM DATE OF FINAL ACCEPTANCE OF THE JOB BY OWNER.

CONTRACTOR TO PROVIDE OWNER WITH A SCOPE OF WORK AT TIME OF INITIAL PROJECT BID TO PROVIDE LANDSCAPE AND IRRIGATION MAINTENANCE FOR 30 DAYS FOLLOWING STORE OPENING. WORK TO INCLUDE MAINTENANCE AS DESCRIBED BELOW, IN PLANTING AND IRRIGATION MAINTENANCE.

SUBMIT THE FOLLOWING TO THE LANDSCAPE ARCHITECT FOR REVIEW AND APPROVAL PRIOR TO THE START OF ANY WORK:

- A) DOCUMENTATION THAT ALL PLANT MATERIAL HAS BEEN ORDERED.
- B) TOPSOIL ANALYSIS AND RECOMMENDED AMENDMENTS.
- C) TREE STAKING AND GUYING MATERIALS.
- D) ONE (1) QUART SIZE OF TOPSOIL AND MULCH. E) PLANTING SCHEDULE INCLUDING DATES AND TIMES.
- F) MAINTENANCE INSTRUCTIONS FOR ONE (1) FULL YEAR.

MATERIALS:

PLANT MATERIALS TO BE GRADE NO. 1, SIZED IN ACCORDANCE WITH (AAN) AMERICAN STANDARDS FOR NURSERY STOCK (ANSI Z60.1-2004). PRUNE PLANTS RECEIVED FROM THE NURSERY ONLY UPON AUTHORIZATION BY THE LANDSCAPE ARCHITECT. "B & B" INDICATES BALLED AND BURLAPPED; "CONT." INDICATES CONTAINER; "BR" INDICATES BARE ROOT; "GAL" INDICATES GALLON.

- A) SPECIFIED PLANT CANOPY SIZE OR CALIPER IS THE MINIMUM ACCEPTABLE CONTAINER OR BALL SIZE AND ESTABLISHES MINIMUM PLANT CONDITION TO BE PROVIDED.
- B) QUALITY: PLANT MATERIAL TO COMPLY WITH STATE AND FEDERAL LAWS FOR DISEASE INSPECTION, PLANTS TO BE FULLY LIVE, VIGOROUS, WELL FORMED, WITH WELL DEVELOPED FIBROUS ROOT SYSTEMS. ROOT BALLS OF PLANTS TO BE SOLID AND FIRMLY HELD TOGETHER, SECURELY CONTAINED AND PROTECTED FROM INJURY AND DESICCATION. PLANTS DETERMINED BY LANDSCAPE ARCHITECT TO HAVE BEEN DAMAGED; HAVE DEFORMITIES OF STEM, BRANCHES, OR ROOTS; LACK SYMMETRY, HAVE MULTIPLE LEADERS OR "Y" CROTCHES LESS THAN 30 DEGREES IN TREES, OR DO NOT MEET SIZE OR ANSI STANDARDS WILL BE REJECTED. PLANT MATERIAL TO BE FROM A SINGLE NURSERY SOURCE FOR EACH SPECIFIED SPECIES/HYBRID. NURSERY SOURCES TO BE THOSE LOCATED IN THE SAME REGION AS THE JOB SITE.
- NO SUBSTITUTION OF PLANT MATERIAL, SPECIES OR VARIETY, WILL BE PERMITTED UNLESS WRITTEN EVIDENCE IS SUBMITTED TO THE OWNER FROM TWO QUALIFIED PLANT BROKERAGE OFFICES. SUBSTITUTIONS WHICH ARE PERMITTED TO BE IN WRITING FROM THE OWNER AND LANDSCAPE ARCHITECT. THE SPECIFIED SIZE, SPECIES AND NEAREST VARIETY. AS APPROVED, TO BE FURNISHED. SUBSTITUTIONS MAY REQUIRE SUBMITTAL TO REVISED LANDSCAPE PLAN TO CITY FOR APPROVAL
- D) LABEL AT LEAST ONE (1) TREE, SHRUB, AND GROUNDCOVER OF EACH VARIETY WITH A SECURELY ATTACHED WATERPROOF TAG BEARING LEGIBLE DESIGNATION OF BOTANICAL
- E) DELIVER PLANT MATERIAL AFTER PREPARATION OF PLANTING AREAS HAVE BEEN COMPLETED AND PLANT IMMEDIATELY. IF PLANTING IS DELAYED MORE THAN SIX (6) HOURS AFTER DELIVERY, SET MATERIAL IN SHADE, PROTECT FOR WEATHER AND MECHANICAL DAMAGE, AND KEEP ROOT BALLS MOIST BY COVERING WITH MULCH, BURLAP OR OTHER ACCEPTABLE MEANS OF RETAINING MOISTURE.

TOPSOIL, AMENDMENT, AND BACKFILL, ARE GENERAL REQUIREMENTS FOR ALL LANDSCAPE AREAS, UNLESS NOTED OTHERWISE ON THE PLANS. SOIL AMENDMENTS AND FERTILIZER NOTED BELOW ARE TO BE USED FOR BID PRICE BASIS ONLY. SPECIFIC AMENDMENTS AND FERTILIZERS WILL BE MADE AFTER SOIL SAMPLES ARE LABORATORY TESTED BY THE CONTRACTOR. PROVIDE CHANGE ORDER FOR ADDITIONAL OR REDUCTION OF MATERIALS REQUIRED OR NOT REQUIRED BY THE SOILS REPORT.

SOIL FERTILITY AND AGRICULTURAL SUITABILITY ANALYSIS:

AFTER ROUGH GRADING AND PRIOR TO SOIL PREPARATION, CONTRACTOR TO OBTAIN TWO REPRESENTATIVE SOIL SAMPLES, FROM LOCATIONS AS DIRECTED BY THE LANDSCAPE ARCHITECT. TO A SOIL TESTING LABORATORY TO TEST FOR NUTRIENTS, pH, AND ORGANIC MATTER. SUBMIT RESULTS TO LANDSCAPE ARCHITECT FOR REVIEW. TESTS TO BE CONTRACTED WITH AND PAID FOR BY THE CONTRACTOR.

A) TOPSOIL:

ALL LANDSCAPED AND LAWN AREAS, EXCEPT AREAS WITHIN THE DRIPLINE OF PRESERVED TREES, SHALL BE AMENDED PER BMP T5.13, POST CONSTRUCTION SOIL QUALITY AND DEPTH, IN VOLUME V OF THE WASHINGTON DEPARTMENT OF ECOLOGY 2012 STORMWATER MANAGEMENT MANUAL FOR WESTERN WASHINGTON, AS MAY BE AMENDED HEREAFTER. DEEPER SOIL AMENDMENT WILL PROVIDE IMPROVED GROWING MEDIUM AND INCREASED WATER HOLDING CAPACITY.

ORGANIC MULCH (TOPDRESSING):

CEDAR GROVE COMPOST (OR APPROVED EQUAL) IN ALL LANDSCAPE AREAS.

2-INCH DIAMETER BY 8-FOOT MINIMUM LODGEPOLE PINE STAKES.

1-INCH WIDE POLYETHYLENE CHAIN LOCK TYPE TIES; OR, 3/8" DIAMETER RUBBER. NO WIRE.

EXECUTION:

VERIFY THAT ALL SOIL CONTAMINANTS (E.G., PAINT, SEALANTS, SOLVENTS, OILS, GREASES, CONCRETE/ASPHALT SPOILS, ETC.) HAVE BEEN SATISFACTORY REMOVED FROM ALL PLANTING AREAS. DO NOT BEGIN WORK UNTIL UNSATISFACTORY CONDITIONS HAVE BEEN CORRECTED.

FINISH GRADES:

FINE GRADE AND REMOVE ROCKS, DEBRIS, AND FOREIGN OBJECTS OVER 2 INCHES DIAMETER FROM TOP SURFACE OF PREPARED LANDSCAPE AREAS. FINISH ELEVATIONS TO BE DEFINED AS 3 INCHES BELOW CURBS, WALKS AND/OR OTHER ADJACENT HARDSCAPE FOR ALL PLANTING BED AREAS AND 1-INCH BELOW CURBS, WALKS AND/OR OTHER ADJACENT HARDSCAPE FOR ALL LAWN AREAS. FINISH GRADE REFER TO GRADES PRIOR TO INSTALLATION OF MULCH OR LAWN. ALL FINISH GRADES TO BE SMOOTH EVEN GRADES, LIGHTLY COMPACTED, AS SHOWN ON THE PLAN AND DETAILED. PROVIDE POSITIVE DRAINAGE AWAY FROM BUILDINGS AND STRUCTURES. SITE CIVIL DRAWINGS IDENTIFY FINAL ELEVATIONS. MOISTEN PREPARED AREAS BEFORE PLANTING IF SOIL IS DRY. WATER THOROUGHLY AND ALLOW SURFACE TO DRY BEFORE PLANTING. DO NOT CREATE MUDDY SOIL.

ARRANGE TREES AND SHRUBS ON SITE IN PROPOSED LOCATIONS PER DRAWINGS. EXCAVATE PIT, PLANT AND STAKE OR GUY, AS CALLED OUT AND DETAILED. ALL TREES, SHRUBS, AND SUPPORTS TO STAND VERTICAL. BACKFILL SHALL BE PIT SPOILS. SETTLE BACKFILL USING WATER ONLY. NO MECHANICAL COMPACTION.

EXCAVATE PITS TO A MINIMUM OF 3 INCHES BELOW, AND TWICE THE ROOT BALL DIAMETER. WATER THOROUGHLY AND TAKE CARE TO ENSURE THAT ROOT CROWN IS AT PROPER GRADE, AS DETAILED.


MULCH ALL LANDSCAPE AREAS NOT COVERED BY LAWN AND/OR SEED. APPLY SUFFICIENT QUANTITY TO PROVIDE A 2-INCH DEPTH.

FIELD ADJUST PLANT LOCATIONS FOR 8-FOOT SEPARATION OF TREES/SHRUBS AND 2-FOOT SEPARATION FOR GROUNDCOVER FROM FIRE HYDRANTS AND UTILITY VAULTS.


CLEANUP AND PROTECTION:

DURING LANDSCAPE WORK, KEEP ALL PAVEMENT CLEAN AND WORK AREAS IN AN ORDERLY CONDITION. PROTECT LANDSCAPE WORK AND MATERIALS FROM DAMAGE DUE TO LANDSCAPE OPERATIONS AND TRESPASSERS. MAINTAIN PROTECTION DURING INSTALLATION AND MAINTENANCE PERIOD. TREAT, REPAIR, OR REPLACE DAMAGE LANDSCAPE WORK AS DIRECTED BY THE OWNER.

PROVIDE FULL MAINTENANCE BY SKILLED EMPLOYEES OF LANDSCAPE INSTALLERS. CONTRACTOR TO MAINTAIN PLANTINGS THROUGH COMPLETED INSTALLATION, AND UNTIL ACCEPTANCE OF LANDSCAPE INSTALLATION. PLANTING MAINTENANCE TO INCLUDE WATERING, WEEDING, CULTIVATING, TIGHTENING AND REPAIRING OF TREE GUYS, RESETTING PLANTS TO PROPER GRADES OR POSITION, RE-ESTABLISHING SETTLED GRADES; AND MOWING LAWNS WEEKLY AFTER LAWN ESTABLISHMENT. HERBICIDE IS NOT RECOMMENDED FOR ONE YEAR FOLLOWING LANDSCAPE INSTALLATION. INCLUDED IS REPLACEMENT OF DEAD PLANTS AND PLANTS SHOWING LOSS OF 40 PERCENT OR MORE OF

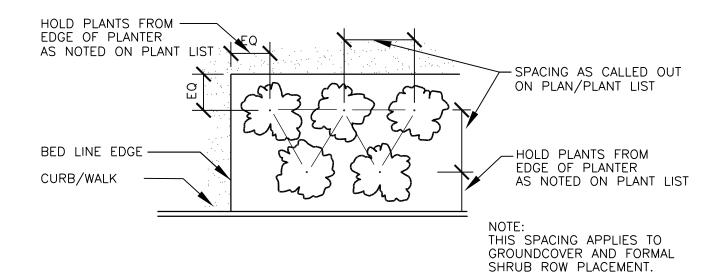


PLANT MATERIAL SPACING DETAIL

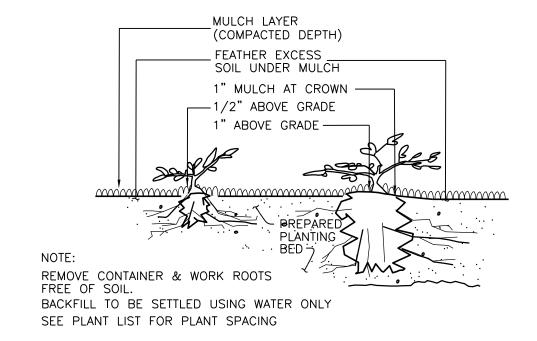


1 GAL. CONTAINER and LARGER (PLANTED BEFORE MULCH)

GROUNDCOVER PLANTING DETAIL

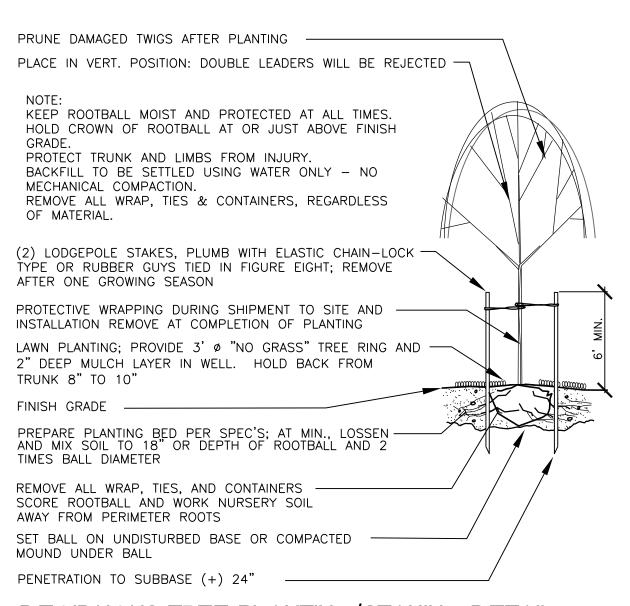

DECIDUOUS TREE PLANTING/STAKING DETAIL

NOT TO SCALE

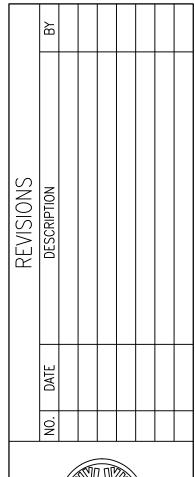




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JOB NUMBER: DRAWING NAME: DESIGNER: DRAFTING BY: 11.17.22 AS SHOWN JURISDICTION: MARYSVILLE

SHEET 2 of 4

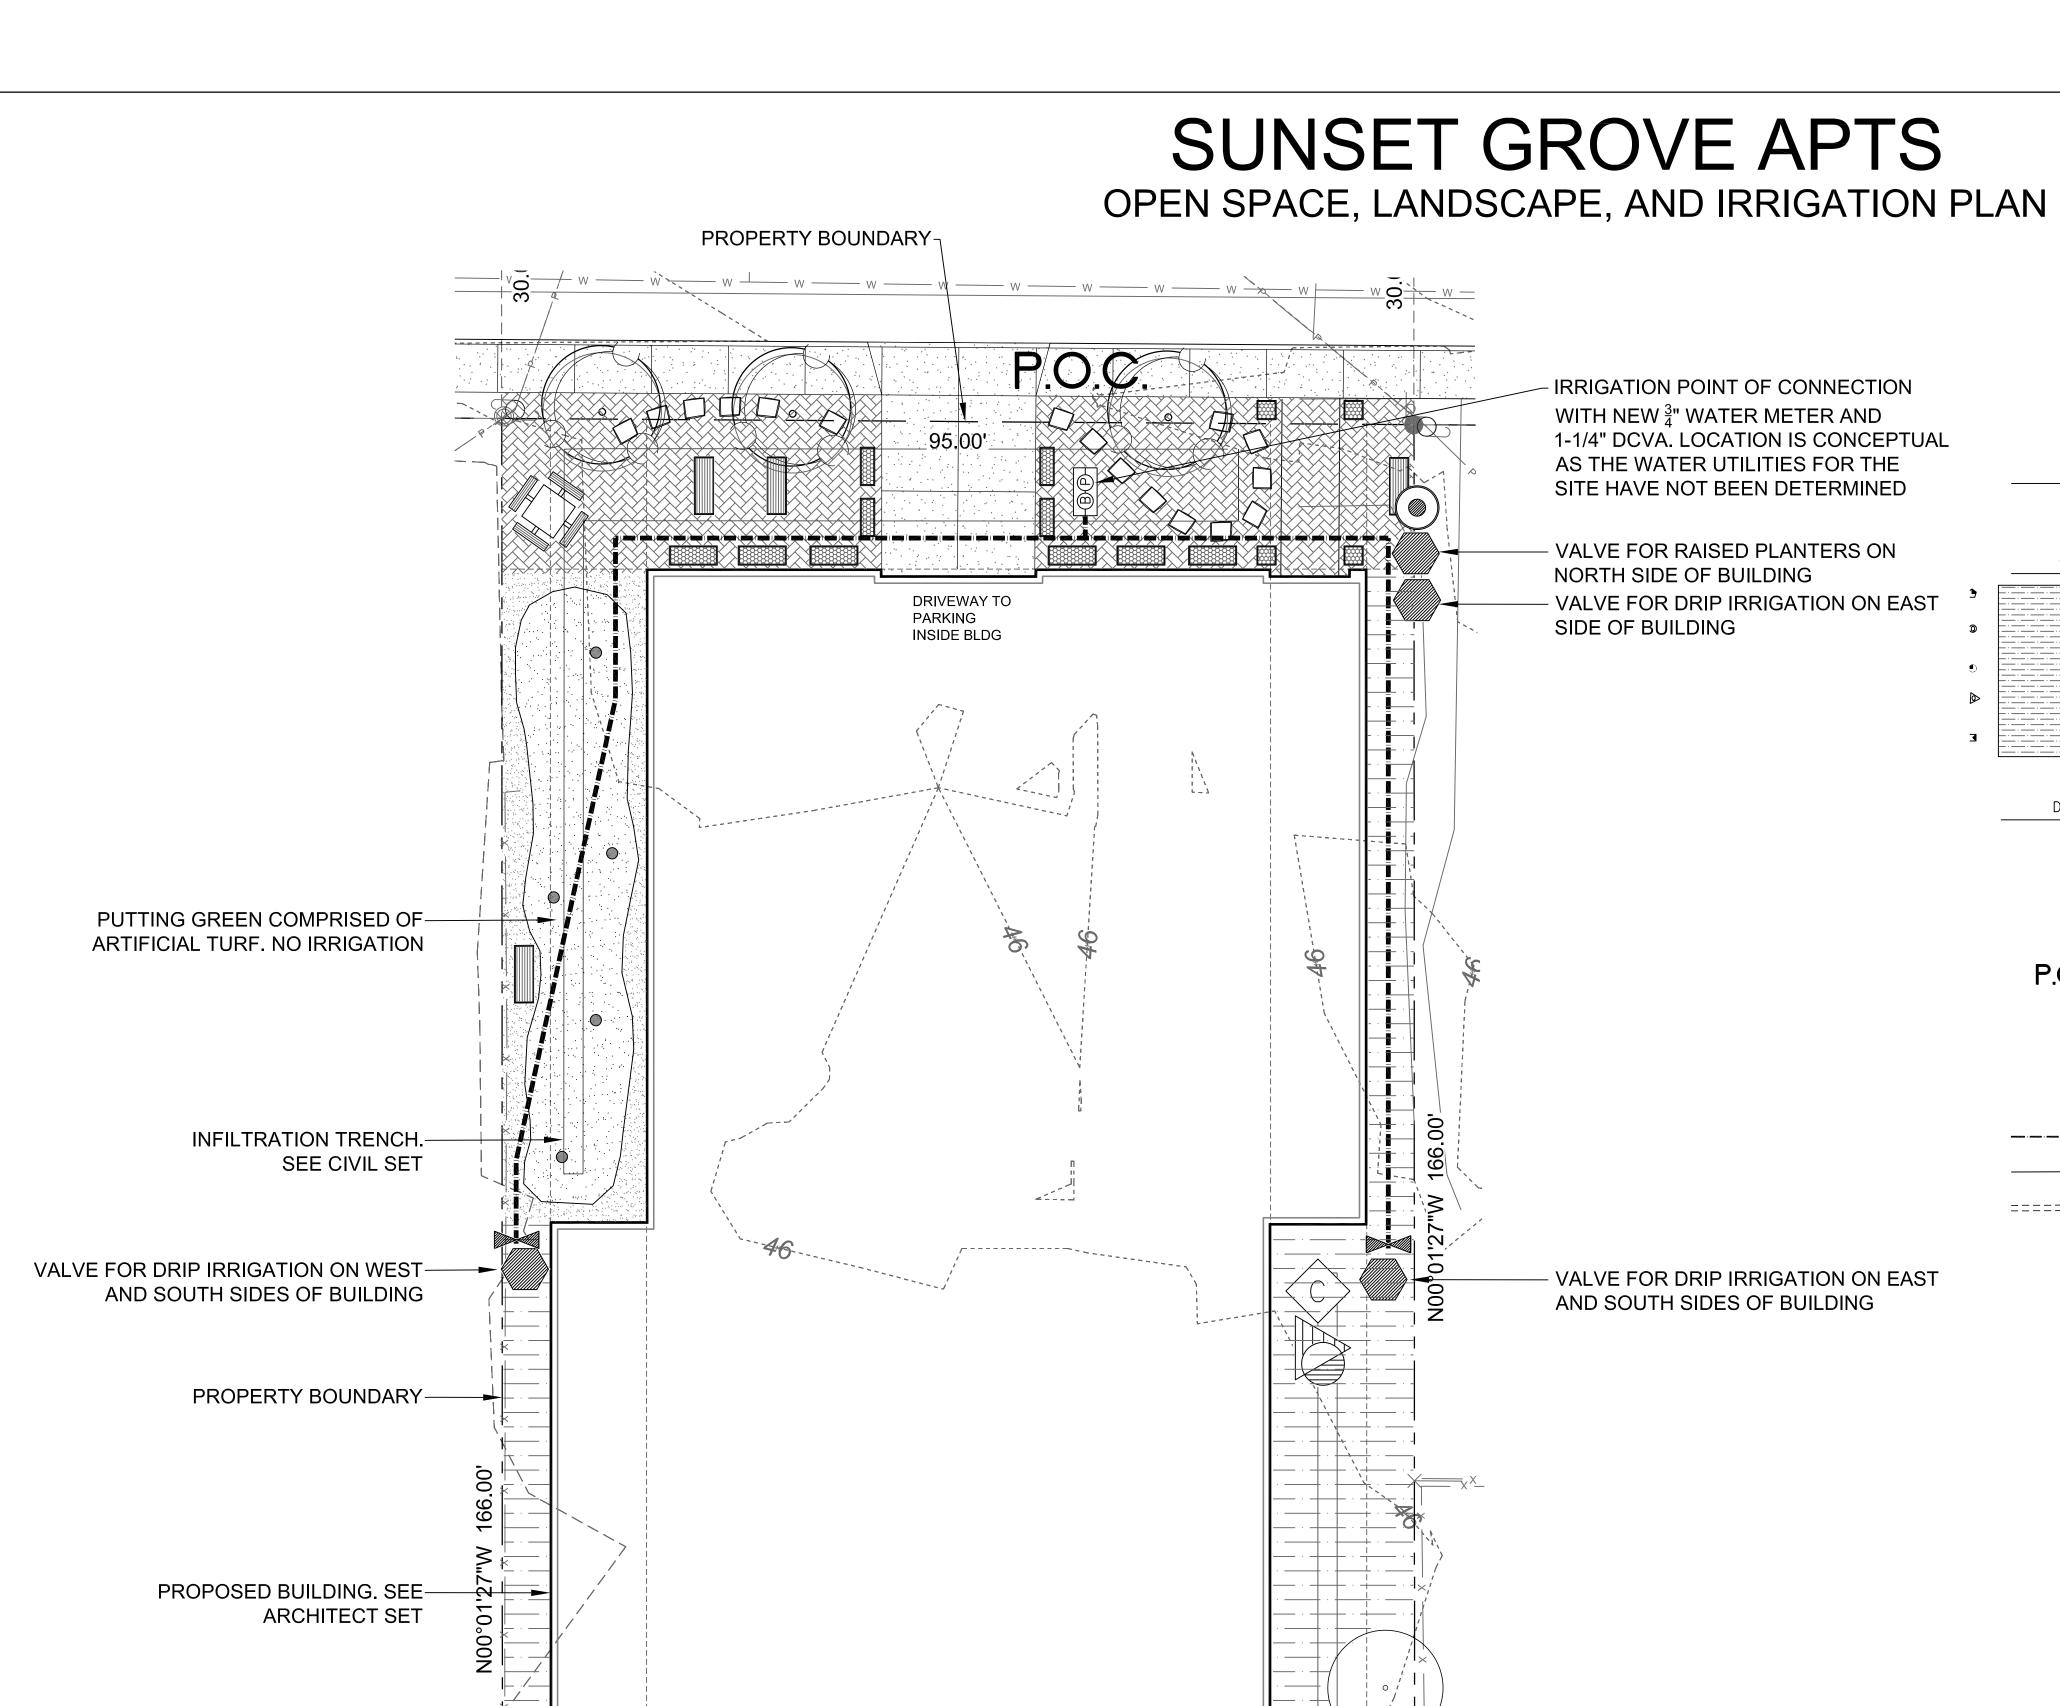

N89°36'07"W 95.00'

IRRIGATION PLAN

SCALE 1" = 10'-0"

PROPERTY BOUNDARY

IRRIGATION SCHEDULE

DESCRIPTION

HUNTER MP ROTATOR PRS30 POP-UP BODY AND CV DRAIN CHECK VALVE, 4" LAWN, 6" SHRUB

	SYMBOL	NOZZLE	PSI	GPM	RADIUS
3		HUNTER-6Q and 6H H, Q SERIES	30	0.98, 0.51	6'
0		HUNTER-MP800SR ADJUSTABLE ARC	30	0.42, 0.23 GPM	8'-10'
•		HUNTER-1000 8-15 F, TH, TT, H, Q SERIES	30	0.84, 0.63, 0.49, 0.42, 0.32, 0,21	12'
D		HUNTER-2000 13-21 F, TQ, TT, H, Q SERIES	30	1.48, 1.10, 0.86, 0.77, 0.57, 0.43	15'
3		HUNTER ES515, SS530 SERIES	30	1.41, 0.65	5'x30' 5'x15'

DESCRIPTION

-PROPERTY BOUNDARY

-HAND-DIG ONLY WITHIN DRIPLINE

OF RETAINED TREES, TYPICAL

SPRAY IRRIGATION: HUNTER ICV 101/151G REMOTE CONTROL VALVE, IN VALVE BOX, ONE VALVE PER BOX

HUNTER SOLAR SYNC WIRE RAIN SENSOR COMBO

HUNTER XC-HYBRID BATTERY-OPERATED CONTROLLER 3 TO 15 STATIONS, (HARDWIRE CONNECTION); PROVIDE GROUND AND BATTERIES PER MANUFACTURER'S SPECIFICATIONS. MOUNT TO 4"x4" P.T. POST. INSTALL POST IN GROUND. PROVIDE OWNER ALL KEYS

P.O.C. WILKINS 950 XLT- 1-1/4" DOUBLE CHECK VALVE (STATE APPROVED); TEST AND CERTIFICATION BY LICENSED BACKFLOW TESTER
WILKINS 850 - BALL VALVE, SIZE TO MATCH PIPE

CARSON INDUSTRIES #1730 (TWO AT P.O.C.) GRADE LEVEL VAULT WITH BOLT LOCK LID

PLASTIC BALL VALVE, MATCH LINE SIZE, IN VALVE BOX

● HUNTER HQ-33DLRC 3/4" QUICK COUPLING VALVE, IN VALVE BOX, PROVIDE TWO KEYS AND SWIVELS

LATERAL - SCH 40 PVC (12" COVER); SIZE PER PLAN, 3/4" SIZE MINIMUM

IRRIGATION SHOWN DIAGRAMATICALLY FOR PLAN CLARITY. COMMON TRENCH AND PLACE EQUIPMENT IN LANDSCAPE; MANIFOLD GROUPED VALVES IN ADJACENT SHRUB AREAS WHERE

SCH 40 PIPE SIZING CHART


PIPE SIZE	3/4"	1"	1 1/4"	1 1/2"	2"	2 1/2"	
FLOW							
CDM	1_2	2 1_13	177 27	27 1 72	701 57	571 71	CDM (MAY)

/E APARTMENTS
EET, MARYSVILLE WA

SUNRISE G 4726 GROVE 8


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ΓE:	11.17.22
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RISDICTION:	MARYSVILLE

L-3SHEET 3 of 4

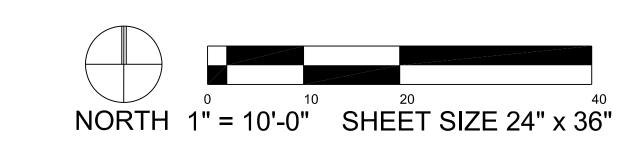

SUNSET GROVE APTS

OPEN SPACE, LANDSCAPE, AND IRRIGATION PLAN

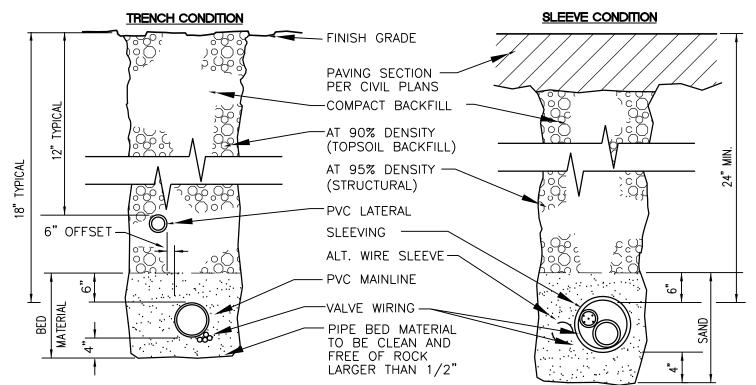


SLEEVING MATERIAL SHALL BE PVC CLASS 160(SDR-26).

DIMENSIONS ARE MIN. CLEARANCES.

ALL IRRIGATION SLEEVING TRENCH BACKFILL MATERIAL SHALL BE CLASS "B" OR BETTER (MAX. OF 10% PASSING NO.40 SCREEN) AND BE COMPACTED TO MIN. 95% OPTIMUM DENSITY PER ASTM D-1557-70


SLEEVE/TRENCHING DETAIL

NOT TO SCALE

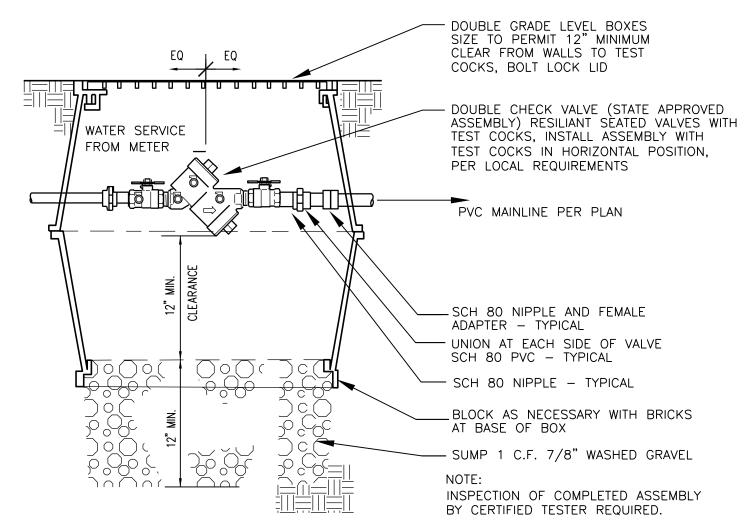

CHECK VALVE ASSEMBLY DETAIL

NOT TO SCALE

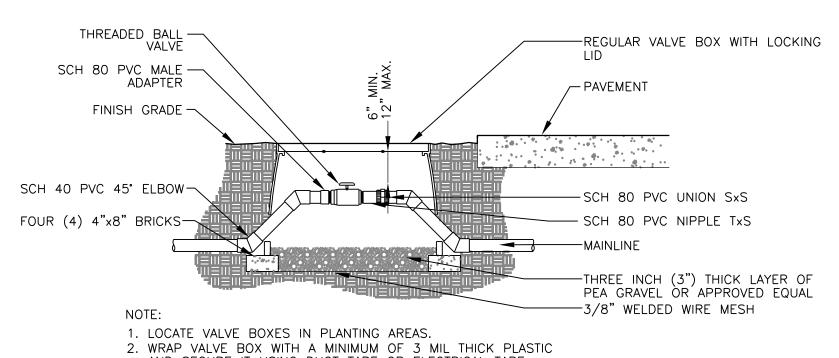

AND SECURE IT USING DUCT TAPE OR ELECTRICAL TAPE. 3. ALL THREADED CONNECTIONS TO BE MADE USING TEFLON TAPE

4. ALL CHANGES IN ELEVATION SHALL BE MADE USING SCH 40

BALL VALVE DETAIL

NOT TO SCALE

LANDSCAPE IRRIGATION NOTES


- GENERAL CONTRACTOR AND LANDSCAPE CONTRACTOR TO COORDINATE
 - INSTALLATION OF IRRIGATION/SERVICE METER AND STUB TO IRRIGATION POINT OF CONNECTION, PER UTILITY PLAN(S). PROVIDE STANDARD THREADED STUB-OUT WITH THREADED CAP ON DISCHARGE SIDE OF METER. STUB-OUT TO BE INSTALLED APPROXIMATELY 18 INCHES BELOW
 - VERIFICATION OF STATIC WATER PRESSURE AT POINT-OF-CONNECTION (P.O.C.) LANDSCAPE CONTRACTOR SHALL NOTIFY OWNER AND LANDSCAPE ARCHITECT IN WRITING OF STATIC WATER PRESSURE
 - C) INSTALLATION OF SLEEVING.
- PROVIDE ALL LABOR, MATERIALS, TRANSPORTATION, AND SERVICES NECESSARY TO FURNISH AND INSTALL A COMPLETE IRRIGATION SYSTEM AS INDICATED ON THE DRAWINGS AND/OR NOTES. PROVIDE A ONE (1) YEAR WARRANTY/GUARANTEE FROM FINAL ACCEPTANCE AGAINST ALL DEFECTS IN MATERIALS, EQUIPMENT, AND WORKMANSHIP.
- COORDINATE IRRIGATION INSTALLATION WITH GENERAL CONTRACTOR, ELECTRICAL CONTRACTOR, LANDSCAPE CONTRACTOR, OWNER, ARCHITECT, AND LANDSCAPE ARCHITECT
- LANDSCAPE CONTRACTOR TO TEST AVAILABLE WATER PRESSURE PRIOR TO BEGINNING ANY WORK. PROVIDE WRITTEN TEST RESULTS TO LANDSCAPE ARCHITECT.
- 5. ALL WORK PER LOCAL CODE. INSTALLATION PER MANUFACTURER'S WRITTEN SPECIFICATIONS.
- 6. CONTRACTOR TO OBTAIN AND PAY FOR ALL PERMITS, FEES, AND REQUIRED CITY INSPECTIONS.
- A) SUBMIT EACH ITEM LISTED BELOW FOR LANDSCAPE ARCHITECT'S REVIEW AND APPROVAL:
- PRODUCT DATA: FOR EACH TYPE OF PRODUCT INDICATED,
- C) CONTROL WIRING PATH DIAGRAM,
- D) "AS-BUILT" DRAWINGS.

SUBMITTALS:

- E) OPERATION AND MAINTENANCE MANUALS.
- PROVIDE AND KEEP UP TO DATE A COMPLETE "AS-BUILT" RECORD SET OF PRINTS WHICH ARE TO BE CORRECTED DAILY AND SHOW EVERY CHANGE FROM THE ORIGINAL DRAWINGS AND NOTES AND EXACT "AS-BUILT" LOCATIONS, SIZES AND KIND OF EQUIPMENT. THIS SET OF DRAWINGS. ARE TO BE KEPT ON SITE AND ARE TO BE USED ONLY AS THE RECORD SET. ALL WORK IS TO BE NEAT AND LEGIBLE ANNOTATIONS THEREON DAILY AS THE WORK PROCEEDS, SHOWING WORK AS ACTUALLY INSTALLED.
 - DIMENSION FROM TWO (2) PERMANENT POINTS OF REFERENCE, BUILDING CORNERS, WALKS, OR ROAD INTERSECTIONS, ETC., THE LOCATION OF THE FOLLOWING:
 - A) CONNECTION TO WATER LINES (P.O.C.),
- CONNECTIONS TO ELECTRICAL POWER,
- C) GATE VALVE, QUICK COUPLERS, AND REMOTE CONTROL VALVE,
- ROUTING OF MAINLINE (DIMENSION MAXIMUM 100' ALONG ROUTING),
- ROUTING OF CONTROL WIRING,
- F) OTHER RELATED EQUIPMENT AS DIRECTED BY THE LANDSCAPE ARCHITECT.
- 9. PREPARE AND PROVIDE PRIOR TO COMPLETION OF CONSTRUCTION, A THREE RING BINDER CONTAINING THE FOLLOWING INFORMATION:
 - A) INDEX SHEET STATING CONTRACTOR'S ADDRESS, TELEPHONE NUMBER, FAX, E-MAIL AND A, LIST OF EQUIPMENT WITH NAME AND ADDRESS OF LOCAL MANUFACTURER'S REPRESENTATIVES,
 - CATALOG AND PARTS SHEETS ON EVERY MATERIAL AND EQUIPMENT INSTALLED UNDER THIS, CONTRACT,
 - C) GUARANTEE STATEMENT,
 - COMPLETE OPERATING AND MAINTENANCE INSTRUCTIONS ON ALL MAJOR EQUIPMENT. CONSTRUCTION DETAILS FROM THE PROJECT,

 - COMPLETE TROUBLE-SHOOTING GUIDE TO COMMON IRRIGATION PROBLEMS, G) WINTERIZATION AND SPRING START-UP PROCEDURES,
 - CHART OF APPROXIMATE WATERING TIMES FOR SPRING, SUMMER, AND FALL, I) A COPY OF THE "AS-BUILT" DRAWINGS AND CONTROLLER CHART.


- 10. ALL VALVES TO BE PLACED IN "CARSON" GRADE LEVEL BOXES WITH BOLT-LOCK LIDS (OR APPROVED EQUIVALENT). SET BOXES 2 INCHES HIGHER THAN FINISH GRADE IN MULCH AREAS AND FLUSH WITH FINISH GRADE IN LAWN AREAS. JUMBO BOX FOR CHECK VALVE, 10" ROUND BOX FOR GATE/QUICK COUPLER/WIRE SPLICES, AND 12" STANDARD FOR CONTROL VALVES. PROVIDE BOX EXTENSIONS AS REQUIRED.
- 11. MAINLINE PIPE TO BE BURIED 18 INCHES, LATERALS 12 INCHES, AND SLEEVES 24" INCHES BELOW FINISH GRADE. NO ROCK OR DEBRIS TO BE BACKFILLED OVER PIPE.
- HEAD AND LINE POSITIONING IS DIAGRAMMATIC ON PLAN. ADJUST IN FIELD AS NECESSARY FOR 100 PERCENT COVERAGE. VALVES TO BE POSITIONED ADJACENT TO PAVEMENT/CURBS, IN SHRUB BEDS WHERE POSSIBLE
- FAMILIARIZE OWNERS FACILITY OPERATOR WITH IRRIGATION SYSTEM FUNCTION, CONTROLLER PROGRAMMING, SYSTEM OPERATION AND MAINTENANCE REQUIREMENTS.
- 14. SPRINKLERS ON RISERS WILL NOT BE ALLOWED UNLESS NOTED ON PLANS.
- RADIUS REDUCTION TO BE MADE BY USE OF PRESSURE ADJUSTMENT, SCREENS, AND/OR ALTERNATE NOZZLES. IN-NOZZLE ADJUSTMENT IS LIMITED TO 10 PERCENT FOR SPRAY HEADS AND PER MANUFACTURER'S LIMITS FOR OTHER SPRINKLERS. SPRINKLER SPACING NOT EXCEED 60% OF THE DIAMETER OF THE PUBLISHED DATA.
- 16. ALL CONTROL WIRE SPLICES TO BE MADE AT VALVE BOXES WITH WATER TIGHT ELECTRICAL SPLICES, 3M, SCOTT'S LOCK SEAL TACK 3576-78, OR EQUIVALENT.
- EACH VALVE BOX TO CONTAIN A MINIMUM OF TWO (2) SPARE ORANGE CONTROL WIRES FOR JACKETED WIRE. ROUTE SPARE WIRES FROM THE CONTROLLER TO THE LAST VALVE OF EACH MAINLINE BRANCH. COMMON WIRE TO BE WHITE. SINGLE STRAND WIRE TO BE A MINIMUM OF 14 GAUGE.
- 18. ALL ELECTRICAL EQUIPMENT TO BE U.L. TESTED AND APPROVED, AND BEAR THE U.L. LABEL.
- 19. CROSS CONNECTION PROTECTION INSPECTION REQUIRED. THE BACKFLOW DEVICE TO BE TESTED UPON THE ORIGINAL INSTALLATION. THE TESTING TO BE PERFORMED BY A PERSON HOLDING A CURRENT CERTIFICATE AS A BACKFLOW TESTER. THE TEST REPORT TO BE SUBMITTED TO THE LOCAL WATER DISTRICT, OR PURVEYOR, AND OWNER WITH A COPY TO BARGHAUSEN CONSULTING ENGINEERS, INC. CONTRACTOR TO INCLUDE TESTING IN THE SCOPE OF WORK. OWNER IS RESPONSIBLE FOR ANNUAL INSPECTIONS AFTER THE INTIAL INSPECTION.
- CONTRACTOR TO PROVIDE SYSTEM WINTERIZATION/SPRING SERVICE WHEN INSTALLATION HAS BEEN COMPLETED WITHIN 90 DAYS OF NOVEMBER 1 FOR WINTERIZATION, OR MAY 15 FOR SPRING SERVICE. SERVICE TO BE PERFORMED AS NEAR AS PRACTICAL TO THE ABOVE DATES, OR AS FREEZE/PRECIPITATION CONDITIONS DETERMINE SERVICE
- IRRIGATION SCHEDULING:
 - THE IRRIGATION CONTROLLER CONTAINS A WATER BUDGET FEATURE. PERIODIC (WEEKLY) ADJUSTMENT OF THE WATER SCHEDULE IS INTENDED TO BE MADE VIA BUDGET ADJUSTMENT. RE-ADJUST WATERING DAYS AT 100 PERCENT BUDGET WHEN ADJUSTMENT EXCEEDS 30%. SET CONTROLLER FOR HIGHEST ETO WATER SCHEDULE, BASED ON PUBLISHED LOCAL EVAPOTRANSPIRATION DATA. SYSTEM HAS BEEN DESIGNED FOR 50 TO 80 PERCENT DISTRIBUTION UNIFORMITY. LAWN ZONES SHOULD BE SCHEDULED FOR 100 PERCENT REPLACEMENT FACTOR ON A TYPICAL MINIMUM 3-DAY CYCLE. SHRUB ZONES SHOULD BE PROGRAMMED AT 40 TO 70 PERCENT OF THE MONTHLY LAWN WATER REQUIREMENT ON A ONCE PER WEEK CYCLE. ALL WATERING IN EXCESS OF THE LOCAL ETO ("FIELD RECHARGE") TO BE COMPLETED DURING THE CONSTRUCTION PHASE WHILE THE CONTRACTOR IS ON THE JOB SITE. OVER WATERING OF LANDSCAPE DUE TO CONTROLLER SCHEDULING TO BE GROUNDS FOR CONTRACTOR TO REPAIR ANY RESULTANT DAMAGES AT CONTRACTOR'S OWN EXPENSE
- SUBSTITUTION OF IRRIGATION MATERIAL/EQUIPMENT TO BE MADE ONLY UPON WRITTEN APPROVAL OF OWNER'S REPRESENTATIVE.
- 23. ALL ZONES TO PASS A MINIMUM DISTRIBUTION UNIFORMITY OF 62 PERCENT. AS TESTED THROUGH AN IRRIGATION ASSOCIATION CERTIFIED WATER AUDIT.
- CLEANUP AND PROTECTION: DURING IRRIGATION WORK, KEEP ALL PAVEMENT CLEAN AND WORK AREAS IN AN ORDERLY CONDITION. PROTECT IRRIGATION WORK AND MATERIALS FROM DAMAGE DUE TO LANDSCAPE AND IRRIGATION OPERATIONS AND TRESPASSERS. MAINTAIN PROTECTION DURING INSTALLATION AND MAINTENANCE PERIOD. TREAT, REPAIR, OR REPLACE DAMAGE LANDSCAPE AND IRRIGATION WORK AS DIRECTED BY THE OWNER.

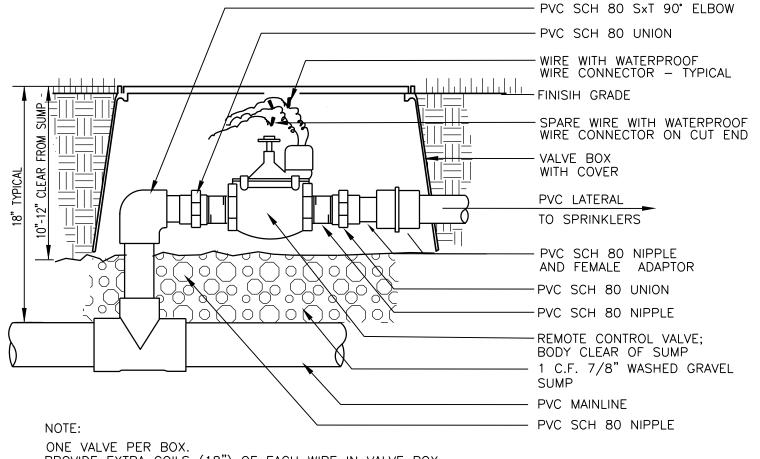

PROVIDE EXTRA COILS (18") OF EACH WIRE IN VALVE BOX. COMPACT SOIL AROUND VALVE BOX. USE TEFLON OR FLOWABLE SEALANT IN ALL THREADED FITTINGS, PER


REMOTE CONTROL VALVE ASSEMBLY

NOT TO SCALE

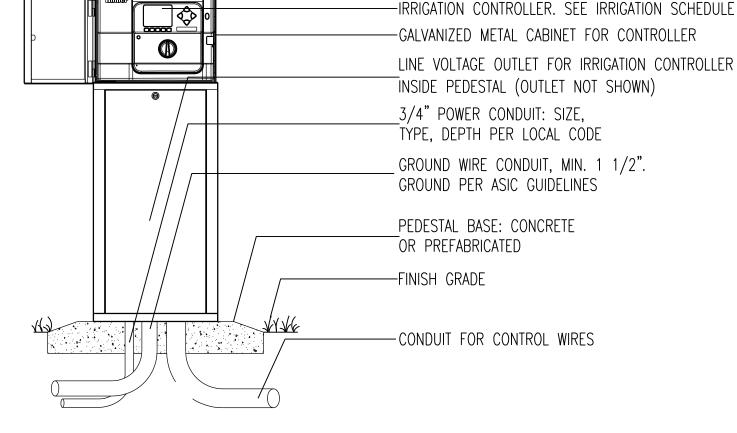

IRRIGATION CONTROLLER - PEDESTAL MOUNT


NOT TO SCALE

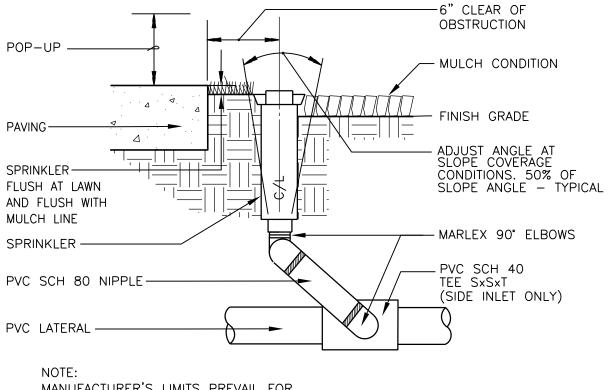

MANUFACTURER'S LIMITS PREVAIL FOR INSTALLATION AND ADJUSTMENTS. PROVIDE SWING JOINT RISERS AT WALKS AND CURBS. 24" FLEXIBLE RISERS ACCEPTABLE ELSEWHERE.


POP-UP RISER ASSEMBLY

NOT TO SCALE

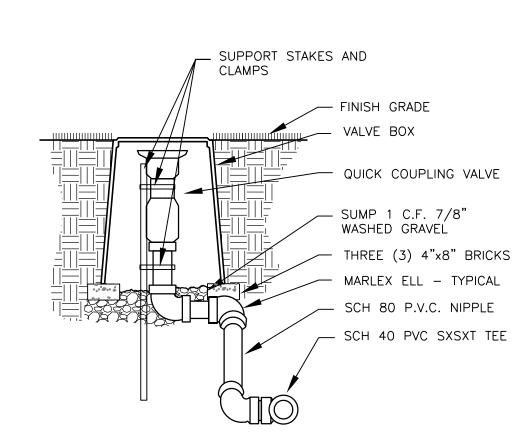

QUICK COUPLING VALVE DETAIL

NOT TO SCALE

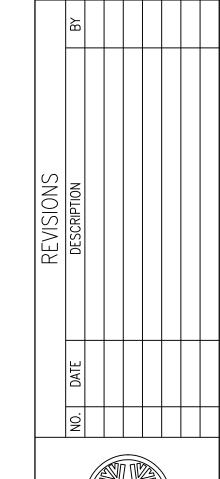



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JOB NUMBER: DRAWING NAME: DESIGNER: DRAFTING BY 11.17.22 AS SHOWN

SHEET 4 of 4

JURISDICTION: MARYSVILLE