




PLANTING PLAN
 1" = 30'-0" (CHECK SCALE BAR FOR ACCURACY)

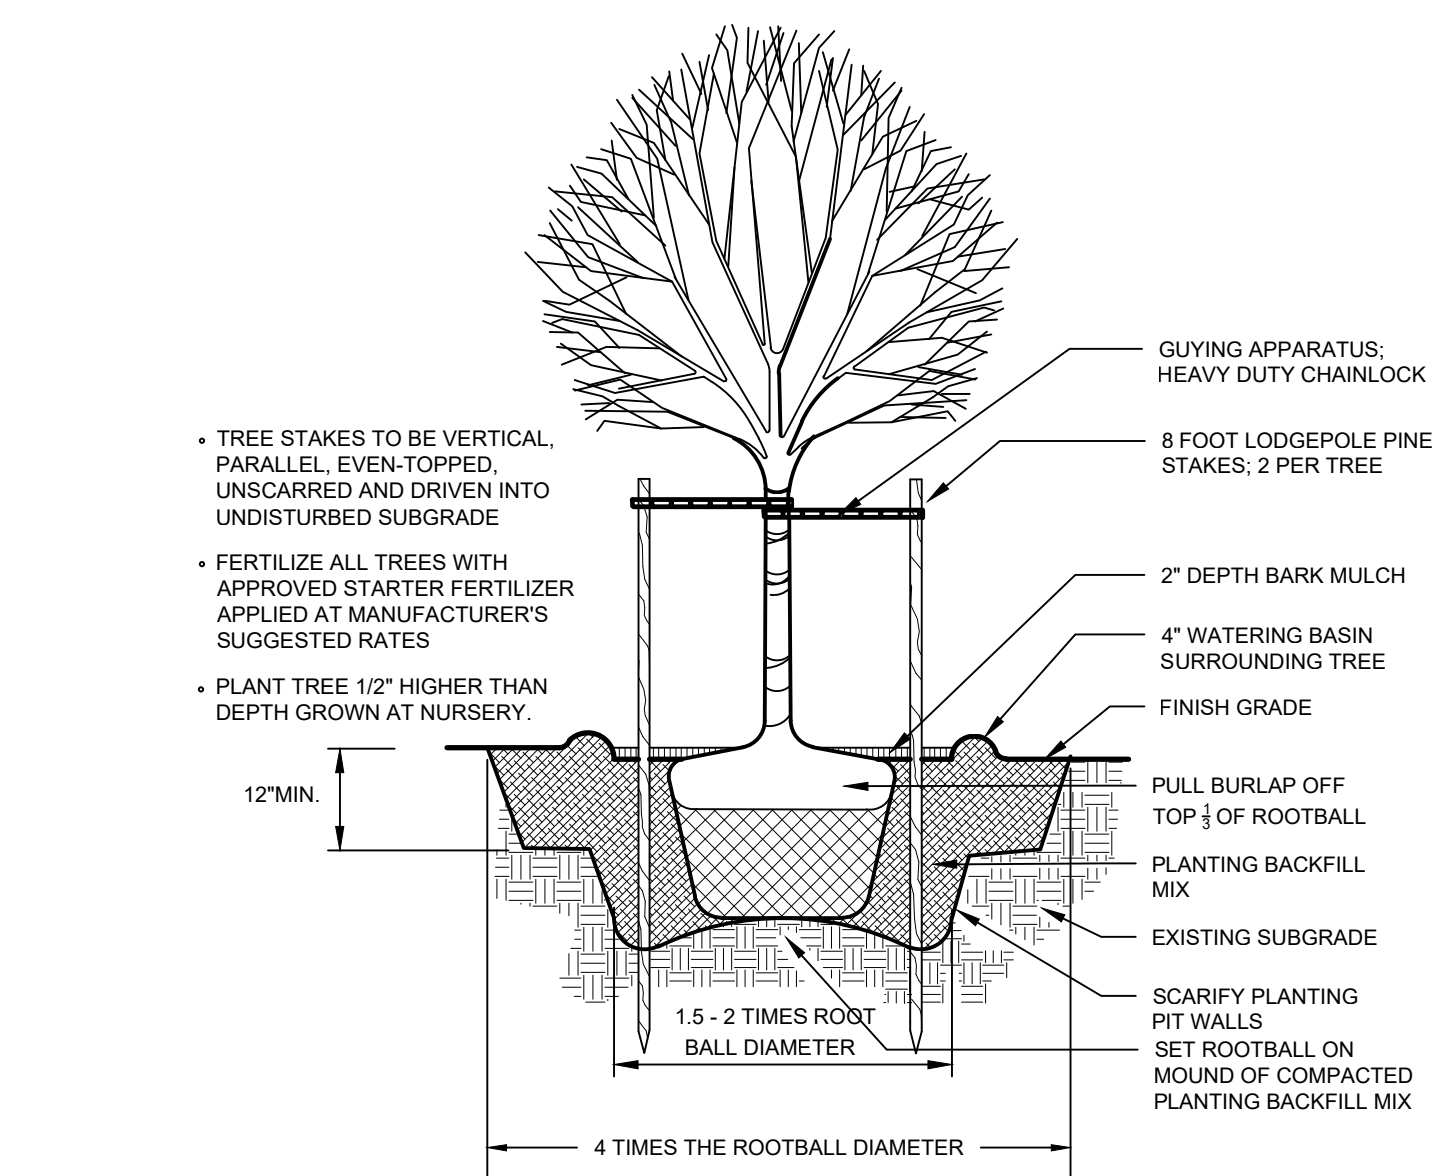

1 | TYPICAL PLANTING DETAILS
 L-1 | NO SCALE

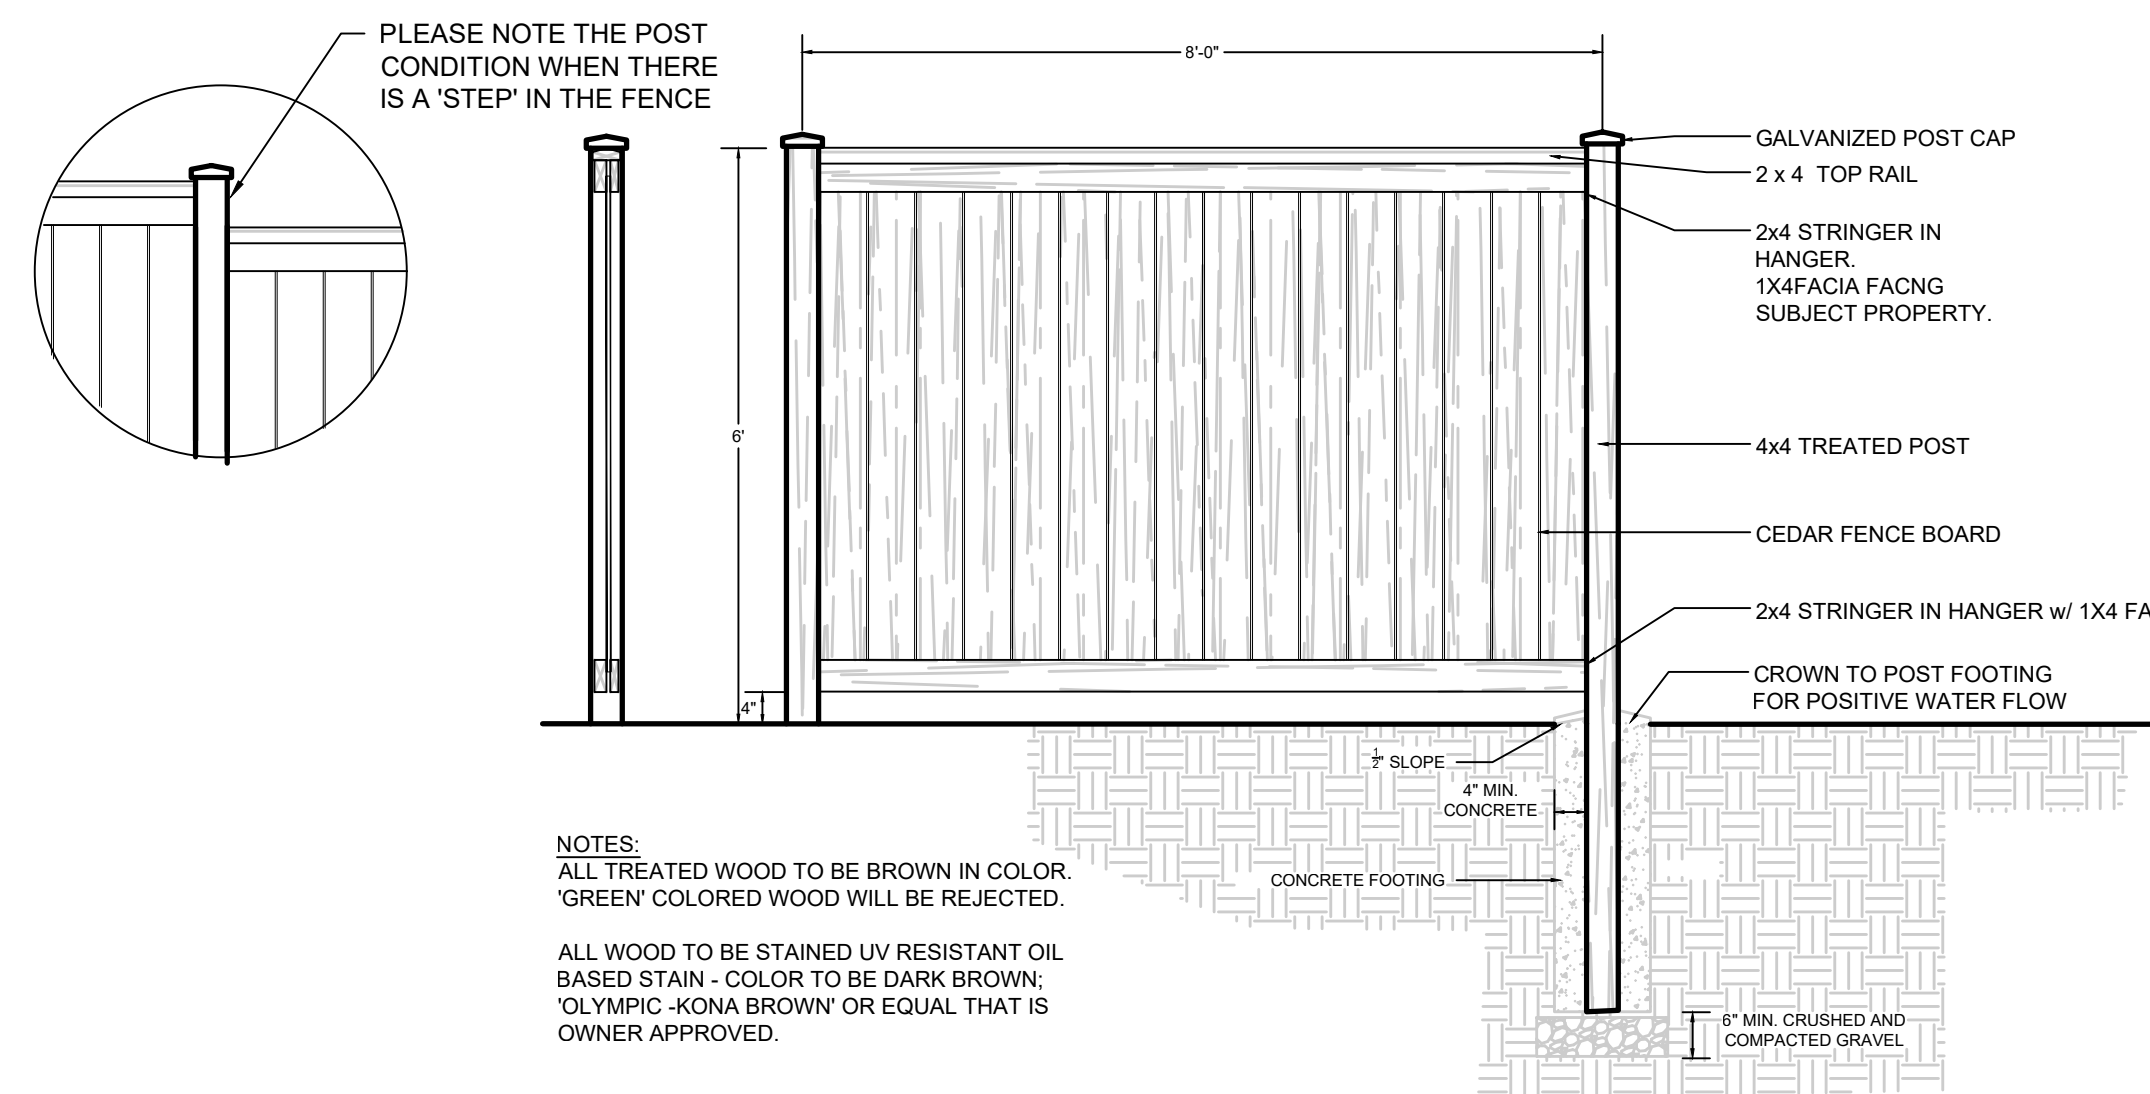

2 | SCREENING FENCE DETAIL
 L-1 | NO SCALE

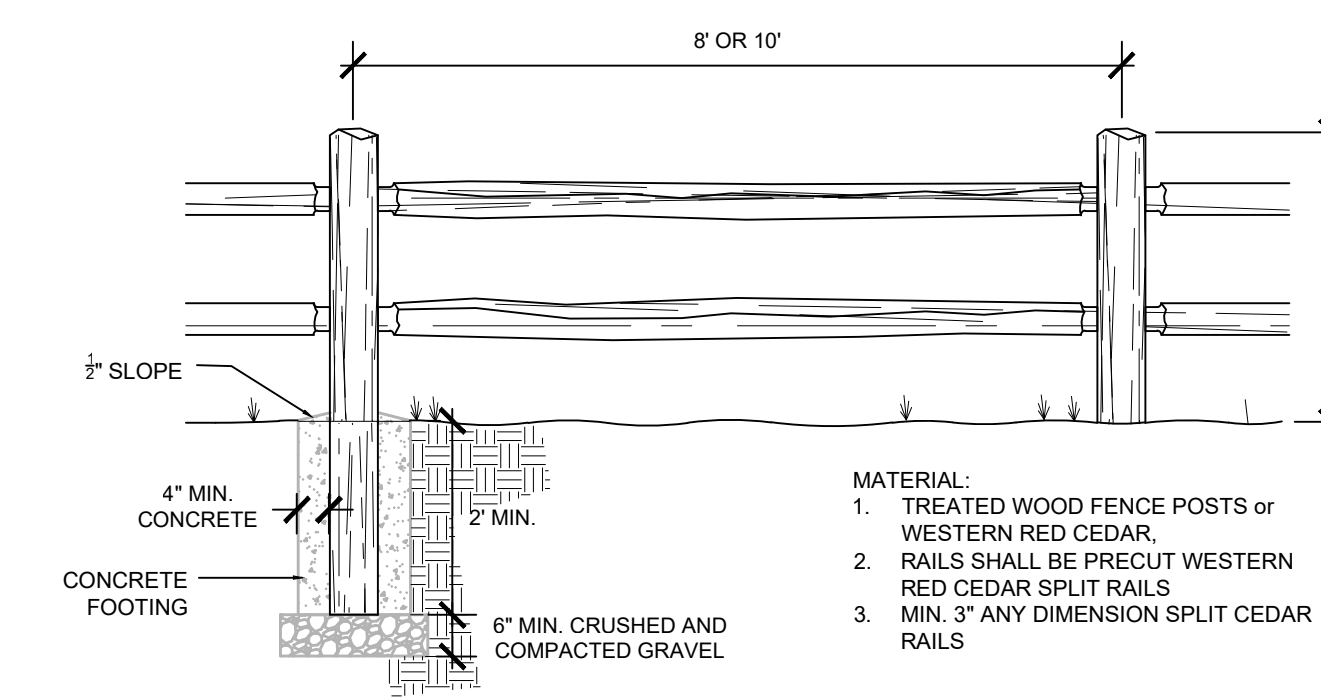

3 | SPLIT RAIL FENCE DETAIL
 L-1 | NO SCALE

PLANT SCHEDULE

TREES	CODE	BOTANICAL NAME	COMMON NAME	SIZE
	AME GRA	Amelanchier x grandiflora 'Autumn Brilliance'	Autumn Brilliance Serviceberry	2' Cal
	CAR NFL	Carpinus caroliniana 'JFS-KW6' TM	Native Flame American Hornbeam	2' Cal
SHRUBS	CODE	BOTANICAL NAME	COMMON NAME	SIZE
		EXISTING ARBORVITAE HEDGE		
	POT DRO	Potentilla fruticosa 'Gold Drop'	Gold Drop Bush Cinquefoil	2 gal.
	PIN IPE	Pinus mugo 'Mitsch Mini'	Mitsch Mini Mugo Pine	2 gal.
	ILE GGI	Ilex glabra	'Gem Box' Inkberry Holly	2 gal.
SOD/SEED	CODE	BOTANICAL NAME	COMMON NAME	SIZE
	GRA MLL	Grass Erosion Control Mix Locally Proven	Pond Mix	seed
	GRA SEL	Grass Sod Locally Proven	Turf	sod

REFERENCE NOTES SCHEDULE

SYMBOL	PLANTING ACCESSORIES DESCRIPTION	HEIGHT	MATERIAL	COLOR
	ROOT BARRIER - 24" deep per cmv details			
	WOOD SCREENING FENCE (field verify quantity)	6	CEDAR	DARK BROWN
	SPLIT RAIL FENCE. Hold back 2 feet from edge of paving	36	CEDAR	Natural

GENERAL NOTES

- ALL WORK SHALL BE PERFORMED BY PERSONS FAMILIAR WITH THIS KIND OF WORK AND UNDER THE SUPERVISION OF A QUALIFIED FOREMAN.
- ALL PLANT MATERIAL SIZES AND QUALITY TO CONFORM TO AMERICAN ASSOC. OF NURSERYMEN, AMERICAN STANDARD FOR NURSERY STOCK, MOST RECENT PUBLISHED.
- PLANT LOCATIONS ON THE PLANS ARE DIAGRAMMATIC AND MAY BE SUBJECT TO ADJUSTMENT IN THE FIELD BY THE LANDSCAPE CONTRACTOR.
- ALL PLANT MATERIAL SHALL BE OF NURSERY STOCK AND SHALL BE OF THE TYPE, SIZE AND CONDITION SPECIFIED. THE PLANT MATERIAL SHALL EXHIBIT NORMAL HABITS OF GROWTH FOR THE SPECIES. SHALL HAVE BUDS INTACT AND SHALL BE FREE OF DISEASE, INSECTS, SCARS, BRUISES, BREAKS, SEED AND WEED ROOTS.
- SEE NOTES THIS SHEET FOR TOPSOIL DEPTH AND SPECIFICATION.
- SEE SPEC THIS SHEET FOR BIORETENTION SOIL MIX. BIORETENTION SOIL MIX TO BE PLACED AT A MINIMUM DEPTH OF 12" IN THE BOTTOM OF THE BIORETENTION.
- MEDIUM BARK MULCH IS TO BE INSTALLED AT ALL NEW PLANTING AREAS WITH A MINIMUM OF 2 INCHES.
- ALL LANDSCAPE AREAS SHALL HAVE PLANTING BACKFILL AMENDED WITH A TRANSPANT AMENDMENT (SUPERTHRIVE OR EQUAL) AND WETTING AGENT (TERAWET OR EQUAL) APPLIED AT MANUFACTURES RECOMMENDED RATE.
- LANDSCAPE CONTRACTOR SHALL VERIFY LOCATION OF ALL SITE UTILITIES PRIOR TO LANDSCAPE IMPLEMENTATION. PLANT LOCATIONS MAY BE ADJUSTED TO AVOID CONFLICT.
- LANDSCAPE CONTRACTOR SHALL TAKE NECESSARY PRECAUTIONS TO PROTECT EXISTING SITE IMPROVEMENTS, PAVING, WALLS, AND UNDERGROUND UTILITIES. DAMAGE SHALL BE REPAIRED TO THE OWNER'S SATISFACTION AND AT NO ADDITIONAL COST.
- PLANT COUNT IS FOR THE CONTRACTOR'S CONVENIENCE; IF THERE IS A DISCREPANCY, THE PLAN SHALL GOVERN. ACTUAL PLANT QUANTITIES TO BE DETERMINED BY REQUIRED PLANT SPACING.
- ALL AREAS TO BE PLANTED WITH GROUNDCOVER ARE INDICATED ON THE PLAN WITH A HATCH PATTERN. SEE PLANT LIST FOR PLANT TYPE, SIZE, AND SPACING.
- SUBSTITUTION OF PLANT VARIETIES DUE TO LACK OF AVAILABILITY SUBJECT TO APPROVAL BY THE OWNERS REPRESENTATIVE AND CITY.
- ALL DIMENSIONS ARE ASSUMED TO BE PARALLEL OR PERPENDICULAR UNLESS OTHERWISE NOTED.
- ALL SOIL GRADES TO BE A MINIMUM SIX INCHES BELOW ADJACENT FINISH FLOOR ELEVATIONS UNLESS NOTED OTHERWISE. ALL GRADES ADJACENT TO A BUILDING SHALL HAVE A MAXIMUM SLOPE OF 5% 3' FROM FOUNDATION.
- ALL GRADES, DIMENSIONS AND EXISTING CONDITIONS SHALL BE VERIFIED BY THE CONTRACTOR PRIOR TO CONSTRUCTION. ANY DISCREPANCIES SHALL BE BROUGHT TO THE ATTENTION OF THE LANDSCAPE ARCHITECT.
- SUPPLEMENTAL HAND WATERING WILL BE DONE DURING FIRST TWO YEARS TO GUARANTEE PLANT ESTABLISHMENT. IF CITY REQUIRES AUTOMATED IRRIGATION SYSTEM THEN SYSTEM WILL BE PROVIDED.
- BASEMAP PROVIDED BY SOUND DEVELOPMENT, MOUNT VERNON, WA

SCREENING NOTES

- UTILITY METERS, ELECTRICAL CONDUIT, NO OTHER SERVICE UTILITY APPARATUS SHALL BE LOCATED AND/OR DESIGNED TO MINIMIZE THEIR VISIBILITY TO THE PUBLIC.
- IF SUCH ELEMENTS ARE MOUNTED IN A LOCATION VISIBLE FROM THE STREET OR PEDESTRIAN PATHWAY THEY SHALL BE SCREENED WITH VEGETATION OR BY ARCHITECTURAL FEATURES.

NO.	DATE	REVISION	BY	REV.
1	1.3.23	prelim permit set	pd	pd
2	1.12.23	revised buffer line	pd	pd

prepared for:
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STATE OF WASHINGTON REGISTERED LANDSCAPE ARCHITECT
PATRIK DYLAN
 CERTIFICATE NO. 793

Gamlam 12 lot Plat
 Marysville, WA

SCALES:
 HORIZONTAL : 1" = 30'
 VERTICAL : N/A
 DESIGNED: PD
 DRAWN: PD
 CHECKED: PD

one inch
 0 20 40 60 80
PRELIM PLANTING PLAN

ISSUE DATE: 1.12.2023
 DRAWING: 2231 site
 JOB NO.: 2231
 SHEET: L-1

